

1. CONTRACTOR IS REQUIRED TO VISIT SITE AND FAMILIARIZE HIM/HERSELF WITH THE PROJECT PRIOR TO BIDDING

SIGNAGE:

YOAKUM STREET (LOCAL STREET):
FREESTANDING SIGNAGE SHALL BE LIMITED TO ONE SIGN A MAXIMUM OF 100 SF IN AREA AND A
MAXIMUM OF 12 LF IN HEIGHT (LIMITED BY STREET CLASSIFICATION).

WALL-SIGNAGE:

YOAKUM STREET FRONTAGE: TOTAL ALLOWABLE SQUARE FOOTAGE OF WALL SIGNAGE SHALL BE LIMITED TO 135 SF (2.25 SF * 60 LF FRONTAGE)...

A VALID ESCAMBIA COUNTY SIGN PERMIT MUST BE OBTAINED PRIOR TO ERECTING, CONSTRUCTING, ALTERING OR RELOCATING ANY SITE SIGNAGE. FOR SIGNS PLACED ON A CORNER, THE SIDE SETBACK WILL BE DETERMINED BY MEASURING 35' ALONG THE INTERSECTIONS OF THE TWO PUBLIC RIGHTS OF WAY.

ESCAMBIA COUNTY DEVELOPMENT SERVICES
3363 WEST PARK PLACE
PENSACOLA, FL 32505
PHONE NO.: (850)-595-3475
FAX NO.: (850)-595-3481

EMERALD COAST UTILITIES AUTHORITY
9255 STURDEVANT STREET
PENSACOLA, FL 32514
PHONE NO.: (850)-476-5110
FAX NO.: 850-494-7346

NORTHWEST FLORIDA WATER MANAGEMENT DISTRICT
700 US HIGHWAY 331 SOUTH
DEFUNIAK SPRINGS, FL 32435
PHONE NO.: (850)-951-4660
FAX NO.: (850)-892-8007

FLORIDA DEPARTMENT OF ENVIRONMENTAL PROTECTION
2600 BLAIR STONE ROAD
TALLAHASSEE, FL 32399
PHONE NO.: (866)-336-6312
FAX NO.: (850)-297-1211

CIVIL ENGINEER

CIVIL ENGINEER
HAMMOND ENGINEERING, INC.
3802 NORTH 'S' ST.
PENSACOLA, FL 32505
PHONE NO.: (850)-434-2603
FAX NO.: (850)-434-2650

SURVEYOR
MERRILL PARKER SHAW, INC.
4928 N. DAVIS HWY.
PENSACOLA, FL 32501
PHONE NO.: (850)-478-4923
FAX NO.: (850)-478-4924

NO.	DATE	REVISIONS
△	11/06/20	REVISED PLANS AS PER ESAMBIA COUNTY DRC REVIEW COMMENTS


SHEET C1



○ ~ 1/2" IRON ROD IN 3" PVC WITH CONCRETE, UNNUMBERED (FOUND)
 ○ ~ 1/2" PLAIN IRON ROD, UNNUMBERED (FOUND)
 ○ ~ 1/2" CAPPED IRON ROD, NUMBER 3578 (FOUND)
 ○ ~ 1/2" CAPPED IRON ROD, NUMBER 7612 (FOUND)
 ○ ~ 1/2" CAPPED IRON ROD, ILLEGIBLE (FOUND)
 ⊗ ~ 1/2" RED-CAPPED IRON ROD, NUMBER 7174 (SET)

P.C. ~ POINT OF CURVATURE
P.T. ~ POINT OF TANGENCY
P.R.M. ~ PERMANENT REFERENCE MONUMENT
R/W ~ RIGHT OF WAY
B.S.L. ~ BUILDING SETBACK LINE
() ~ FIELD INFORMATION
(D) ~ DEED / INFORMATION
--- \\ --- ~ 6" WOOD PRIVACY FENCE
--- z --- ~ 4" CHAINLINK FENCE
--- = --- ~ OVERHEAD ELECTRICAL LINE
UTILITY POLE
GUY ANCHOR
X ~ LIGHT POLE
~ TREE
~ SPOT ELEVATION
82 ~ CONTOUR LINE
~ BENCHMARK IN VICINITY

- 1) THE NORTH ARROW AND BEARINGS AS SHOWN HEREON ARE REFERENCED TO THE ASSUMED BEARING OF THE NORTH 00 DEGREES 00 MINUTES 00 SECONDS EAST ALONG THE WEST LINE OF LOT 18, BLOCK 21, BRENTWOOD SUBDIVISION, CITY OF MIAMI, Dade County, Florida.
- 2) SOURCE OF INFORMATION: THE PUBLIC RECORDS OF ESCAMBIA COUNTY, FLORIDA; AND EXISTING FIELD MONUMENTATION.
- 3) NO TITLE SEARCH WAS PERFORMED BY OR FURNISHED TO MERRILL PARKER SHAW, INC. FOR THE SUBJECT PROPERTY. THERE MAY BE DEEDS OF RECORD, UNRECORDED DEEDS, RIGHT-OF-WAYS, EASEMENTS, BUILDING EASEMENTS, EASEMENTS OF EMINENT DOMAIN, EASEMENTS, EASEMENTS, EASEMENTS OR OTHER INSTRUMENTS WHICH COULD AFFECT THE BOUNDARIES AND/OR USE OF THE SUBJECT PROPERTY.
- 4) ONLY THE ABOVE GROUND VISIBLE ENCROACHMENTS AND IMPROVEMENTS WERE FIELD LOCATED AS SHOWN HEREON, UNLESS OTHERWISE NOTED. UNDERGROUND ENCROACHMENTS AND IMPROVEMENTS, IF ANY, WERE NOT FIELD LOCATED AND WERE NOT INDICATED ON THIS PLAN.
- 5) THE DIMENSIONS OF THE BUILDINGS (IF ANY) AS SHOWN HEREON ARE ALONG THE OUTSIDE FACE OF THE BUILDINGS AND DO NOT INCLUDE THE EAVES OVERHANG OR THE FOOTINGS OF THE FOUNDATIONS.
- 6) THE SURVEY AS SHOWN HEREON DOES NOT DETERMINE OWNERSHIP.
- 7) THE MEASUREMENTS MADE IN THE FIELD, INDICATED THUSLY (F), AS SHOWN HEREON WERE MADE IN ACCORDANCE WITH UNITED STATES STANDARDS.
- 8) FEDERAL AND STATE COPYRIGHT ACTS PROTECT THIS MAP FROM UNAUTHORIZED USE. THIS MAP IS NOT TO BE COPIED OR REPRODUCED IN WHOLE OR PART AND IS NOT TO BE USED FOR ANY OTHER TRANSACTION. THIS DRAWING CANNOT BE USED FOR THE BENEFIT OF ANY OTHER PERSON, COMPANY OR FIRM WITHOUT THE WRITTEN CONSENT OF THE COPYRIGHT OWNER AND IS TO BE RETURNED UPON REQUEST.
- 9) THE CONTOUR LINES AS SHOWN HEREON ARE AT 1 FOOT INTERVALS OF ELEVATION.
- 10) THE ELEVATIONS AS SHOWN HEREON ARE REFERENCED TO NORTH AMERICAN VERTICAL DATUM OF 1988, USING THE FLORIDA DEPARTMENT OF TRANSPORTATION G.P.S. NETWORK.

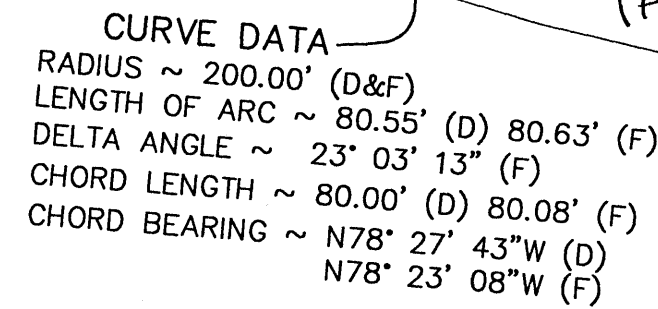

— CURVE DATA
RADIUS ~ 50.00' (D&F)
LENGTH OF ARC ~ 45.93' (D) 43.99' (F)
DELTA ANGLE ~ 50° 24' 25" (F)
CHORD LENGTH ~ 44.33' (D) 42.59' (F)
CHORD BEARING ~ N63° 32' 34"W (D)
N64° 29' 20"W (F)

LOTS 17 & 18, BLOCK 21, "BRENTWOOD PARK" SUBDIVISION
AND ALSO:


Beginning at the Northeast Corner of, Lot 19 1/2 Block 21 of Brentwood Park Subdivision, a subdivision of a portion of, Sections 46 & 47 Township 1 south, Range 30 West 1 Escambia County, Florida as recorded in Plat Book 18 at Pages 11A through 11D; thence S.00°00'00"E. for 149.84'; to a 1/2" iron rod on the North R/W line of Yoakum Court (said point being on a curve having a radius of 200.00', a chord bearing of N.78°27'43"W. with a chord distance of 80.00'); thence northwesterly along the arc of said curve for a length of 80.55'; to a 1/2" capped iron rod #3578; thence N.03°37'07"E. for 138.08'; to a 1/2" capped iron rod #3578; thence N.62°41'17"E. for 33.88'; to a 1/2" capped iron rod #3578 (said point being on a curve having a radius of 50.00', a chord bearing of S.63°32'34"E. with a chord distance of 44.33'); thence southeasterly along the arc of said curve for a length of 45.93' to the point of beginning.

4928 N. DAVIS HWY
PENSACOLA, FL 32503

4928 N. DAVIS HWY
PENSACOLA, FL 32503



DRAWN BY: CJB	SITE DEVELOPMENT
DESIGNED BY: RLB	PLANS FOR
CHECKED BY: TGH	FRONTIER MOTORS
DATE: 9-5-20	PRIVATE STORAGE
SCALE: AS SHOWN	EXISTING CONDITIONS
NOT RELEASED FOR CONSTRUCTION	
BY:	ESCAMBIA COUNTY FLORIDA
DATE:	



11/15/2023


HAMMOND ENGINEERING, INC.
 FLORIDA AUTHORIZATION NO. 9130
 ALABAMA AUTHORIZATION NO. 3277
 3802 NORTH S STREET
 PENSACOLA, FLORIDA 32505
 850 434-2603
 FAX 850-434-2650
 TOM@SELANDDESIGN.COM

NO. DATE REVISIONS

△ 11/10/2020 REVISED PLANS AS PER ESCAMBIA COUNTY DRC REVIEW COMMENTS

PROJECT NO: 20-035

SHEET: **C2**

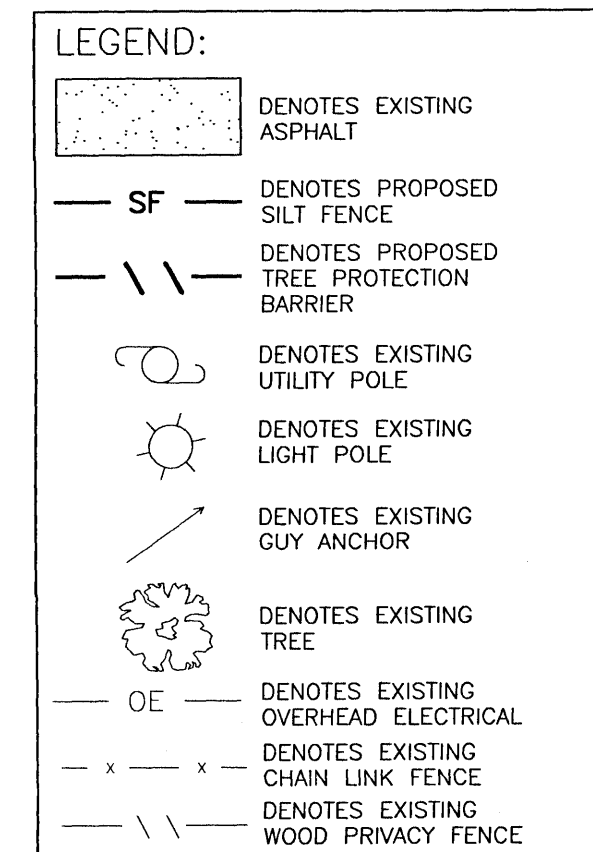

Know what's below
Call before you dig

TREE ID/REMOVAL TABLE			
TREE #	TYPE	SIZE (DBH)	REASON FOR REMOVAL
1	CEDAR	30"	N/A
2	PECAN	12"	N/A
4	PECAN	24"	N/A
5	OAK	44"	N/A

DEMOLITION/EROSION CONTROL NOTES

- # DEMOLITION/EROSION CONTROL BMP'S
1. WHERE ASPHALT/CONCRETE TO BE REMOVED EXTENDS PAST PROPERTY LINE, CONTRACTOR TO ADJUST THE PROPOSED EROSION CONTROL PROPERTY OWNER TO ASSURE HE/SHE DESIRES MISCELLANEOUS IMPERVIOUS SURFACE TO BE REMOVED.
 2. WHERE EXISTING ASPHALT/CONCRETE IS BEING REMOVED ON PROPERTY LINE, REMOVAL SHALL BEGIN AT THE PROPERTY LINE AND WORK TOWARDS THE INTERIOR OF THE PROPERTY. INITIALLY, A 3" STRIP OF EXISTING ASPHALT/CONC. SHALL BE REMOVED NEXT TO THE PROPERTY LINE TO ALLOW FOR INSTALLATION OF PROPOSED EROSION CONTROL BMP'S.
 3. IT IS UNDERSTOOD THAT WHERE SILT FENCING IS IMPLEMENTED ON EXISTING ASPHALT/CONC. THAT THE EXISTING ASPHALT/CONC. SHALL BE REMOVED IN THAT IMMEDIATE AREA PRIOR TO INSTALLATION OF BMP.
 4. THE EROSION AND SEDIMENT CONTROL RULES ARE PERFORMANCE ORIENTED. THAT IS, THE MEASURES USED AT A CONSTRUCTION SITE MUST BE EFFECTIVE IN CONTROLLING EROSION AND PREVENTING OFF- SITE SEDIMENTATION. THE MEASURES TO BE USED TO BE IN COMPLIANCE FOLLOWING AN APPROVED PLAN AND APPROVED PLAN THE CONTROL MEASURES MAY NOT BE ENOUGH FOR A SITE TO BE IN COMPLIANCE WITH THE RULES. IF EROSION AND OFF-SITE SEDIMENTATION OCCUR, THE CONTRACTOR WILL BE RESPONSIBLE FOR INSTALLING ADDITIONAL MEASURES TO CORRECT ANY PROBLEM ASSOCIATED WITH THE NPDES PERMIT OR ANY OTHER PERMIT REQUIRED FOR THE SITE CONSTRUCTION. THE CONTRACTOR WILL ALSO BE COMPLETELY RESPONSIBLE FOR ANY FINES LEVIED BY ANY GOVERNING AGENCY ON THE PROJECT DURING CONSTRUCTION.
 5. EROSION CONTROL MEASURES SHOWN ARE MINIMUM REQUIREMENTS ONLY. CONTRACTOR SHALL REINFORCE AND/OR ADD ADDITIONAL MEASURES AS CONDITIONS WARRANT AND/OR AS DIRECTED BY THE PROPER REGULATORY AUTHORITIES.
 6. ON SITES > 1 ACRE, IF > 1 CONTIGUOUS ACRE IS DECLARED, A GROUND COVER SUFFICIENT TO PREVENT EROSION SHOULD BE PLANTED OR OTHERWISE STABILIZED UNTIL WORKING DAYS FOR THE PORTION OF THE SITE UPON WHICH FURTHER ACTIVE CONSTRUCTION WILL NOT BE UNDERTAKEN WITHIN 90 DAYS.
 7. TO COMPLY WITH NPDES REQUIREMENTS, EROSION CONTROL MEASURES SHALL BE INSPECTED AFTER EACH 1/2" RAINFALL EVENT OR AT LEAST WEEKLY. THE CONTRACTOR SHALL DOCUMENT SUCH INSPECTIONS AND EROSION CONTROL MAINTENANCE EFFORTS; INSPECTION RECORDS SHALL BE PROVIDED TO THE NPDES PERMIT APPLICANT FOR PROPER REPORTING TO DEEP.
 8. TREE PROTECTION BARRICADES SHALL BE INSTALLED PRIOR TO ANY SITE DISTURBANCE AND EARTH MOVING IMPACTS (I.E. ROOT RAKING, TRENCHING, GRADING, ETC.) SHOULD TAKE PLACE OUTSIDE OF THE PROTECTED AREAS.
 9. PROTECTED TREES SHALL REMAIN ONSITE, AND ANY PROPOSED LAND CLEARING/LAND DISTURBANCE INCLUDING THE PLACEMENT OF FILL/FILL MATERIALS, GRADING, EXCAVATING, ETC. SHALL NOT OCCUR UNTIL SUCH TIME AS APPROPRIATE PERMIT(S) ARE ISSUED FOR SUCH SITE WORK.

DENOTES LIMITS OF
PROPOSED
STORMWATER BASIN

EXISTING
LIGHT POLE
TO BE RELOCATED
ONSITE

DENOTES LIMITS OF-
PROPOSED BUILDING

— DENOTES LIMITS OF PROPOSED IMPROVEMENTS

DENOTES LIMITS OF
PROPOSED
STORMWATER BASIN

CONSTRUCT _____
TEMPORARY ROCK
CONSTRUCTION ENTRANCE
SEE DETAIL SHT C8

DENOTES LIMITS OF
 PROPOSED
 STORMWATER BASIN

INSTALL 490 LF±
TYPE III SILT FENCE
SEE DETAIL SHT C8

PROTECT
EXISTING UTILITY POLE
& GUY WIRE

(P)YOAKUM COURT ~ (F)YOAKUM STREET
(50' PUBLIC R/W)

INSTALL PRIOR TO COMMENCEMENT OF ANY SITE WORK ACTIVITIES, AND MAINTAIN IN GOOD WORKING ORDER, TREE PROTECTION BARRIERS AROUND EXISTING TREES TO REMAIN WITHIN THE LIMITS OF CONSTRUCTION. THE TREE PROTECTION BARRIER SHALL BE INSTALLED ALONG THE OUTER LIMITS OF THE TREE'S CRITICAL ROOT ZONE WHICH IS REPRESENTED BY A CIRCLE, CENTERED ON THE TREE TRUNK AND HAVING A RADIUS OF ONE FOOT FOR EACH ONE INCH OF TRUNK DIAMETER (DBH).
SEE DETAIL SHT C8

— DENOTES PROTECTED
TREE CRITICAL ROOT
ZONE-TYP.

✓ DENOTES PROTECTED
TREE STRUCTURAL
ROOT PLATE-TYP.


HAMMOND ENGINEERING, INC. FLORIDA AUTHORIZATION NO. 9130 ALABAMA AUTHORIZATION NO. 3277 3802 NORTH "S" STREET PENSACOLA, FLORIDA 32505 850 434-2603 FAX 850-434-2650 TOM@SELANDDESIGN.COM		NO. <input type="text"/> DATE <input type="text"/> 111/06/2020 REVISED PLANS AS PER ESCAMBA COUNTY DRC REVIEW COMMENTS REVISIONS
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SITE DEVELOPMENT
PLANS FOR
FRONTIER MOTORS
PRIVATE STORAGE
DEMOLITION & EROSION
CONTROL PLAN

DRAWN BY: CJG	DATE:
DESIGNED BY: RLS	SCALE: AS SHOWN
CHECKED BY: TGH	NOT RELEASED FOR CONSTRUCTION
DATE: 9-3-20	BY: DATE:

PROJECT NO: 20-035

SHEET: C3

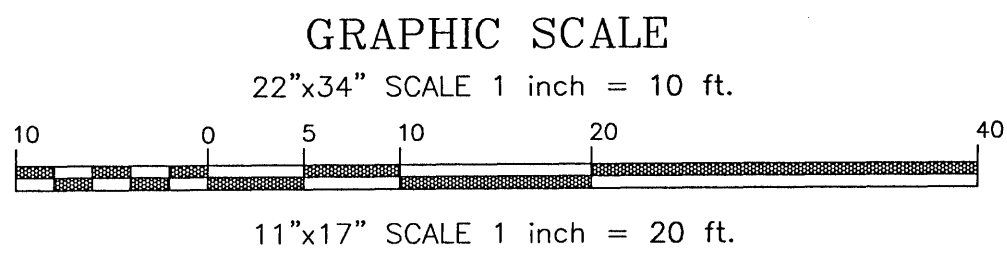

LEGEND:

- DENOTES EXISTING ASPHALT
- DENOTES PROPOSED GRAVEL
- DENOTES PROPOSED CONCRETE
- DENOTES EXISTING UTILITY POLE
- DENOTES EXISTING LIGHT POLE
- DENOTES EXISTING GUY ANCHOR
- DENOTES EXISTING TREE
- OE DENOTES EXISTING OVERHEAD ELECTRICAL
- X DENOTES EXISTING CHAIN LINK FENCE
- \\ DENOTES EXISTING WOOD PRIVACY FENCE
- X DENOTES PROPOSED TIMBER PRIVACY FENCE

PROTECTED TREE NOTE:
1. PROTECTED TREES SHALL REMAIN ONSITE AND ANY PROPOSED LAND CLEARING/LAND DISTURBING ACTIVITIES, INCLUDING THE PLACEMENT OF FILL/FILL MATERIALS, GRADING, EXCAVATING, ETC. SHALL NOT OCCUR UNTIL SUCH TIME AS APPROPRIATE PERMIT(S) ARE ISSUED FOR SUCH SITE WORK.

46-1S-30-2001-020-021
TESTON DONALD L &
TESTON TAMARA K
1125 HARBOR LANE
GULF BREEZE, FL 32563
ZONING: HC/LI
FLU: MU-U
USE: MOBILE HOME

PARKING CALCULATIONS:
3,600 SF PRIVATE STORAGE
AS PER 3-1.2 ESCAMBIA COUNTY DESIGN STANDARDS MANUAL:
1.5 PER 100 UNITS + 2 REQUIRED
(1.5/100*9)+2 ~ 3 STALLS REQUIRED
GIVEN THAT THE USE IS SELF-STORAGE IN CHARACTER
BUT NOT THE TYPICAL MULTI-UNIT FACILITY ANTICIPATED
BY THE CODE, NO PARKING STALLS PROPOSED.

NOTE: HANDICAP PARKING SIGNS SHALL CONFORM TO FOOT ROADWAY AND TRAFFIC DESIGN STANDARD INDEX NUMBER 17355, SHEET 2 OF 11, FTP-20-06, FTP-21-06, FTP-22-06

SITE DATA:
212 YOAKUM STREET 32505
PARCEL ZONING: HC/LI
FLU: MU/U

BUILDING SETBACKS REQUIRED (HC/LI ZONED PARCEL):
FRONT SETBACK =15'
REAR SETBACK =15'
SIDE SETBACK =10'

MAXIMUM IMPERVIOUS SURFACE: 85%
MAXIMUM BUILDING HEIGHT: 150'
MAXIMUM FLOOR AREA RATIO: 2.0 (MU/U)

PROPOSED FLOOR AREA RATIO:
TOTAL GROSS FLOOR AREA = 3,600 SF
GROSS LOT AREA = 26,323 SF
FLOOR AREA RATIO = 3,600 SF/26,323 SF = 0.14

SOLID WASTE NOTE:
SOLID WASTE TO BE DISPOSED OF VIA 55 GAL. TRASH CAN AND PRIVATE HAULER

PARKING STALL NOTES:

- ALL HANDICAP PARKING STALLS ARE TO MEASURE 12' x 18' WITH AN ADJACENT 5' WIDE AISLE
- ALL STANDARD PARKING STALLS ARE TO MEASURE 9' x 18'
- ALL PARKING STALLS ARE TO BE DEMARCATED WITH 4" SOLID WHITE LINES UNLESS OTHERWISE NOTED

FIRE SAFETY NOTES

- FIRE DEPT. ACCESS ROADS SHALL HAVE A MINIMUM UNOBSTRUCTED WIDTH OF 20'
- FIRE DEPT. ACCESS ROADS SHALL HAVE A MINIMUM UNOBSTRUCTED VERTICAL CLEARANCE OF 13'-6"
- THE REQUIRED WIDTH OF A FIRE DEPT. ACCESS ROAD SHALL NOT BE OBSTRUCTED IN ANY MANNER, INCLUDING BY THE PARKING OF VEHICLES.

EXISTING SITE AREA: 26,332 SF = 0.60 ACRES					
IMPERVIOUS and PERVIOUS AREA					
	EXISTING	REMOVE	NEW	POST-CONSTRUCTION	NET CHANGE
BUILDINGS	0 SF	0 SF	3,600 SF	3,600 SF	+3,600 SF
ASPHALT/CONCRETE	0 SF	0 SF	38 SF	38 SF	+38 SF
TOTAL IMPERVIOUS AREA	0 SF	0 SF	3,638 SF	3,638 SF	+3,638 SF
ROCK AREA	0 SF	0 SF	2,478 SF	2,478 SF	+2,478 SF
LANDSCAPE AREA	26,332 SF	6,116 SF	0 SF	20,216 SF	(-6,116 SF)
PERCENTAGE OF LANDSCAPE	100%			77%	(-23%)
PARKING DATA					
	EXISTING	REMOVE	NEW	POST-CONSTRUCTION	NET
NON-HANDICAPPED SPACES	0	0	0	0	N/A
HANDICAPPED SPACES	0	0	0	0	N/A

CURVE DATA
RADIUS ~ 200.00' (D&F)
LENGTH OF ARC ~ 80.55' (D) 80.63' (F)
DELTA ANGLE ~ 23' 03' 13" (F)
CHORD LENGTH ~ 80.00' (D) 80.08' (F)
CHORD BEARING ~ N78° 27' 43"W (D)
N78° 23' 08"W (F)

INSTALL
STOP SIGN (R1-1),
24" WHITE THERMOPLASTIC STOP BAR


(P)YOAKUM COURT - (F)YOAKUM STREET
(50' PUBLIC R/W)

46-1S-30-2001-002-021
GONZALEZ JOSE A
GONZALEZ MARIA E
215 MICHIGAN AVE
PENSACOLA, FL 32505
ZONING: HC/LI
FLU: MU-U
USE: SINGLE FAMILY RESIDENCE

S89°57'14"E ~ 100.00'(F)
100.00'(P)

46-1S-30-2001-015-021
INGRAM RENTAL PROPERTIES LLC
6012 WYNDI WAY
PACE, FL 32571
ZONING: HC/LI
FLU: MU-U
USE: MULTI-FAMILY

HAMMOND ENGINEERING, INC.
FLORIDA AUTHORIZATION NO. 9130
ALABAMA AUTHORIZATION NO. 32777
3802 NORTH S STREET
PENSACOLA, FLORIDA 32505
850 434-2603
FAX 850-434-2650
TOM@SELANDDESIGN.COM

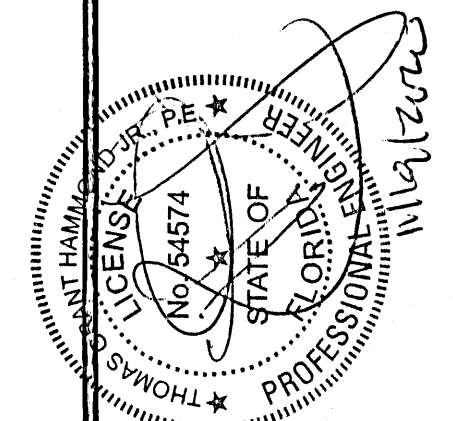


SITE DEVELOPMENT
PLANS FOR
FRONTIER MOTORS
PRIVATE STORAGE
SITE PLAN
FLORIDA
ESCAMBIA COUNTY

DRAWN BY: CUG
DESIGNED BY: RLS
CHECKED BY: TSH
DATE: 9-3-20
SCALE: AS SHOWN
NOT RELEASED FOR
CONSTRUCTION
BY: DATE:

PROJECT NO: 20-035

SHEET: C4

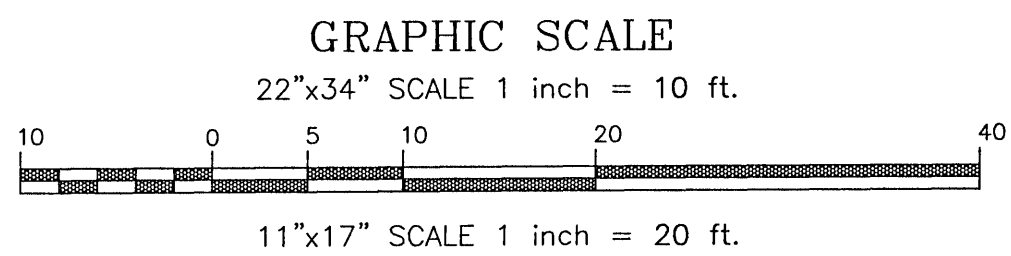


- LEGEND:
- DENOTES EXISTING ASPHALT
 - DENOTES PROPOSED GRAVEL
 - DENOTES PROPOSED CONCRETE
 - DENOTES EXISTING UTILITY POLE
 - DENOTES EXISTING LIGHT POLE
 - DENOTES EXISTING GUY ANCHOR
 - DENOTES EXISTING TREE
 - DENOTES EXISTING OVERHEAD ELECTRICAL
 - DENOTES EXISTING CHAIN LINK FENCE
 - DENOTES EXISTING WOOD PRIVACY FENCE
 - DENOTES PROPOSED TIMBER PRIVACY FENCE
 - DENOTES PROPOSED 4" CHAIN LINK FENCE
 - DENOTES BENCHMARK LOCATION
 - DENOTES EXISTING SPOT ELEVATION
 - M.E.G. MATCH EXISTING GRADE
 - DENOTES PROPOSED SPOT ELEVATION
 - DENOTES PROPOSED STORM PIPE

TREE ID TABLE		
TREE #	TYPE	SIZE (DBH)
1	CEDAR	30"
2	PECAN	12"
4	PECAN	24"
5	OAK	44"

PROTECTED TREE NOTE:


1. PROTECTED TREES SHALL REMAIN ONSITE AND ANY PROPOSED LAND CLEARING/"LAND DISTURBING ACTIVITIES", INCLUDING THE PLACEMENT OF FILL/FILL MATERIALS, GRADING, EXCAVATING, ETC. SHALL NOT OCCUR UNTIL SUCH TIME AS APPROPRIATE PERMIT(S) ARE ISSUED FOR SUCH SITE WORK.

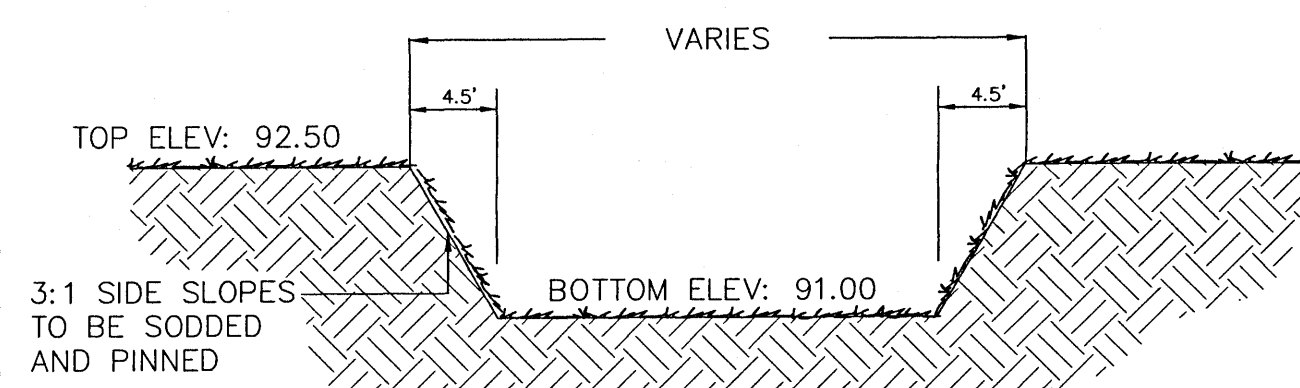


STORMWATER RETENTION POND #1
TYPICAL CROSS SECTION
NTS

DETENTION BASIN CONSTRUCTION

1. INITIALLY INSTALL ALL EROSION AND SEDIMENT CONTROL BMP'S AS ILLUSTRATED ON THE EROSION CONTROL PLAN PROVIDED AS PART OF THESE PLANS (SHEET C3)
2. CONSTRUCT THE DETENTION BASIN TO ROUGH GRADE BY UNDER-EXCAVATING THE BASIN BOTTOM AND SIDES BY ABOUT 6 INCHES.
3. AFTER THE DRAINAGE AREA CONTRIBUTING TO THE BASIN HAS BEEN FULLY STABILIZED, THE INTERIOR SIDE SLOPES AND BASIN BOTTOM SHALL BE EXCAVATED TO FINAL DESIGN SPECIFICATIONS. THE EXCESS SOIL AND UNDESIRABLE MATERIAL MUST BE CAREFULLY EXCAVATED AND REMOVED FROM THE POND SO THAT ALL ACCUMULATED SILTS, CLAYS, ORGANICS, AND OTHER FINE SEDIMENT MATERIAL HAS BEEN REMOVED FROM THE POND AREA. THE EXCAVATED MATERIAL SHALL BE DISPOSED OF BEYOND THE LIMITS OF THE DRAINAGE AREA OF THE BASIN.
4. ONCE THE BASIN HAS BEEN EXCAVATED TO FINAL GRADE, THE ENTIRE BASIN BOTTOM MUST BE DEEP RAKED AND LOOSENEED FOR OPTIMAL FILTRATION.
5. FINALLY, THE ENTIRE BANK SLOPE AND POND BOTTOM SHALL BE PERMANENTLY STABILIZED IN A MANNER THAT GUARANTEES HEALTHY GROWTH OF GRASS (FREE FROM NOXIOUS WEEDS) SUCH AS PANGALA, ARGENTINE BAHIA, BERMUDA, CENTIPEDE OR OTHER SUITABLE GRASS.

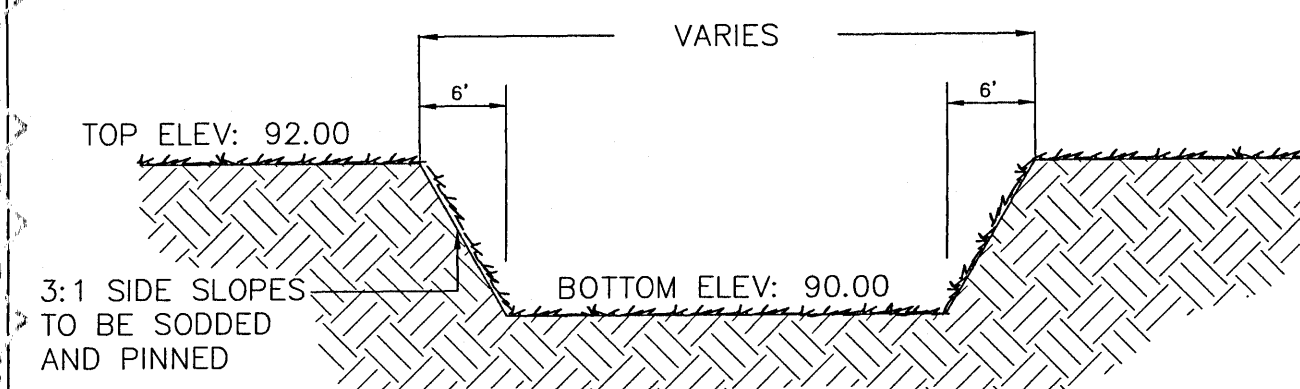

STORMWATER RETENTION POND #2
TYPICAL CROSS SECTION
NTS

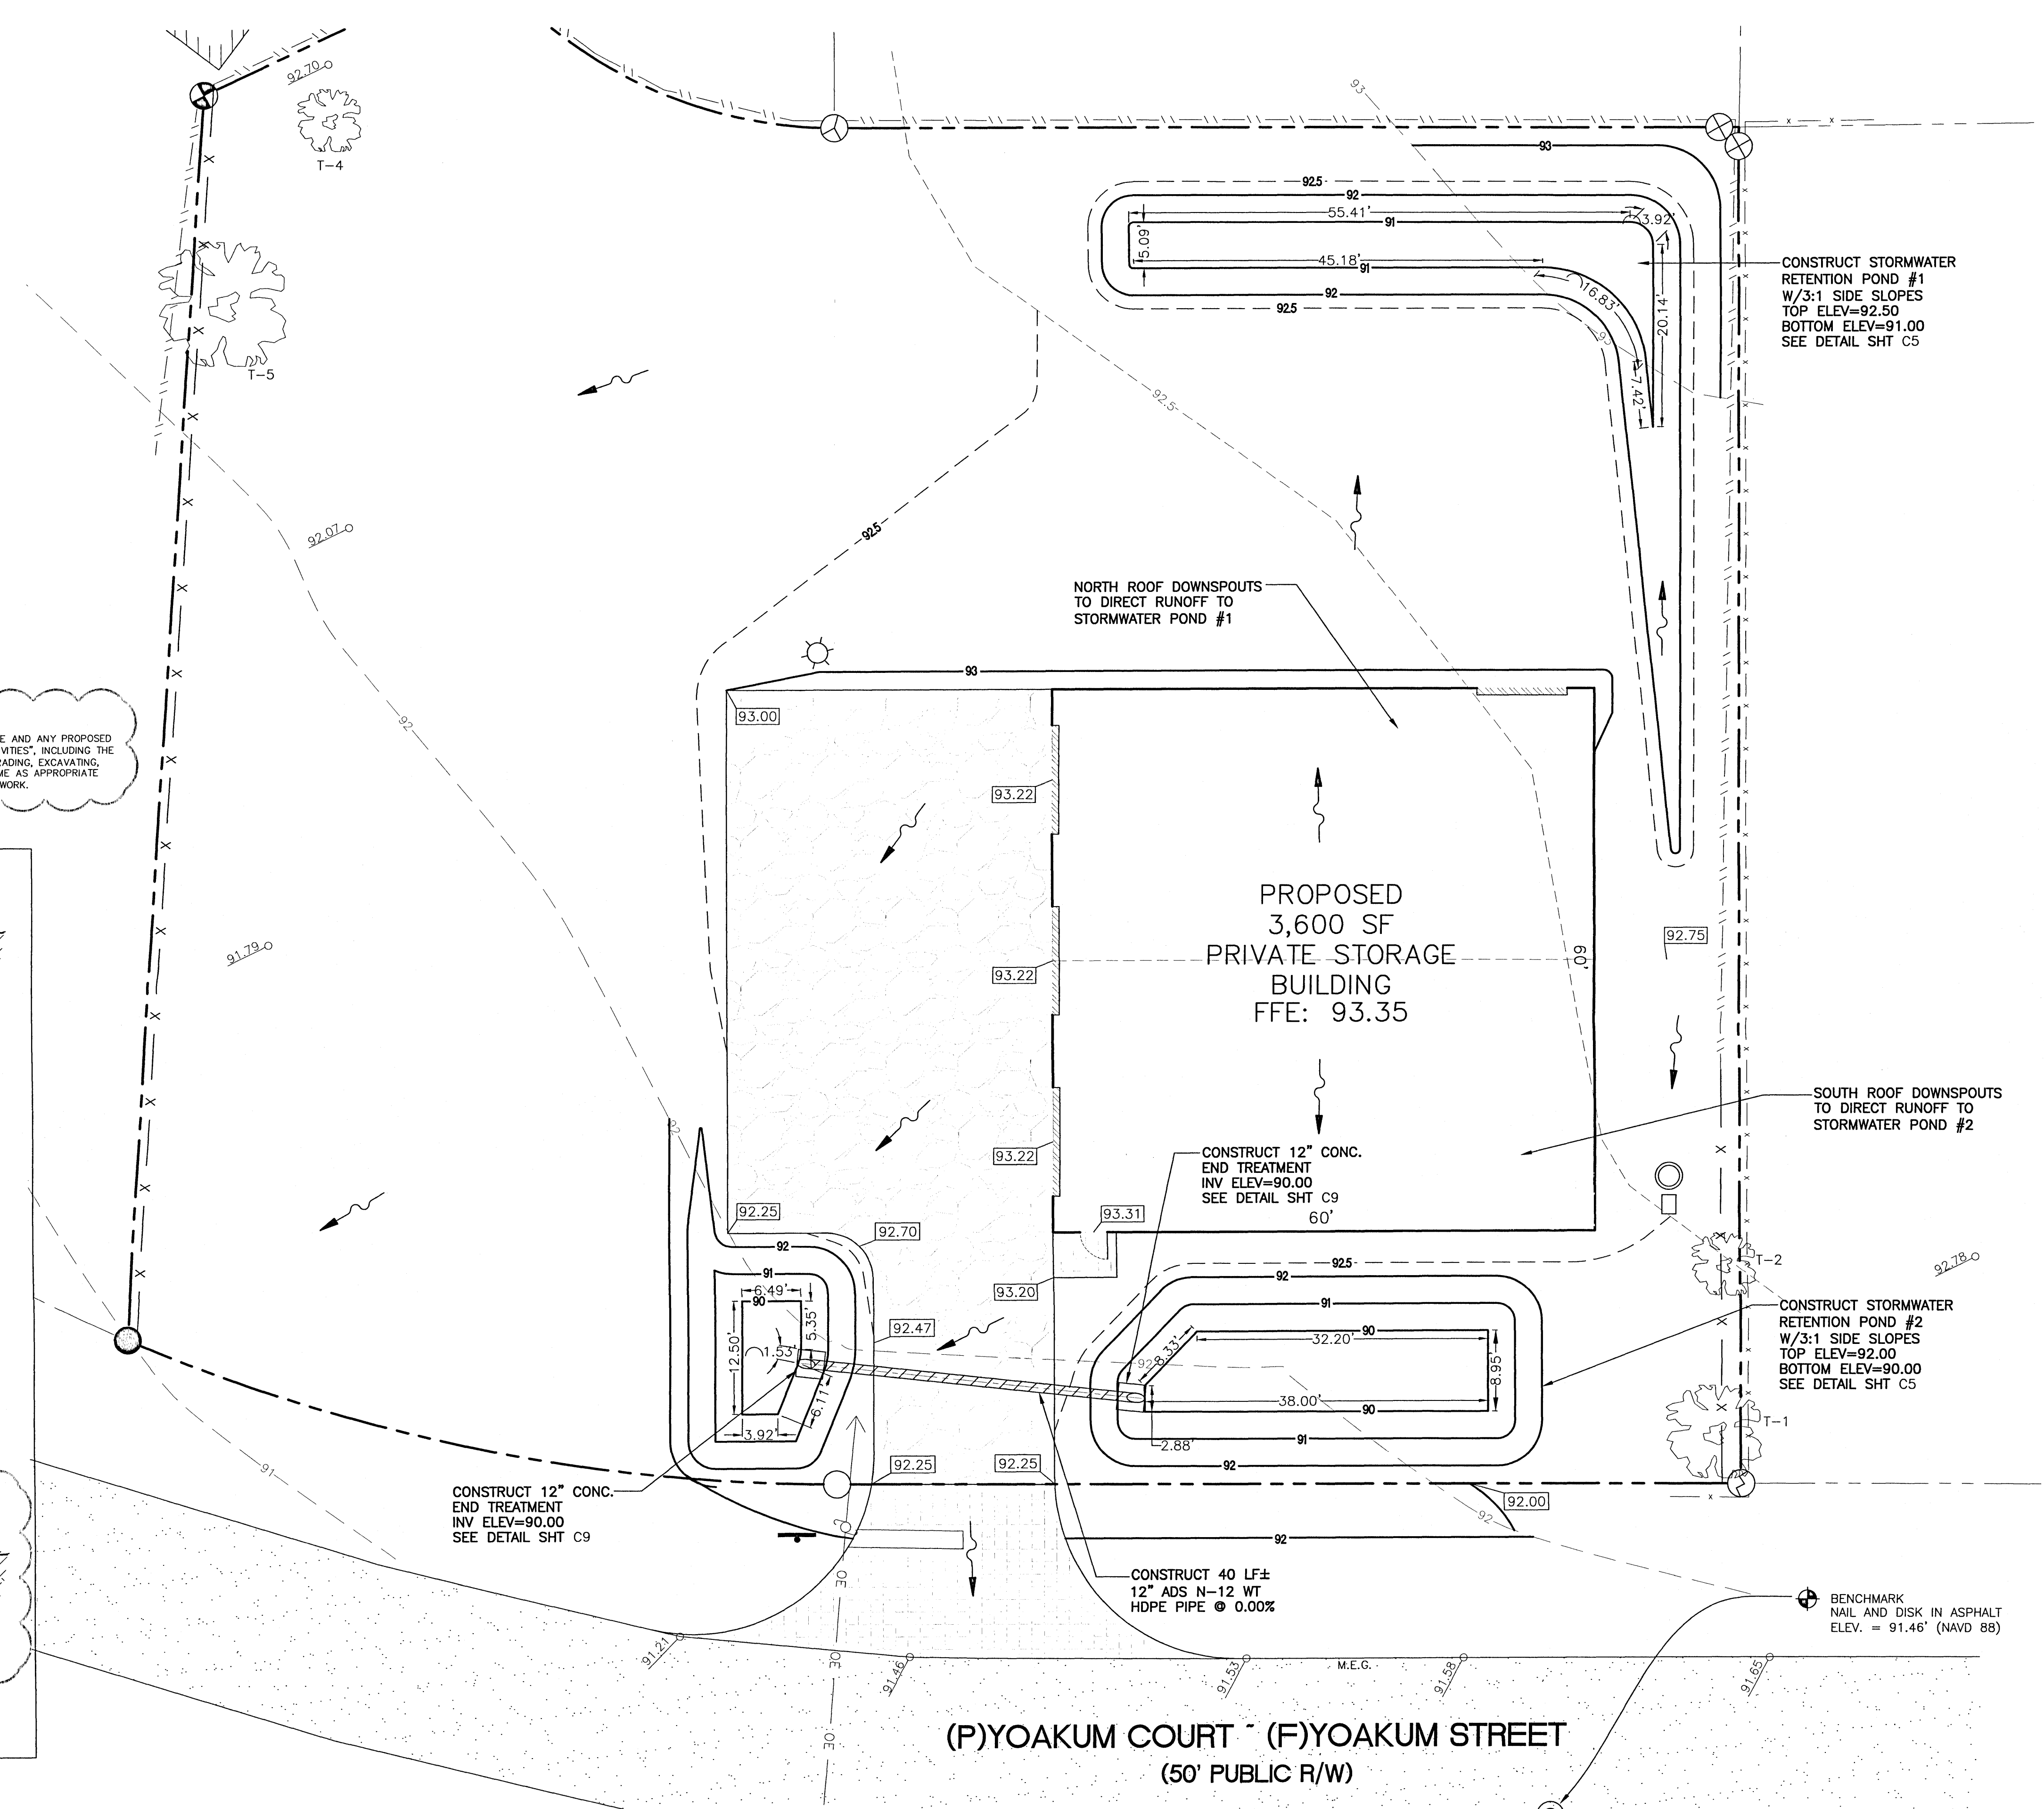

CONSTRUCT STORMWATER RETENTION POND #1
W/3:1 SIDE SLOPES
TOP ELEV=92.50
BOTTOM ELEV=91.00
SEE DETAIL SHT C5

NORTH ROOF DOWNSPOUTS TO DIRECT RUNOFF TO STORMWATER POND #1

PROPOSED 3,600 SF PRIVATE STORAGE BUILDING
FFE: 93.35

CONSTRUCT 12" CONC. END TREATMENT
INV ELEV=90.00
SEE DETAIL SHT C9
60'

SOUTH ROOF DOWNSPOUTS TO DIRECT RUNOFF TO STORMWATER POND #2

CONSTRUCT STORMWATER RETENTION POND #2
W/3:1 SIDE SLOPES
TOP ELEV=92.00
BOTTOM ELEV=90.00
SEE DETAIL SHT C5

CONSTRUCT 12" CONC. END TREATMENT
INV ELEV=90.00
SEE DETAIL SHT C9


CONSTRUCT 40 LF± 12" ADS N-12 WT HDPE PIPE @ 0.00%

BENCHMARK
NAIL AND DISK IN ASPHALT
ELEV. = 91.46' (NAVD 88)

(P)YOAKUM COURT (F)YOAKUM STREET
(50' PUBLIC R/W)

REVISIONS	
NO.	DATE
1	11/10/2020


HAMMOND ENGINEERING, INC.
FLORIDA AUTHORIZATION NO. 9130
ALABAMA AUTHORIZATION NO. 3277
3802 NORTH "S" STREET
PENSACOLA, FLORIDA 32505
850 434-2603
FAX 850-434-2650
TOM@SELANDESIGN.COM

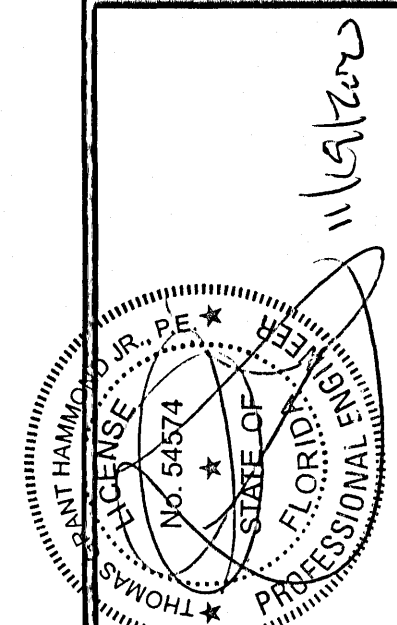

SITE DEVELOPMENT
PLANS FOR
FRONTIER MOTORS
PRIVATE STORAGE
GRADING & DRAINAGE
PLAN
FLORIDA
ESCAMBIA COUNTY

DRAWN BY: CJB	DESIGNED BY: RLS
CHECKED BY: TSH	DATE: 9-9-20
SCALE: AS SHOWN	NOT RELEASED FOR CONSTRUCTION
BY:	DATE:

PROJECT NO: 20-035
SHEET: C5

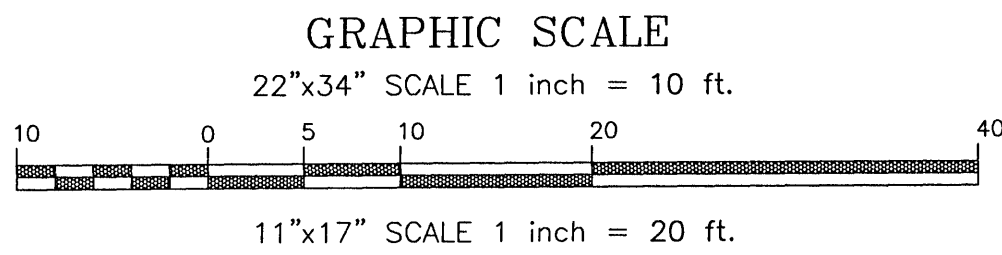

LEGEND:

	DENOTES EXISTING ASPHALT
	DENOTES PROPOSED GRAVEL
	DENOTES PROPOSED CONCRETE
	DENOTES EXISTING UTILITY POLE
	DENOTES EXISTING LIGHT POLE
	DENOTES EXISTING GUY ANCHOR
	DENOTES EXISTING TREE
	DENOTES EXISTING OVERHEAD ELECTRICAL
	DENOTES EXISTING CHAIN LINK FENCE
	DENOTES EXISTING WOOD PRIVACY FENCE
	DENOTES PROPOSED TIMBER PRIVACY FENCE
	DENOTES PROPOSED STORM PIPE
	DENOTES EXISTING WATER LINE
	DENOTES PROPOSED WATER LINE
	DENOTES PROPOSED SANITARY SEWER LINE
	DENOTES EXISTING FORCE MAIN
	DENOTES PROPOSED FORCE MAIN

TREE ID TABLE


TREE #	TYPE	SIZE (DBH)
1	CEDAR	30"
2	PECAN	12"
4	PECAN	24"
5	OAK	44"

PROTECTED TREE NOTE:

1. PROTECTED TREES SHALL REMAIN ONSITE, AND ANY PROPOSED LAND CLEARING/LAND DISTURBING ACTIVITIES, INCLUDING THE PLACEMENT OF FILL/FILL MATERIALS, GRADING, EXCAVATING, ETC. SHALL NOT OCCUR UNTIL SUCH TIME AS APPROPRIATE PERMIT(S) ARE ISSUED FOR SUCH SITE WORK.

LEGEND:


	DENOTES EXISTING ASPHALT		DENOTES PROPOSED GRAVEL
	DENOTES EXISTING GRASS		DENOTES EXISTING FIRE HYDRANT
	DENOTES PROPOSED CONCRETE		

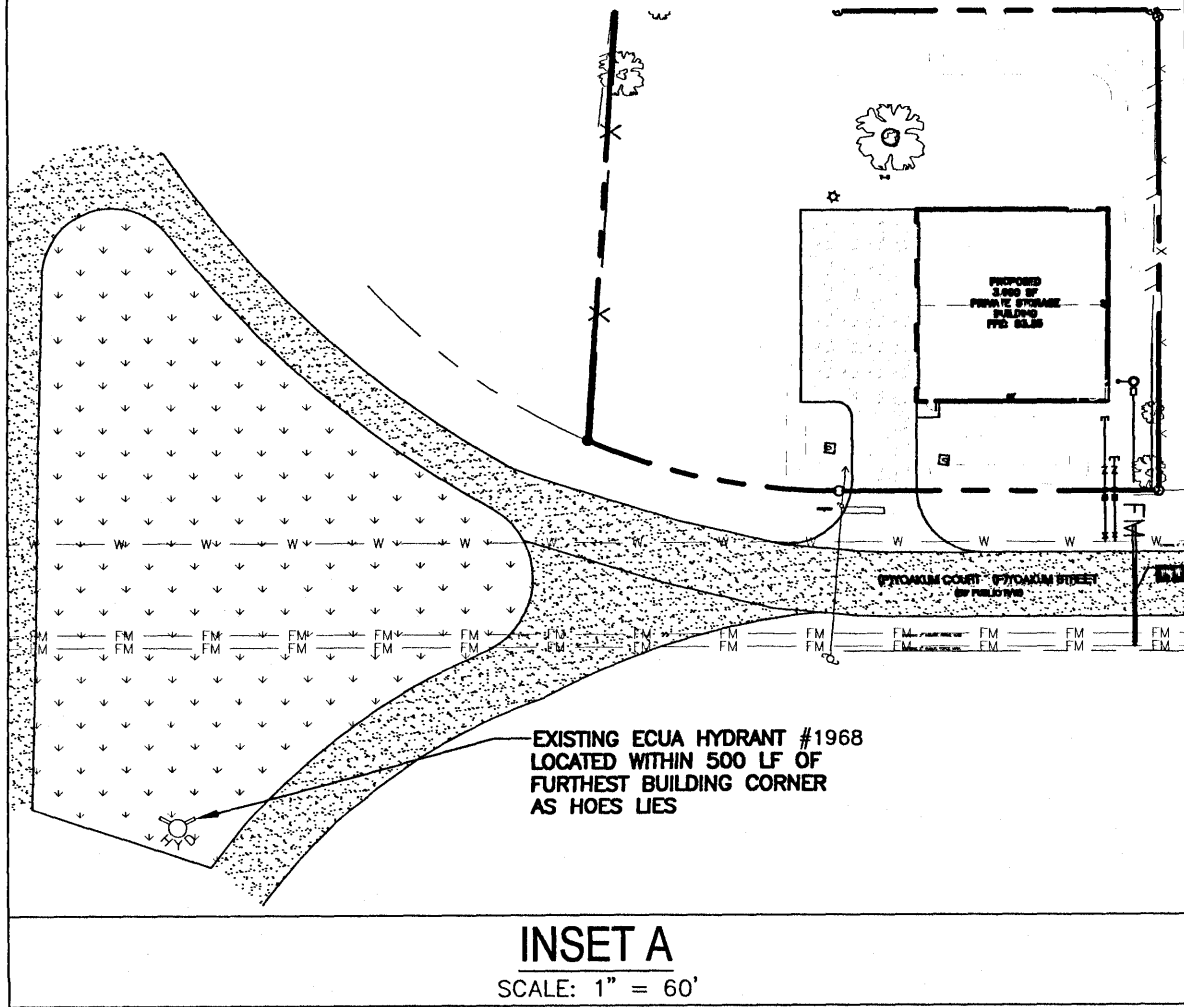

GENERAL UTILITY NOTES

- All potable water and sanitary sewer work shall be done in accordance with ECUA's engineering manual.
- Contractor shall notify ECUA and the County Engineer 48 hours prior to the commencement of this project.
- Contractor shall make sewer service connections and potable water connections with an ECUA inspector present.
- All work shall comply with applicable standards and codes established by ECUA and the Florida Department of Environmental Protection and written specifications.
- Contractor shall notify Sunshine One Utilities two business days in advance prior to digging within R/W, 1-800-432-4770.
- The Contractor shall notify the superintendents of the water, gas, sewer, telephone and power companies 10 days in advance, that he intends to start work in a specific area. The Owner disclaims any responsibility for the support and protection of sewers, drains, water pipes, gas pipes, conduits of any kind, utilities or other structures owned by the City, County, State or by private or public utilities legally occupying any street, alley, public place or right-of-way.
- Florida State Statute 553.851 requires that all excavators notify gas companies of their intention to perform any excavation at least two business days (excluding Sat., Sun. & holidays) prior to beginning work.
- Locations of existing utilities shown on plans are approximate only and it shall be the responsibility of the Contractor to verify the location and sizes before construction. Failure of the plans to show the existence of any underground utilities, structures, etc., shall not relieve the Contractor from the responsibility of locating, preserving and protecting said utility or structures.
- Property obstructions which are to remain in place, such as buildings, sewer, storm drains, water or gas pipes, electrical conduits, poles, walls, posts, etc., are to be carefully protected and are not to be displaced, unless noted.
- Relocation of the obstructions owned by private property Owner, such as mailboxes, shall be the responsibility of the Contractor who must coordinate with the property Owner.
- Control of sedimentation and erosion shall be the Contractor's responsibility.
- Contractor shall dispose of by hauling away all excess material.
- The Utility Contractor shall make connections to the sanitary sewer as shown and shall verify locations and elevations of all utility lines prior to beginning work. The Utility Contractor shall include the cost of protection and/or relocation of other utilities in his bid and shall coordinate his work with other utility sub-contractors to prevent conflicts with other utility lines.
- Contractor shall be responsible for and comply with any testing required by the local governing agency in addition to the testing requirements outlined in the specifications.
- Proposed water line shall have a minimum cover of 30" and a maximum cover of 36" below finished grade unless otherwise noted.
- "As-built" drawings showing all service lines, laterals, mains and valve locations measured from permanent reference points shall be furnished to the Engineer prior to acceptance.
- Grading around trees which are to remain shall be away from the tree in a manner to cause no damage to the tree.
- Contractor shall be responsible for the seeding and mulching and/or sodding of street and road shoulder areas in accordance with FDOT and applicable county requirements and standards.
- Water supply facilities, including mains, shall be installed, cleaned, disinfected and bacteriologically cleared for service in accordance with the latest applicable AWWA Standards and coordinated with the designated ECUA Inspector and Quality Control Supervisor.
- All onsite water and sewer facilities shall be privately owned, operated and maintained.
- Contractor is responsible for adjustment of existing utilities if proposed improvements impact existing utilities.
- All work to take place within the right of way or to be owned and maintained by ECUA post-construction shall be performed by a certified underground utility contractor.
- Contractor must locate existing water main and sanitary sewer force main line to be tied into and verify configuration to establish the best location for connection.
- Contractor shall obtain an Escambia County right of way permit prior to working within the county R/W.
- Contractor to video/document all right of way areas to be impacted prior to construction.
- Reference utility details provided on sheet C9.
- Contractor to coordinate power supply to building with Gulf Power...850-429-2861
- Contractor to coordinate proposed natural gas service with Energy Services of Pensacola...850-983-5434.

23. NOTE: THERE ARE TWO EXISTING OR PREVIOUSLY LOCATED WATER METERS FOR THIS SITE, ACCORDING TO THE LOCAL M.S. ENGINEER, WHICH RECORDS MAY BE USED TO INQUIRE FOR THE WATER SERVICE TO THE BUILDING. STRUCTURAL WATER METERS (IF EXISTING) THAT ARE NOT USED SHOULD BE CAPED AT THE UTILITY LINE.

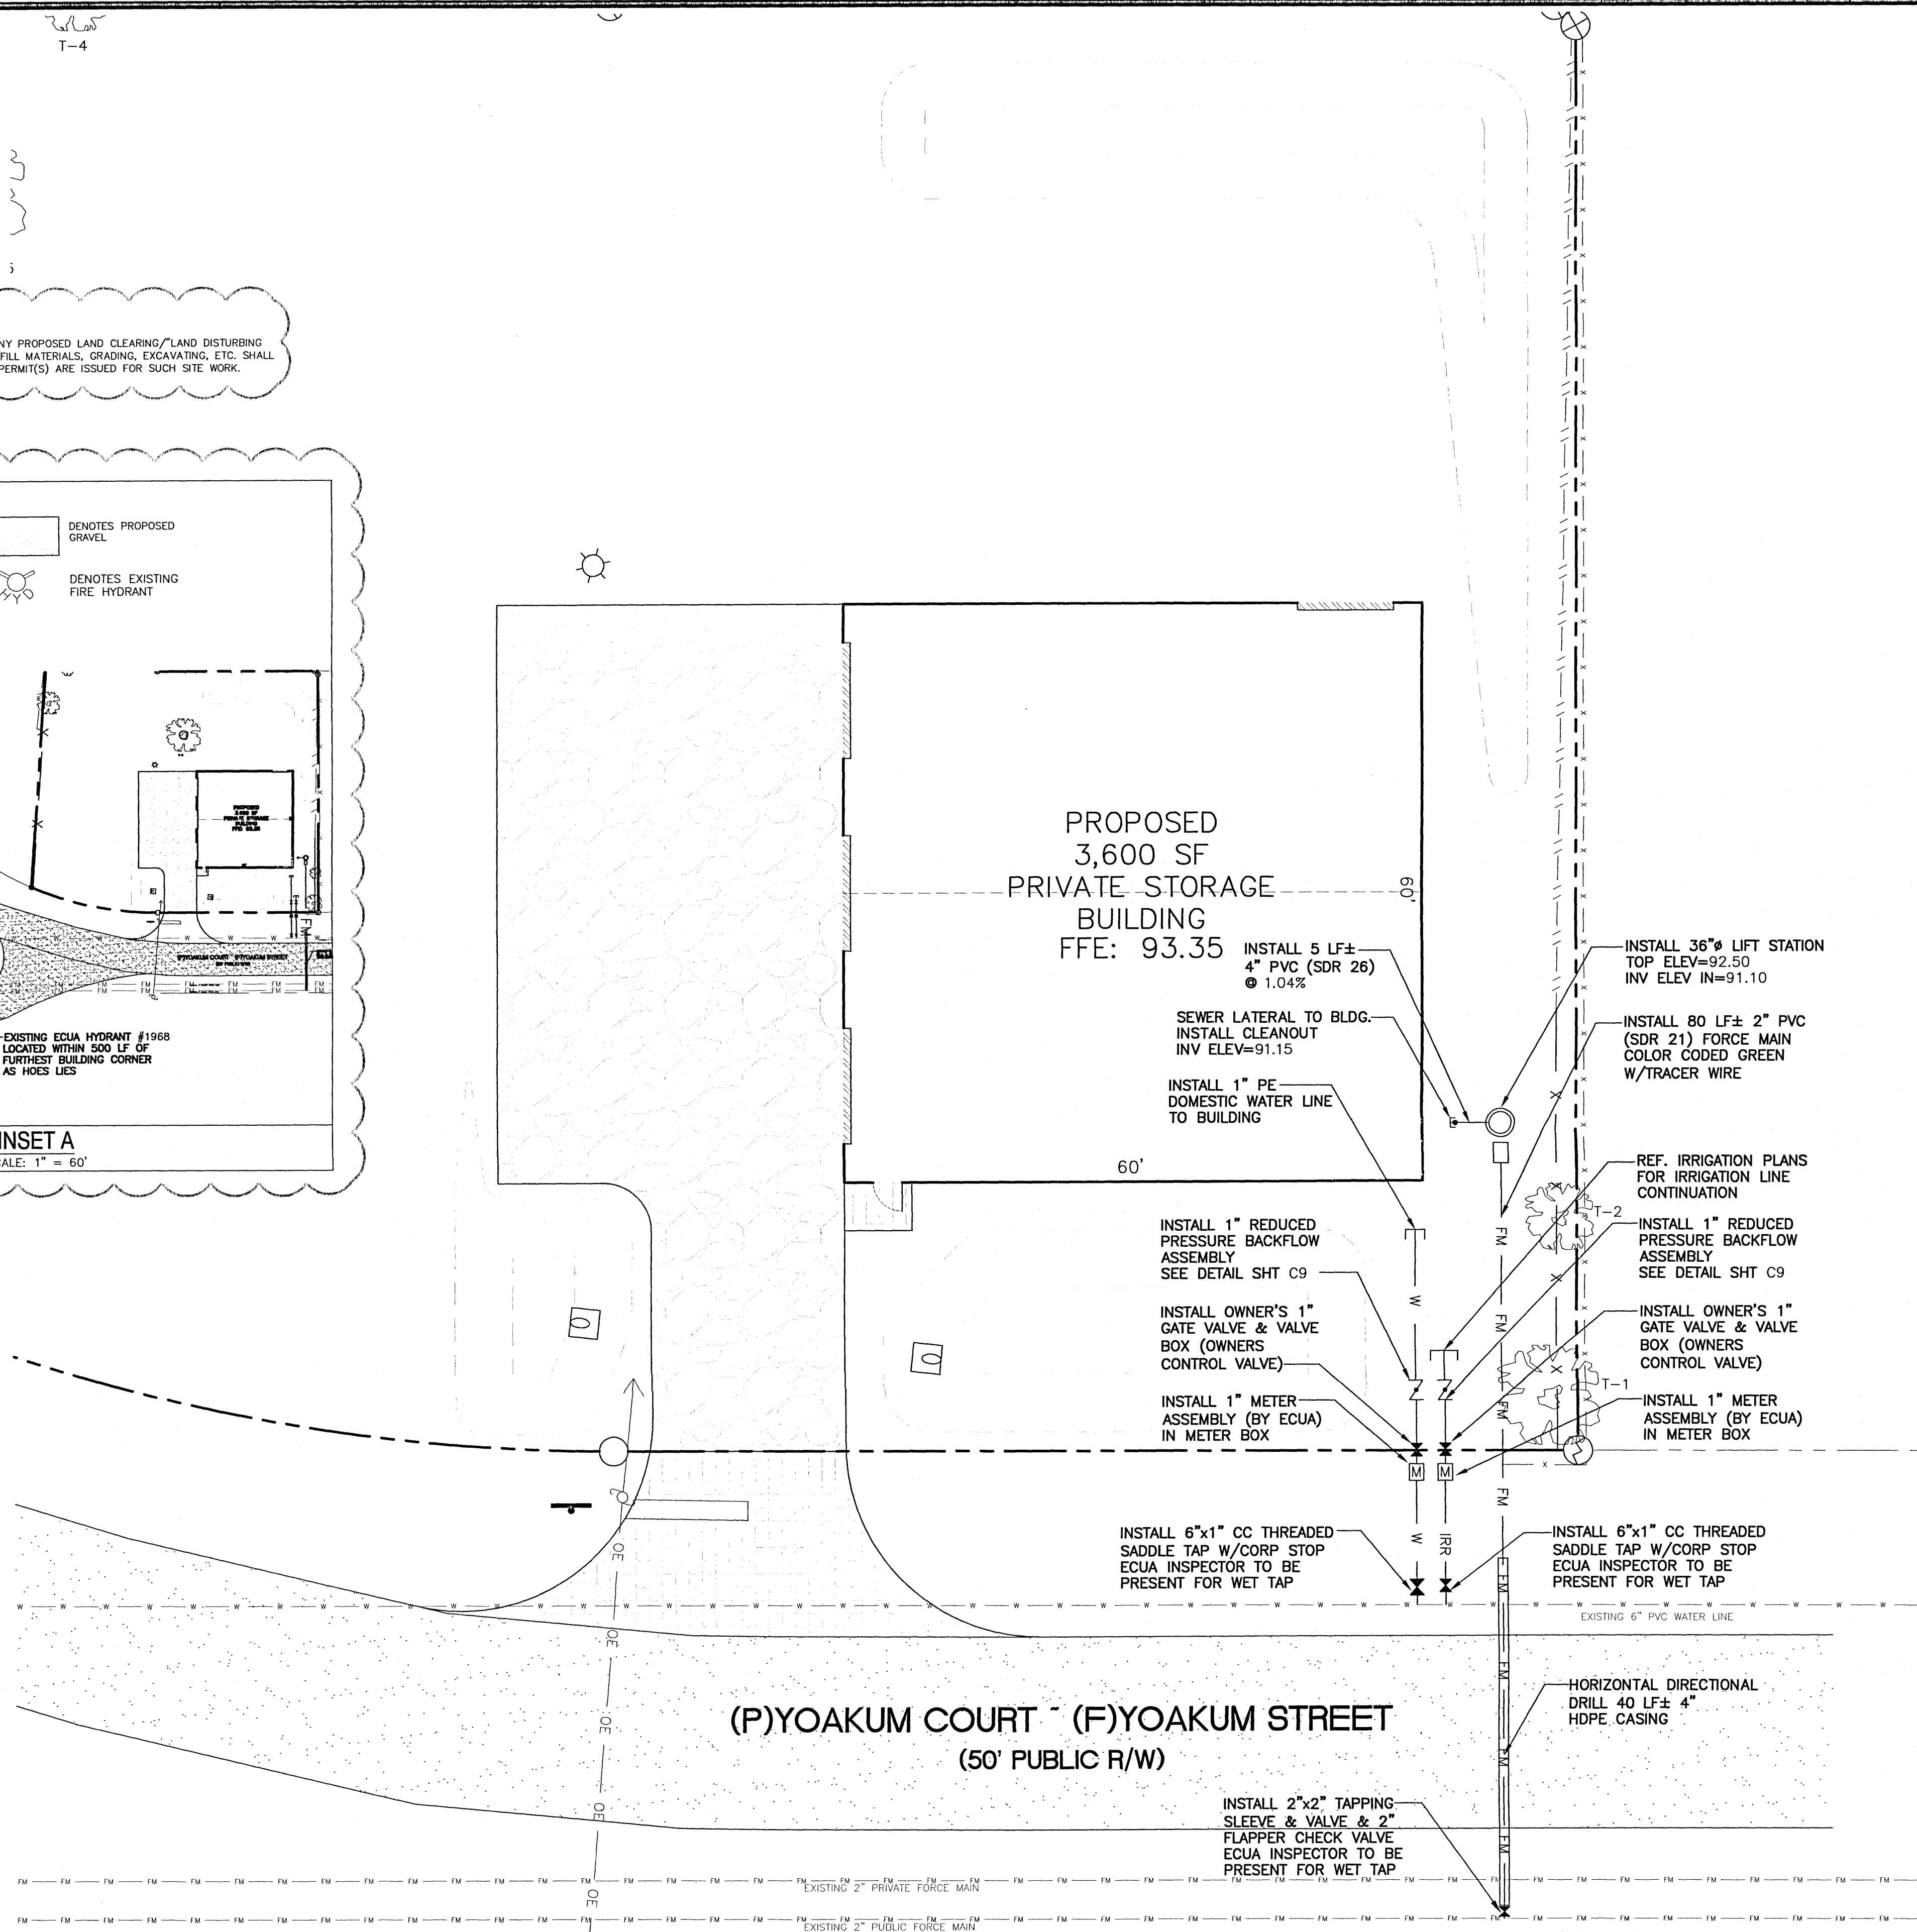

HAMMOND ENGINEERING, INC.
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ALABAMA AUTHORIZATION NO. 3277
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PENSACOLA, FLORIDA 32505
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SITE DEVELOPMENT
PLANS FOR
FRONTIER MOTORS
PRIVATE STORAGE
UTILITY PLAN

ESCAMBIA COUNTY FLORIDA

DRAWN BY: GJB
DESIGNED BY: RLS
CHECKED BY: TGH
DATE: 9-3-20
SCALE: AS SHOWN
NOT RELEASED FOR
CONSTRUCTION
BY: DATE:

PROJECT NO: 20-035
SHEET: C6

REVISIONS
NO. DATE
1 11/06/2020 REVISED PLANS AS PER ESCAMBIA COUNTY DEC REVIEW COMMENTS

THIS DRAWING IS THE PROPERTY OF HAMMOND ENGINEERING, INC. AND IS NOT TO BE REPRODUCED OR USED FOR ANY OTHER PROJECT AND IS TO BE RETURNED UPON REQUEST.

GRAPHIC SCALE

22"x34" SCALE 1 inch = 10 ft.



11"x17" SCALE 1 inch = 20 ft.

LEGEND:	
	DENOTES EXISTING ASPHALT
	DENOTES PROPOSED GRAVEL
	DENOTES PROPOSED CONCRETE
	DENOTES PROPOSED SOD (BAHAI RECOMMENDED)
	DENOTES EXISTING UTILITY POLE
	DENOTES EXISTING LIGHT POLE
	DENOTES EXISTING GUY ANCHOR
	DENOTES EXISTING TREE
	DENOTES EXISTING OVERHEAD ELECTRICAL
	DENOTES SOUTHERN MAGNOLIA (OR APPROVED EQUAL CANOPY TREE) TO BE PLANTED TYPICAL OF 5
	DENOTES RED MAPLE (OR APPROVED EQUAL CANOPY TREE) TO BE PLANTED TYPICAL OF 4
	DENOTES INDIAN HAWTHORNE SHRUB (OR APPROVED EQUAL) TO BE PLANTED TYPICAL OF 94
	DENOTES WAX MYRTLE UNDERSTORY TREE TO BE PLANTED (OR APPROVED EQUAL) TYPICAL OF 10
	DENOTES PROPOSED TIMBER PRIVACY FENCE
	DENOTES EXISTING CHAIN LINK FENCE
	DENOTES EXISTING WOOD PRIVACY FENCE
	DENOTES PROPOSED STORM PIPE

TREE ID/REMOVAL TABLE			
TREE #	TYPE	SIZE (DBH)	REASON FOR REMOVAL
1	CEDAR	30"	N/A
2	PECAN	12"	N/A
4	PECAN	24"	N/A
5	OAK	44"	N/A

ESCAMBIA COUNTY LANDSCAPING REQUIREMENTS:

- 15 PERCENT OF THE TOTAL DEVELOPABLE SITE SHALL BE DEVOTED TO LANDSCAPING/GREEN SPACE.
- QUALITY. ALL PLANTS REQUIRED BY THIS SECTION SHALL CONFORM TO THE STANDARDS FOR FLORIDA GRADE NO. 1, OR BETTER, AS PROVIDED IN THE LATEST EDITION OF GRADES AND STANDARDS FOR NURSERY PLANTS, DIVISION OF PLANT INDUSTRY, FLORIDA DEPARTMENT OF AGRICULTURE AND CONSUMER SERVICES.
- SPECIES. ALL LANDSCAPING SHALL UTILIZE NATIVE PLANT SPECIES OR THOSE SPECIES LISTED IN THE FLORIDA-FRIENDLY LANDSCAPING GUIDE TO PLANT SELECTION AND LANDSCAPE DESIGN.
- TREES. TREES PLANTED TO FULFILL THE MINIMUM LANDSCAPE REQUIREMENTS OF THIS ARTICLE SHALL NORMALLY ATTAIN A MATURE HEIGHT OF AT LEAST 20 FEET AND HAVE A MINIMUM CALIPER OF TWO AND ONE-HALF INCHES OR GREATER MEASURED AT FOUR INCHES ABOVE ROOT BALL AT PLANTING. THE FOLLOWING ADDITIONAL CRITERIA APPLY:
 - 1. NON-NATIVE SPECIES. NON-NATIVE SPECIES ARE LIMITED TO 25 PERCENT OR LESS OF THE TOTAL TREES PLANTED.
 - 2. DIVERSITY. THE DIVERSITY OF ANY TREES REQUIRED TO BE PLANTED ON A SITE SHALL COMPLY WITH THE FOLLOWING LIMITS TO AVOID UNIFORM SITE TREE DECLINE FROM PESTS OR DISEASE:
 - A MAXIMUM OF 67% OF THE TOTAL TREES TO BE PLANTED MAY BE OF THE SAME SPECIES.
 - USE OF PALMS. PALMS DO NOT COMPLY WITH DEFINITION OF TREE FOR THE PURPOSES OF THESE LANDSCAPING PROVISIONS. HOWEVER, WIND-RESISTANT SPECIES MAY BE SUBSTITUTED AT THE RATIO OF TWO PALMS FOR ONE REQUIRED TREE FOR UP TO 50 PERCENT OF TREES REQUIRED FOR DEVELOPMENT ON SANTA ROSA ISLAND OR PERDIDO KEY, EXCLUDING ANY TREES REQUIRED SPECIFICALLY FOR BUFFERING OR REPLACEMENTS FOR PROTECTED TREE REMOVALS. SUCH PALMS INCLUDE: DATE PALM (DZIOXIN SPP. EXCEPT P. RECLINATA) AND CABBAGE OR SABAL (SABAL PALMETTO).
 - ALL SHRUBS SHALL BE A MINIMUM OF 12 INCHES IN HEIGHT AT TIME OF PLANTING.
 - TURF GRASS. CONSISTENT WITH FLORIDA-FRIENDLY PRACTICES, DEVELOPMENT SHOULD CONSOLIDATE AND LIMIT THE USE OF MOST TURF GRASSES TO ESSENTIAL AREAS. WHEN USED, GRASS SHALL BE SPECIES NORMALLY GROWN AS PERMANENT LAWNS IN ESCAMBIA COUNTY. ALL SOD SHALL BE CLEAN AND REASONABLY FREE OF WEEDS, NOXIOUS PESTS, AND DISEASES. WHEN GRASS AREAS ARE TO BE SEED, SPRIGGED, OR PLUGGED, SPECIFICATIONS MUST BE SUBMITTED. SUBSTANTIAL COVERAGE MUST BE ACHIEVED WITHIN 180 DAYS AND NURSE GRASS SHALL BE SOWN FOR IMMEDIATE EFFECTS AND PROTECTION UNTIL COVERAGE IS OTHERWISE ACHIEVED.
 - ALL PLANTS SHALL CONFORM TO THE STANDARDS OF FLORIDA GRADE NO. 1, OR BETTER, AS PROVIDED IN THE LATEST EDITION OF "GRADES AND STANDARDS OF NURSERY PLANTS", DIVISION OF PLANT INDUSTRY, FLORIDA DEPARTMENT OF AGRICULTURE AND CONSUMER SERVICES.
 - ANY PROPOSED REMOVAL OF PROTECTED TREES IN THE FUTURE SHALL REQUIRE PRIOR PERMIT APPLICATION & REVIEW BY ESCAMBIA COUNTY ENVIRONMENTAL PERMITTING STAFF PRIOR TO REMOVAL.
 - PROTECTED TREES SHALL REMAIN ONSITE AND ANY PROPOSED LAND CLEARING/LAND DISTURBING ACTIVITIES, INCLUDING THE PLACEMENT OF FILL/FILL MATERIALS, GRADING, EXCAVATING, ETC. SHALL NOT OCCUR UNTIL SUCH TIME AS APPROPRIATE PERMIT(S) ARE ISSUED FOR SUCH SITE WORK.

LANDSCAPING NOTES:

- THE CONTRACTOR IS TO BE AWARE OF UNDERGROUND UTILITIES THROUGHOUT LANDSCAPED AREAS THAT MAY NOT BE ILLUSTRATED ON THIS PLAN. CONTRACTOR SHALL VERIFY LOCATION AND PROTECT ALL UTILITIES DURING EXCAVATION AND/OR FINISH GRADING ACTIVITIES.
- THE CONTRACTOR SHALL REPAIR OR REPLACE ANY DAMAGE TO EXISTING UTILITIES, WALKWAYS, PAVING OR OTHER ELEMENTS IN PLACE AT THE COMMENCEMENT OF HIS WORK, AT NO ADDITIONAL COST TO THE OWNER.
- ANY ADJUSTMENT TO THIS PLAN DUE TO EXISTING CONDITIONS NOT REFLECTED ON THIS PLAN WILL BE RESOLVED AT THE TIME OF INSTALLATION.
- FINISH GRADES FOR ALL PLANTING, SOD AND SEED AREAS SHALL BE ESTABLISHED AND APPROVED BY THE OWNER/DEVELOPER PRIOR TO PLANTING, SODDING OR SEEDING.
- ALL TRASH AND CONSTRUCTION DEBRIS SHALL BE REMOVED FROM THE SITE PRIOR TO ESTABLISHMENT OF FINISH GRADES.
- ALL PLANTING SHALL BE DONE IN ACCORDANCE WITH ACCEPTED HORTICULTURE PRACTICES. THIS SHALL INCLUDE PROPER PLANTING SOIL MIX, PLANT BED AND TREE PIT PREPARATION, PRUNING, STAKING OR GUYING, FERTILIZATION AND ADEQUATE MAINTENANCE UNTIL ACCEPTANCE BY OWNER/DEVELOPER.
- ALL PLANT MATERIALS USED SHALL CONFORM TO THE STANDARDS FOR FLORIDA NO. 1 OR BETTER AS GIVEN IN "GRADES AND STANDARDS FOR NURSERY PLANTS", CURRENT EDITION, STATE OF FLORIDA, DEPARTMENT OF AGRICULTURE AND CONSUMER SERVICES, DIVISION OF PLANT INDUSTRY, TALLAHASSEE, FLORIDA. IN ADDITION, ALL PLANT MATERIAL SHALL BE FREE FROM INSECT AND DISEASE.
- PLANT CONTAINERS SHALL BE REMOVED PRIOR TO PLANTING. IF PLANTS ARE NOT CONTAINER GROWN, REMOVE A MINIMUM OF THE TOP 1/3 OF BURLAP, FABRIC OR WIRE MESH.
- ROOT BALLS SHALL BE FLUSH WITH FINISHED GRADE.
- BACKFILL SHALL BE LOOSENEED EXISTING SOIL. REMOVE ROCKS, STICKS OR OTHER DELETERIOUS MATERIAL GREATER THAN 1" IN ANY DIRECTION PRIOR TO BACKFILLING. WATER AND TAMP TO REMOVE AIR POCKETS. IF EXISTING SOILS CONTAIN EXCESSIVE SAND, CLAY OR OTHER EXTRANEOUS MATERIAL NOT CONDUCTIVE TO PROPER PLANT GROWTH CONTACT LANDSCAPE ARCHITECT PRIOR TO PLANTING.
- SOIL RINGS SHALL BE CONSTRUCTED OF EXISTING SOIL AT THE OUTER EDGE OF THE TREE PLANTING PIT WITH A HEIGHT AND WIDTH OF 4".
- STRAPPING SHALL BE MINIMUM 1" WIDE NYLON OR POLYPROPYLENE. GUYING MATERIAL IN CONTACT WITH TREE SHALL BE SOFT, PLIABLE, FLEXIBLE RUBBER.
- SABAL PALMS (IF PLANTED) MAY BE HURRICANE CUT. ALL OTHERS MUST HAVE FRONDS TIED WITH BIODEGRADABLE STRAP. TRUNKS SHALL HAVE NO SCARS OR SANDING.
- ALL GREEN AREAS FOUND WITHIN THE PROJECT BOUNDARIES ARE TO BE FULLY STABILIZED PRIOR TO REQUESTING FINAL INSPECTION. AREAS NOT ILLUSTRATED AS SODDED OR CONTAINING CYPRESS MULCH MUST BE SEED.

REQUIRED LANDSCAPE PLANTING DATA

NORTH BOUNDARY LINE: PROVIDE TYPE 'B' BUFFER AS PER 2-2.3(c) DESIGN STANDARDS MANUAL (NON-RESIDENTIAL ADJUTING SINGLE FAMILY RESIDENTIAL) SUPPLEMENTED W/6' TIMBER PRIVACY FENCE: 16' WIDE x 145' LONG BUFFER

2.5 CANOPY TREES REQ'D/100 LF
(145/100)*2.5 ~ 3.63 CANOPY TREES REQ'D
PLANT 4 CANOPY TREES
2.0 UNDERSTORY TREES REQ'D/100 LF
(145/100)*2.0 ~ 2.9 UNDERSTORY TREES REQ'D
PLANT 3 UNDERSTORY TREES
20 SHRUBS REQ'D/100 LF
(145/100)*20 ~ 29 SHRUBS REQ'D
PLANT 29 SHRUBS

REQUIRED MITIGATION: NO PROTECTED TREES EXISTING TO BE REMOVED AS PART OF THIS PROJECT.

EAST BOUNDARY LINE: PROVIDE TYPE 'B' BUFFER AS PER 2-2.3(c) DESIGN STANDARDS MANUAL (GENERAL COMMERCIAL USE ADJUTING MULTI-FAMILY RESIDENTIAL)
16' WIDE x 150' LONG BUFFER

2.5 CANOPY TREES REQ'D/100 LF
(150/100)*2.5 ~ 3.75 CANOPY TREES REQ'D
2 EXISTING CANOPY TREES TO REMAIN (T-1 & T-2)
PLANT 2 CANOPY TREES
2.0 UNDERSTORY TREES REQ'D/100 LF
(150/100)*2.0 ~ 3 UNDERSTORY TREES REQ'D
PLANT 3 UNDERSTORY TREES
20 SHRUBS REQ'D/100 LF
(150/100)*20 ~ 30 SHRUBS REQ'D
PLANT 30 SHRUBS

WEST BOUNDARY LINE: PROVIDE TYPE 'B' BUFFER AS PER 2-2.3(c) DESIGN STANDARDS MANUAL (NON-RESIDENTIAL ADJUTING SINGLE FAMILY RESIDENTIAL) SUPPLEMENTED W/6' TIMBER PRIVACY FENCE: 16' WIDE x 175' LONG BUFFER

2.5 CANOPY TREES REQ'D/100 LF
(175/100)*2.5 ~ 4.38 CANOPY TREES REQ'D
2 EXISTING CANOPY TREES TO REMAIN (T-4 & T-5)
PLANT 3 CANOPY TREES
2.0 UNDERSTORY TREES REQ'D/100 LF
(175/100)*2.0 ~ 3.5 UNDERSTORY TREES REQ'D
PLANT 4 UNDERSTORY TREES
20 SHRUBS REQ'D/100 LF
(175/100)*20 ~ 35 SHRUBS REQ'D
PLANT 35 SHRUBS

SOUTH BOUNDARY LINE: NO BUFFER REQUIRED, YOAKUM STREET RIGHT OF WAY. PROVIDE 5' LANDSCAPE STRIP AS PER CH. 2, ART. 2, SEC. 2-2.2(b) DESIGN STANDARDS MANUAL

PLANT SOUTHERN MAGNOLIA
TYP. OF 5

PLANT WAX MYRTLE
TYP. OF 10

PLANT RED MAPLE
TYP. OF 4

PLANT INDIAN
HAWTHORN SHRUB
TYP. OF 94

PROVIDE A MINIMUM 50'
SEPARATION BETWEEN
CANOPY TREES TO BE
PLANTED AND EXISTING
OVERHEAD UTILITIES

PROPOSED
3,600 SF
PRIVATE STORAGE
BUILDING
FFE: 93.35

(P)YOAKUM COURT ~ (F)YOAKUM STREET
(50' PUBLIC R/W)

46-1S-30-2001-002-021
GONZALEZ JOSE A
GONZALEZ MARIA E
215 MICHIGAN AVE
PENSACOLA, FL 32505
ZONING: HC/LI
FLU: MU-U
USE: SINGLE FAMILY RESIDENCE

46-1S-30-2001-015-021
INGRAM RENTAL PROPERTIES LLC
6012 WYNDI WAY
PACE, FL 32571
ZONING: HC/LI
FLU: MU-U
USE: MULTI-FAMILY


HAMMOND ENGINEERING, INC.
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SITE DEVELOPMENT
PLANS FOR
FRONTIER MOTORS
PRIVATE STORAGE
LANDSCAPING PLAN


DRAWN BY: DUG
DESIGNED BY: RLS
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DATE: 9-5-20
SCALE: AS SHOWN
NOT RELEASED FOR
CONSTRUCTION
BY: DATE:

PROJECT NO: 20-035


SHEET: C7

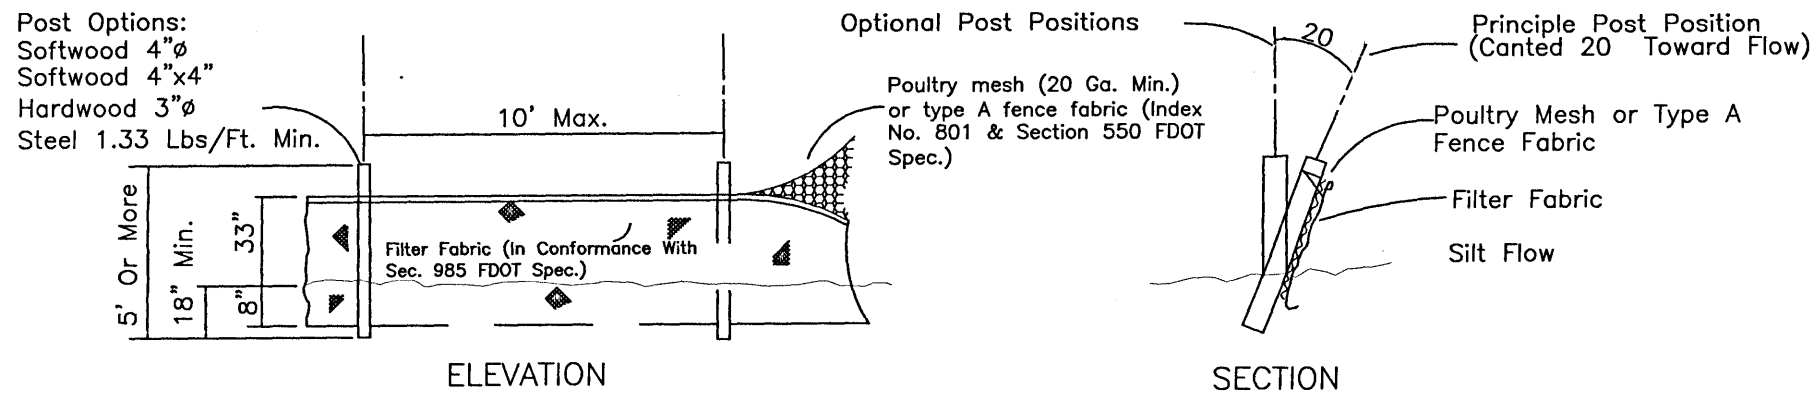

TYPE IV SILT FENCE
NTS

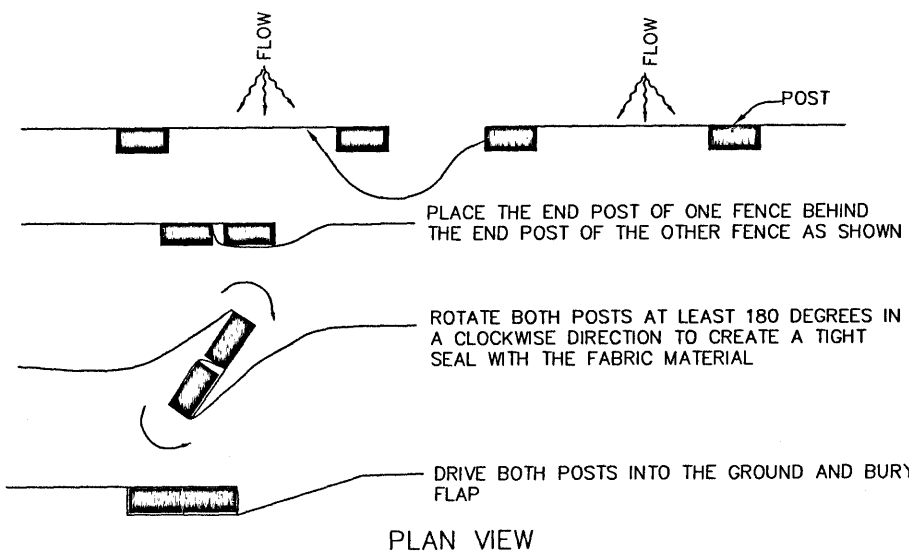


JOINING TWO SILT FENCES
NTS

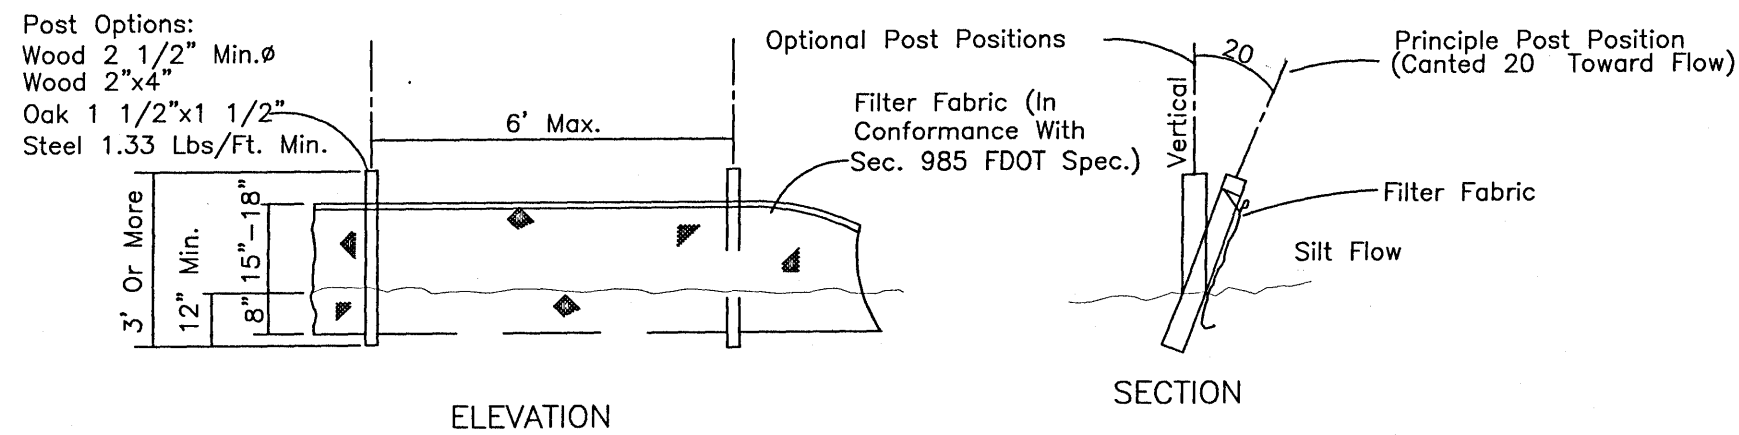


TYPE III SILT FENCE
NTS


- NOTES FOR SILT FENCES:**
1. TYPE III SILT FENCE TO BE USED AT MOST LOCATIONS. WHERE USED IN DITCHES, THE SPACING FOR TYPE III SILT FENCE SHALL BE IN ACCORDANCE WITH CHART 1 (FOUND BELOW)
 2. TYPE IV SILT FENCE TO BE USED WHERE LARGE SEDIMENT LOADS ARE ANTICIPATED. SUGGESTED USE IS WHERE FILL, SLOPE IS 1:2 OR STEEPER AND LENGTH OF SLOPE EXCEEDS 25'. AVOID USE WHERE THE DETAINED WATER MAY BACK INTO TRAVEL LANES OR ADJACENT PROPERTY.
 3. DO NOT CONSTRUCT SILT FENCES ACROSS PERMANENT FLOWING WATER COURSES. SILT FENCES ARE TO BE USED AT UPLAND LOCATIONS AND TURBIDITY BARRIERS USED AT PERMANENT BODIES OF WATER.
 4. WHERE USED AS SLOPE PROTECTION, SILT FENCE IS TO BE CONSTRUCTED ON OR LONGITUDINAL GRADE TO AVOID CHANNELIZING RUNOFF ALONG THE LENGTH OF THE FENCE.

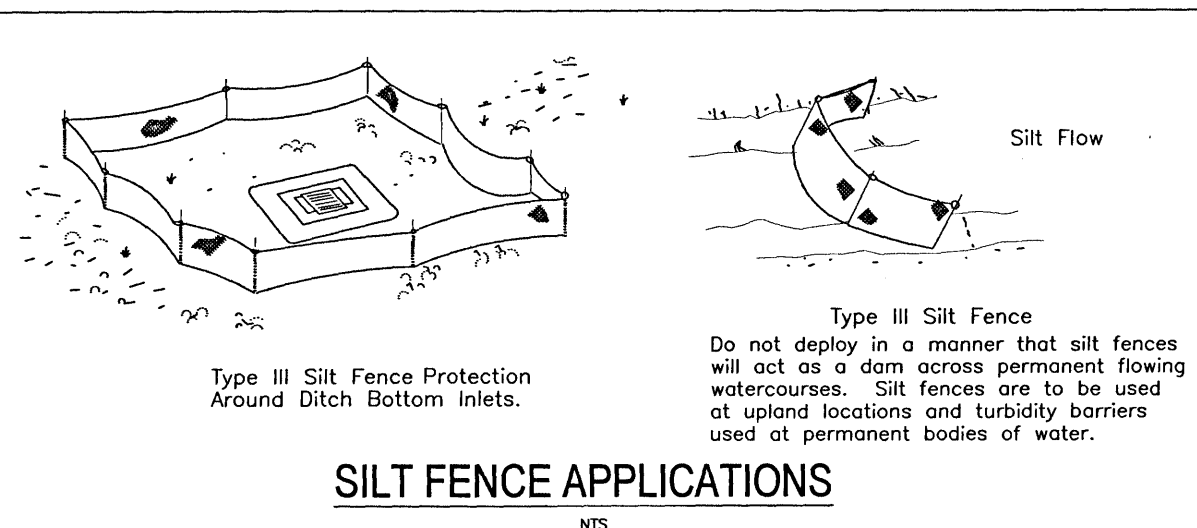


SILT FENCE APPLICATIONS
NTS

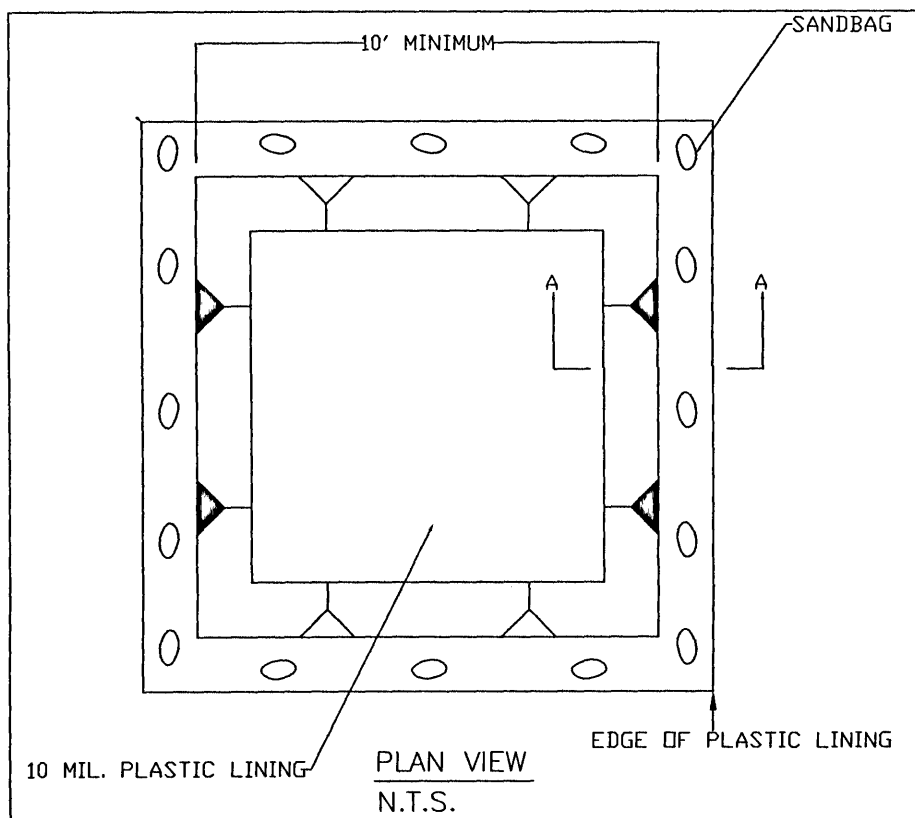


CONCRETE WASHOUT DETAIL
NTS

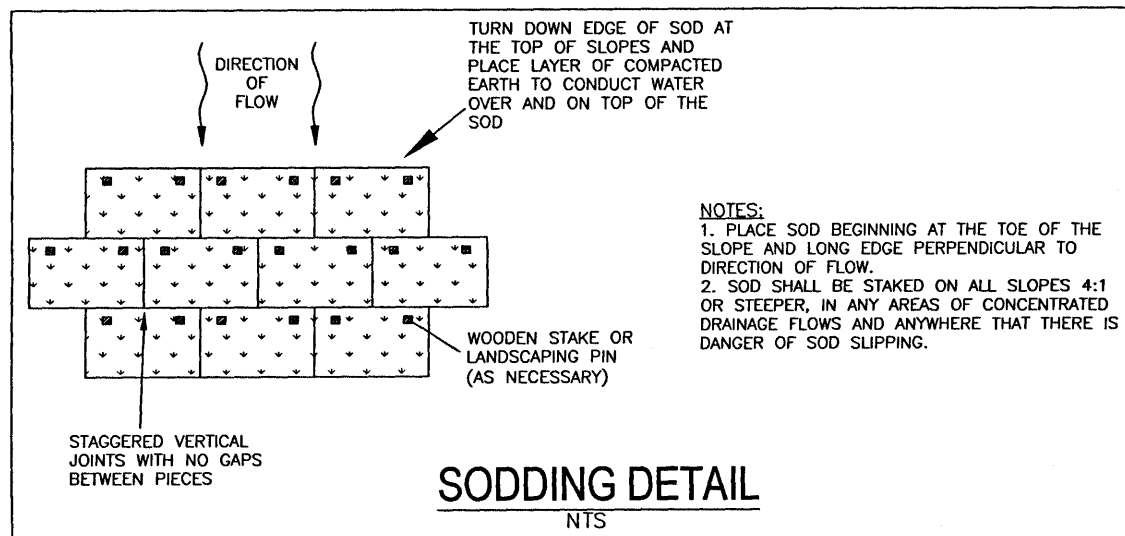

SODDING DETAIL
NTS

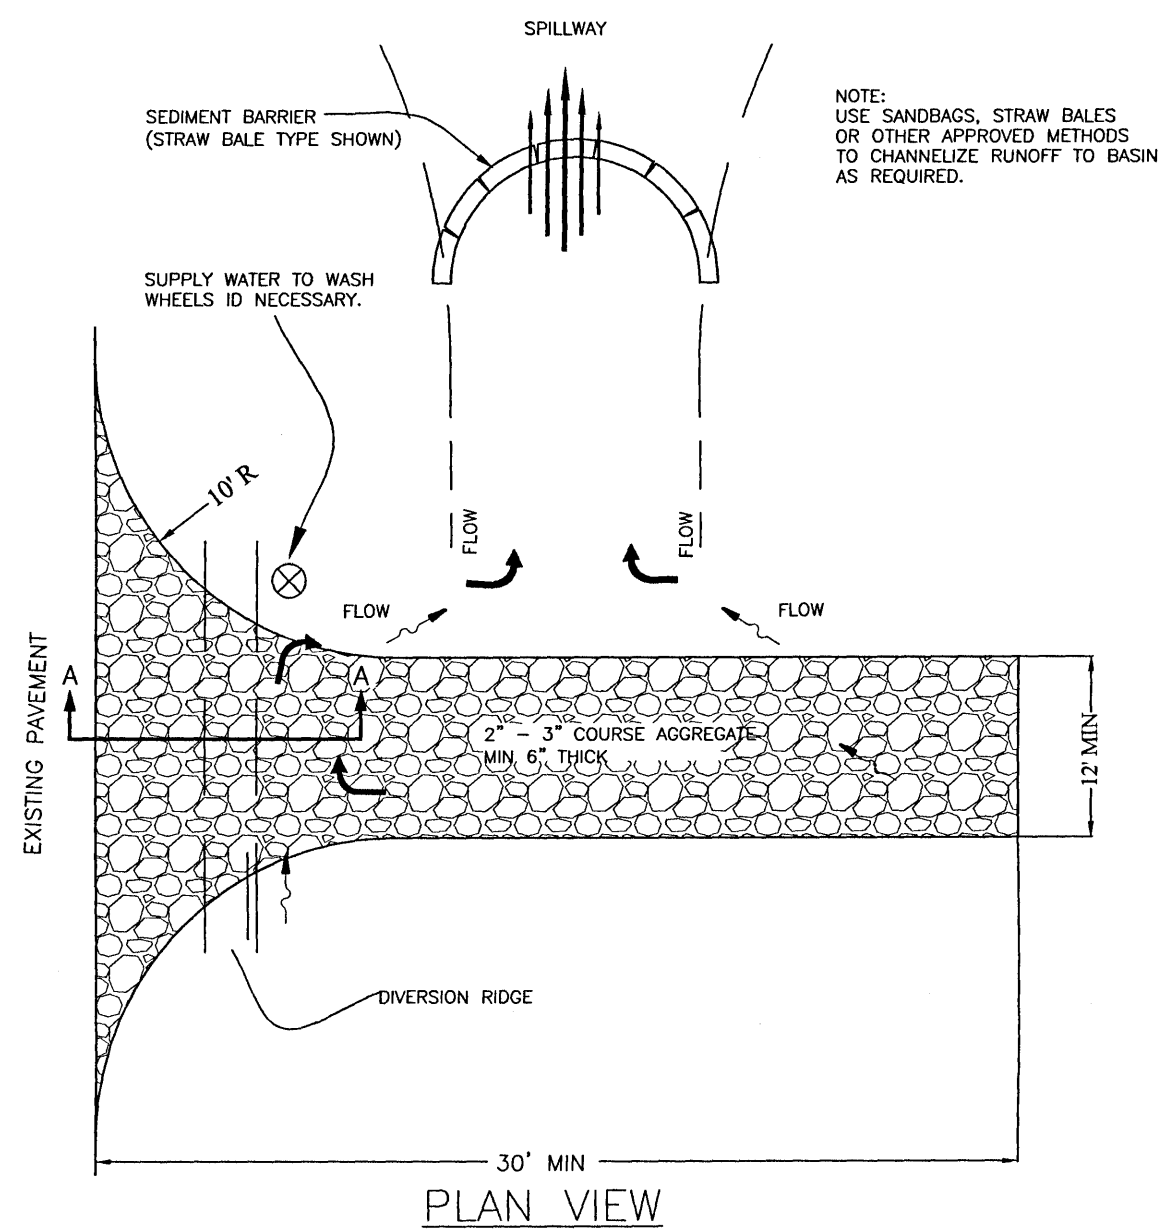

TEMPORARY GRAVEL CONSTRUCTION ENTRANCE TO BE CONSTRUCTED AT ALL DESIGNATED CONSTRUCTION ENTRANCES AND EXITS.

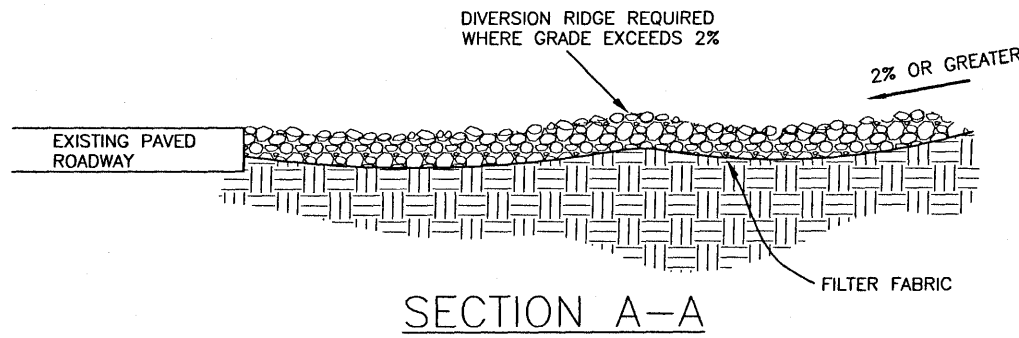


TEMPORARY CONSTRUCTION ENTRANCE
NTS

- NOTES:**
1. THE ENTRANCE SHALL BE MAINTAINED IN A CONDITION THAT WILL PREVENT TRACKING OR FLOWING OF SEDIMENT ONTO PUBLIC RIGHTS-OF-WAY. THIS MAY REQUIRE TOP DRESSING, REPAIR AND/OR CLEANOUT OF ANY MEASURES USED TO TRAP SEDIMENT.
 2. WHEN NECESSARY, WHEELS SHALL BE CLEANED PRIOR TO ENTRANCE ONTO PUBLIC RIGHT-OF-WAY.
 3. WHEN WASHING IS REQUIRED, IT SHALL BE DONE ON AN AREA STABILIZED WITH CRUSHED STONE THAT DRAINS INTO AN APPROVED SEDIMENT TRAP OR SEDIMENT BASIN.

Offsite vehicle tracking of sediments and geration of dust shall be minimized. A stabilized construction access road shall be utilized to reduce off-site tracking. Offsite sediment removal should be conducted at a frequency necessary to minimize impacts. Vehicle wash area should be considered if offsite tracking becomes excessive.


List of Recommended Native and Non-Invasive Plants		
Shrubs (mature height 36" min.)	Understory Trees (mature height 15-29 feet)	Canopy Trees (mature height over 30 feet)
<i>Abelia grandiflora</i>	Flowering Dogwood	Red Maple
<i>Abelia grandiflora</i>	<i>Cornus florida</i>	<i>Acer rubrum</i>
<i>Aucuba japonica</i>	Loblolly Bay	Silver Maple
<i>Aucuba</i>	<i>Gordonia lasianthus</i>	<i>Acer saccharum</i>
Barberry	American Holly	American Hornbeam
<i>Berberis sp.</i>	<i>Nez opaca</i>	<i>Carpinus caroliniana</i>
Japanese Boxwood	Dahoon Holly	Southern Red Cedar
<i>Buxus microphylla</i>	<i>Nez cassine</i>	<i>Juniperus silicicola</i>
Beauty Berry	Crope Myrtle	Leyland Cypress
<i>Callicarpa Americana</i>	<i>Lagerstroemia indica</i>	<i>Cupressocyparis leylandii</i>
Japanese Plum-Yew	Glossy Privet	River Birch
<i>Cephalotaxus harringtonia</i>	<i>Ligustrum lucidum</i>	<i>Betula nigra</i>
Silverhorn Eleagnus	Saucer Magnolia	Pignut Hickory
<i>Elaeagnus pungens</i>	<i>Magnolia z soulangiana</i>	<i>Carya glabra</i>
Fatsia	Sweetbay Magnolia	Green Ash
<i>Fatsia japonica</i>	<i>Magnolia virginiana</i>	<i>Fraxinus pennsylvanica</i>
Gardenia	Southern Crab Apple	Maidenhair Tree
<i>Gardenia jasminoides</i>	<i>Maltus angustifolia</i>	<i>Ginkgo biloba (male)</i>
Burford Holly	Wax Myrtle	Sweetgum
<i>Nez cornuta</i>	<i>Myrica cerifera</i>	<i>Liquidambar styraciflua</i>
Japanese Privet	Bradford Pear	Tulip Poplar
<i>Ligustrum japonicum</i>	<i>Pyrus calleryana</i>	<i>Liriodendron tulipifera</i>
Southern Wax Myrtle	Yaupon Holly	Southern Magnolia
<i>Myrica cerifera</i>	<i>Nez vomitoria</i>	<i>Magnolia grandiflora</i>
Firethorn	Loquat	Tupelo/Sour Gum
<i>Pyracantha coccin</i>	<i>Eriobotrya japonica</i>	<i>Nyssa sylvatica</i>
Dwarf Japanese Holly	Eastern Redbud	Slash Pine
<i>Nez crenata</i>	<i>Cercis canadensis</i>	<i>Pinus elliottii</i>
Chinese Holly	Fringe Tree	Longleaf Pine
<i>Nez Cornuta</i>	<i>Chionanthus virginicus</i>	<i>Pinus palustris</i>
Dwarf Yaupon Holly	Hawthorn	Sycamore
<i>Nez vomitoria 'Nana'</i>	<i>Crataegus spp.</i>	<i>Plantanus occidentalis</i>
Chinese Juniper	Silverbell	White Oak
<i>Juniperus chinensis</i>	<i>Halesia caroliniana</i>	<i>Quercus alba</i>
Indian Hawthorn		Live Oak
<i>Raphiolepis sp.</i>		<i>Quercus virginiana</i>
Red-Tip Photinia		Shumard Oak
<i>Photinia</i>		<i>Quercus shumardii</i>
Rhododendron/Azalea		Southern Red Oak
<i>Rhododendron sp.</i>		<i>Quercus falcate</i>

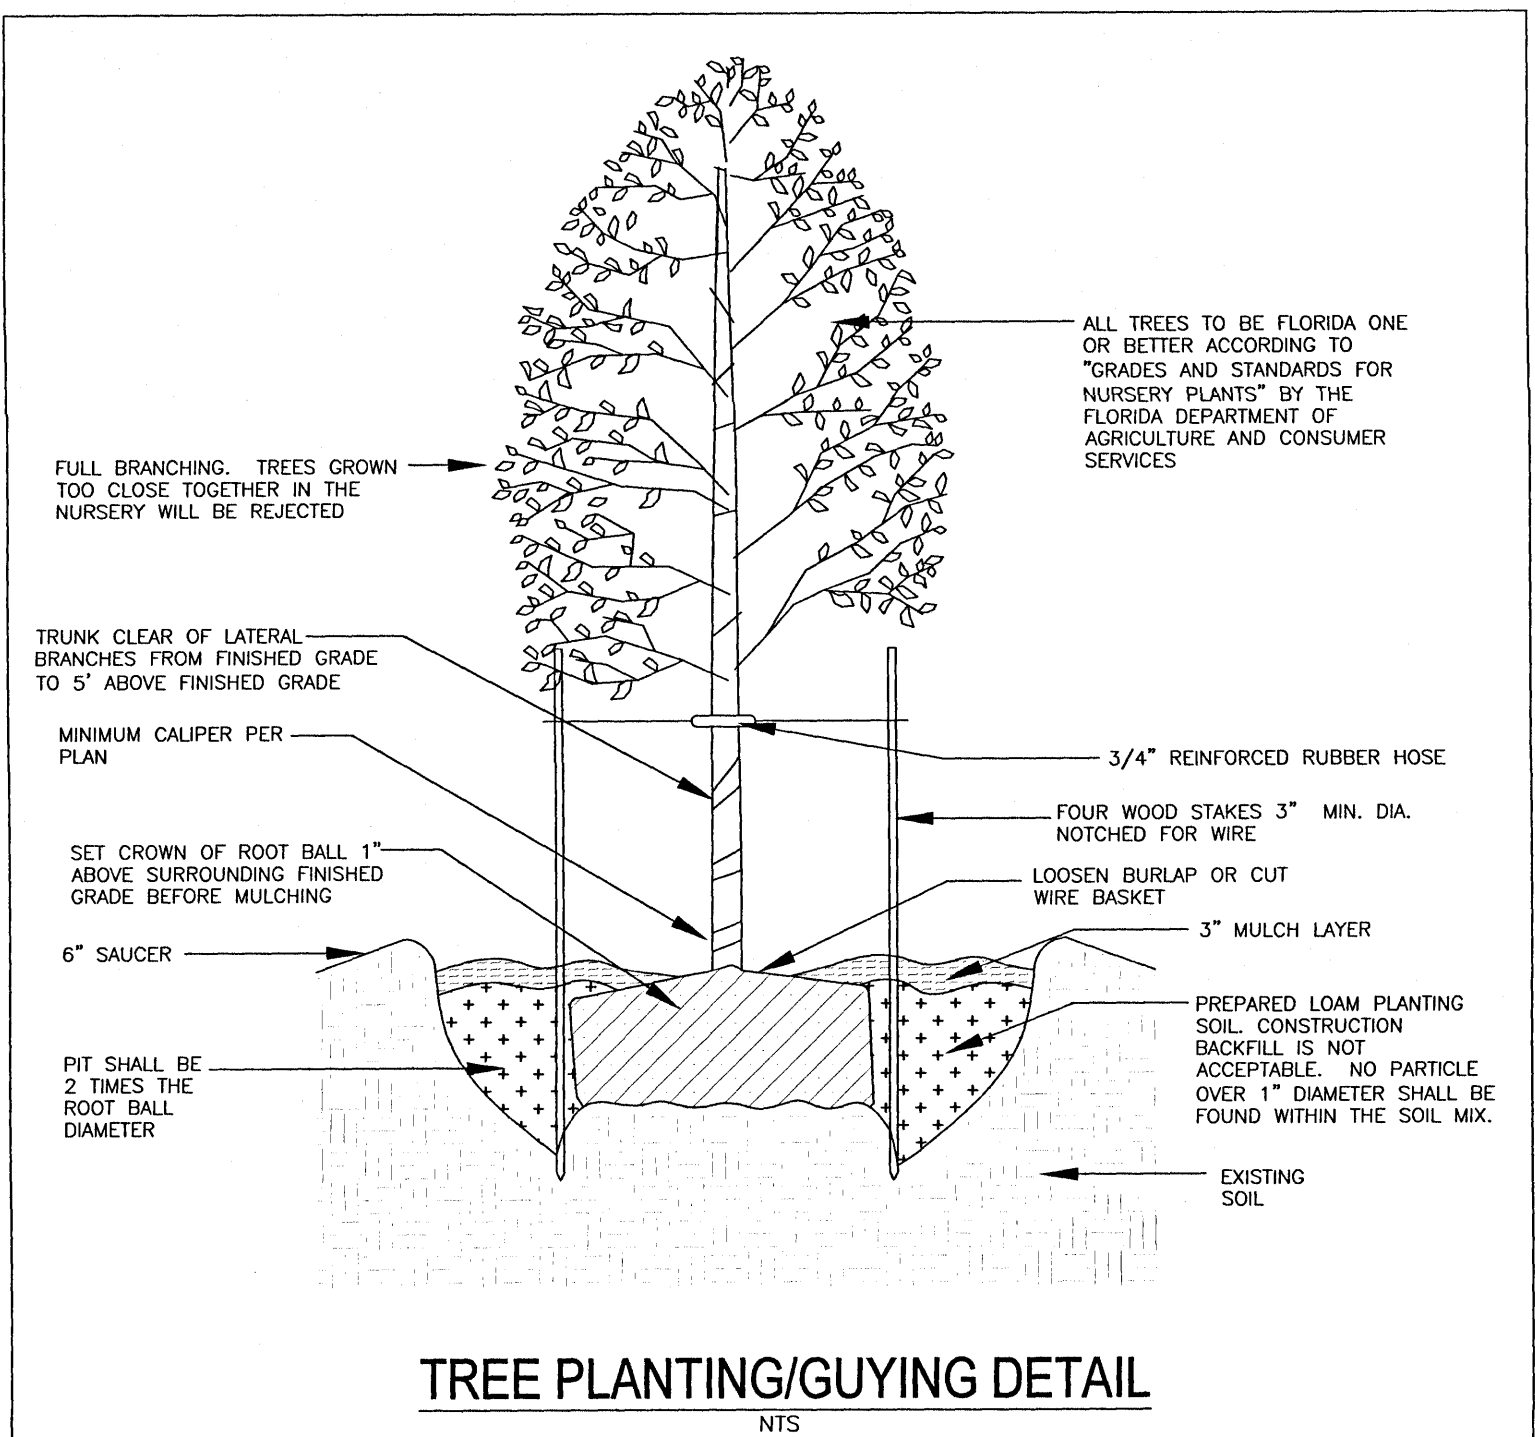

TREE PLANTING/GUYING DETAIL
NTS


TREE PROTECTION BARRICADES SHOULD BE PLACED AT THE PERIMETER OF EACH PROTECTED TREE'S CRITICAL ROOT ZONE. THE CRITICAL ROOT ZONE (CRZ) IS REPRESENTED BY A CIRCLE, CENTERED ON THE TREE TRUNK AND HAVING A RADIUS OF ONE FOOT FOR EACH ONE INCH OF TRUNK DIAMETER (DBH)

NO UN-PERMITTED GRADING OR CLEARING BY HEAVY EQUIPMENT SHOULD HAPPEN UNDER THE CRITICAL ROOT ZONE OF PROTECTED TREES TO REMAIN ON THE SITE. STORAGE OF HEAVY EQUIPMENT SHALL NOT OCCUR UNDER THE CRITICAL ROOT ZONE OF PROTECTED TREES ON SITE.

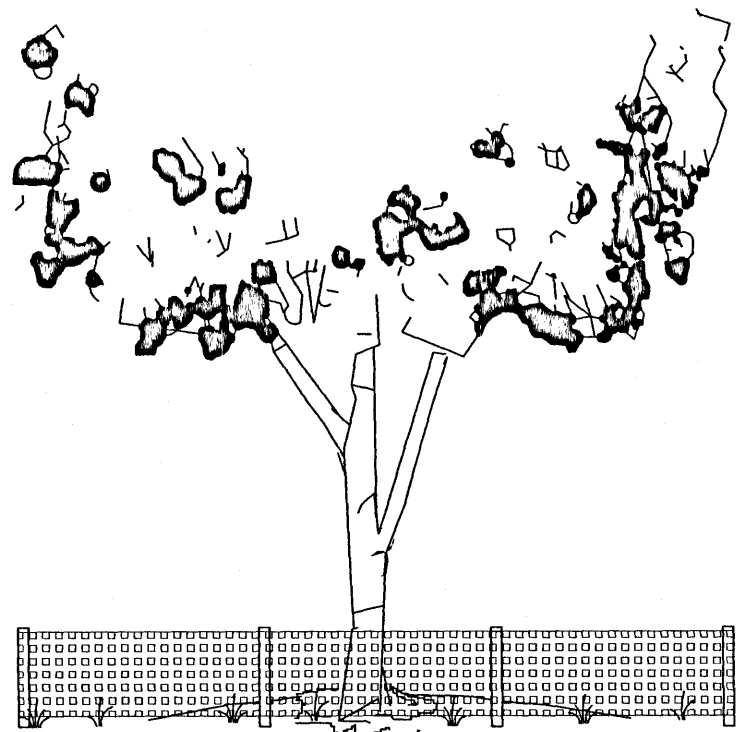

PROPERLY CONSTRUCTED BARRICADE PROTECTS THE TOTAL AREA WITHIN THE CRITICAL ROOT ZONE. CRITICAL ROOT ZONE OF A TREE IS REPRESENTED BY A CIRCLE, CENTERED ON THE TREE TRUNK AND HAVING A RADIUS OF ONE FOOT FOR EACH ONE INCH OF TRUNK DIAMETER (DBH)

TREE PROTECTION BARRIER

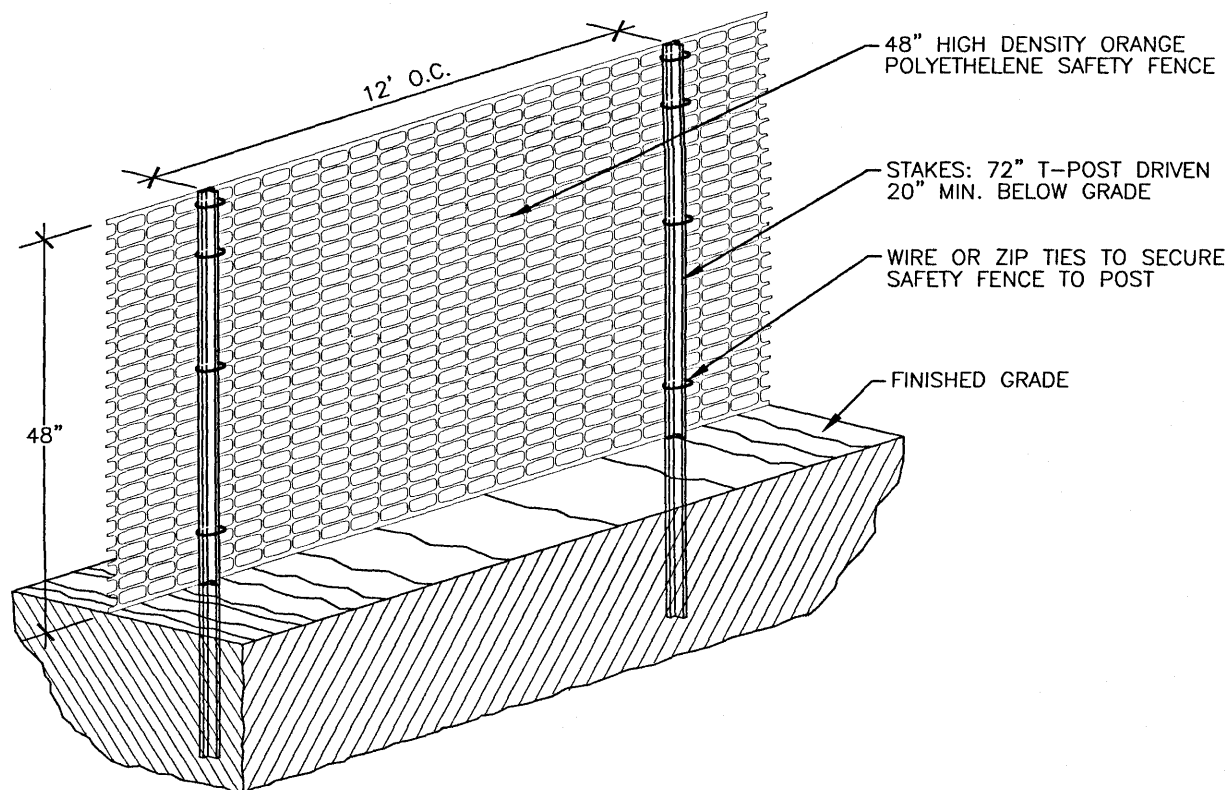


SENSITIVE AREA/TREE PROTECTION BARRIER

- NOTES:**
1. ALL SENSITIVE AREAS SHALL BE PROTECTED INCLUDING DEEP EXCAVATIONS AND AS INDICATED ON PLANS.
 2. ALL TREES IN THE CONSTRUCTION AREA NOT SPECIFICALLY DESIGNATED FOR REMOVAL SHALL BE PRESERVED AND PROTECTED WITH HIGH VISIBILITY FENCE AS PER PLAN.
 3. TREE PROTECTION BARRIER SHOULD BE PLACED, AND MAINTAINED IN GOOD WORKING ORDER, AROUND THE PERIMETER OF EACH PROTECTED TREE'S CRITICAL ROOT ZONE (CRZ) OF ALL PROTECTED TREES MARKED FOR PRESERVATION PRIOR TO ANY LAND DISTURBANCE CONSISTENT WITH THE DEVELOPMENT PERMIT.
 4. SAFETY FENCE SHOULD BE FASTENED SECURELY TO THE T-POSTS.
 5. THE FENCING MUST REMAIN IN PLACE DURING ALL PHASES OF CONSTRUCTION; ANY CHANGE OF THE PROTECTIVE FENCING MUST BE APPROVED.
 6. NO UN-PERMITTED GRADING OR CLEARING BY HEAVY EQUIPMENT SHOULD OCCUR UNDER THE CRITICAL ROOT ZONE OF PROTECTED TREES TO REMAIN ON THE SITE. STORAGE OF HEAVY EQUIPMENT SHALL NOT OCCUR UNDER THE CRITICAL ROOT ZONE OF PROTECTED TREES ON SITE.
 7. ALL DAMAGED ROOTS ARE TO BE EXPOSED TO SOUND TISSUE AND SEVERED CLEANLY (NOT TORN). ROOTS SHALL BE PRUNED CLEANLY TO A DEPTH OF 18 INCHES BELOW THE EXISTING GRADE OR TO THE DEPTH OF DISTURBANCE IF LESS THAN 18 INCHES FROM EXISTING GRADE.

NO.	DATE	REVISIONS
1	11/11/2020	REVISED PLANS AS PER ESCAMBIA COUNTY DRC REVIEW COMMENTS


HAMMOND ENGINEERING, INC.
FLORIDA AUTHORIZATION NO. 9130
ALABAMA AUTHORIZATION NO. 3277
3802 NORTH "S" STREET
PENSACOLA, FLORIDA 32505
850 434-2603
850 434-2603
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TOM@SELANDESIGN.COM

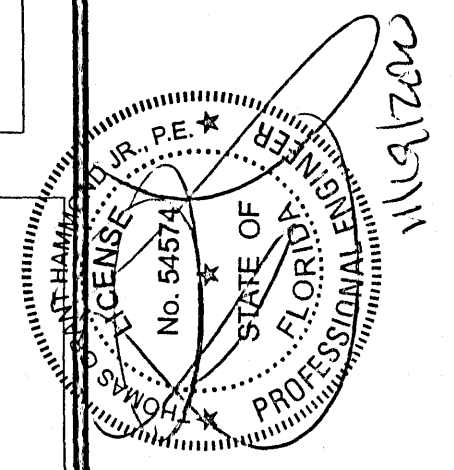

**SITE DEVELOPMENT
PLANS FOR
FRONTIER MOTORS
PRIVATE STORAGE
CONSTRUCTION
DETAILS**

DRAWN BY: CJB	DESIGNED BY: RLS
CHECKED BY: TGH	DATE: 9-3-20
SCALE: AS SHOWN	DATE: 9-3-20
NOT RELEASED FOR CONSTRUCTION	DATE: 9-3-20

PROJECT NO: 20-035
SHEET: C8

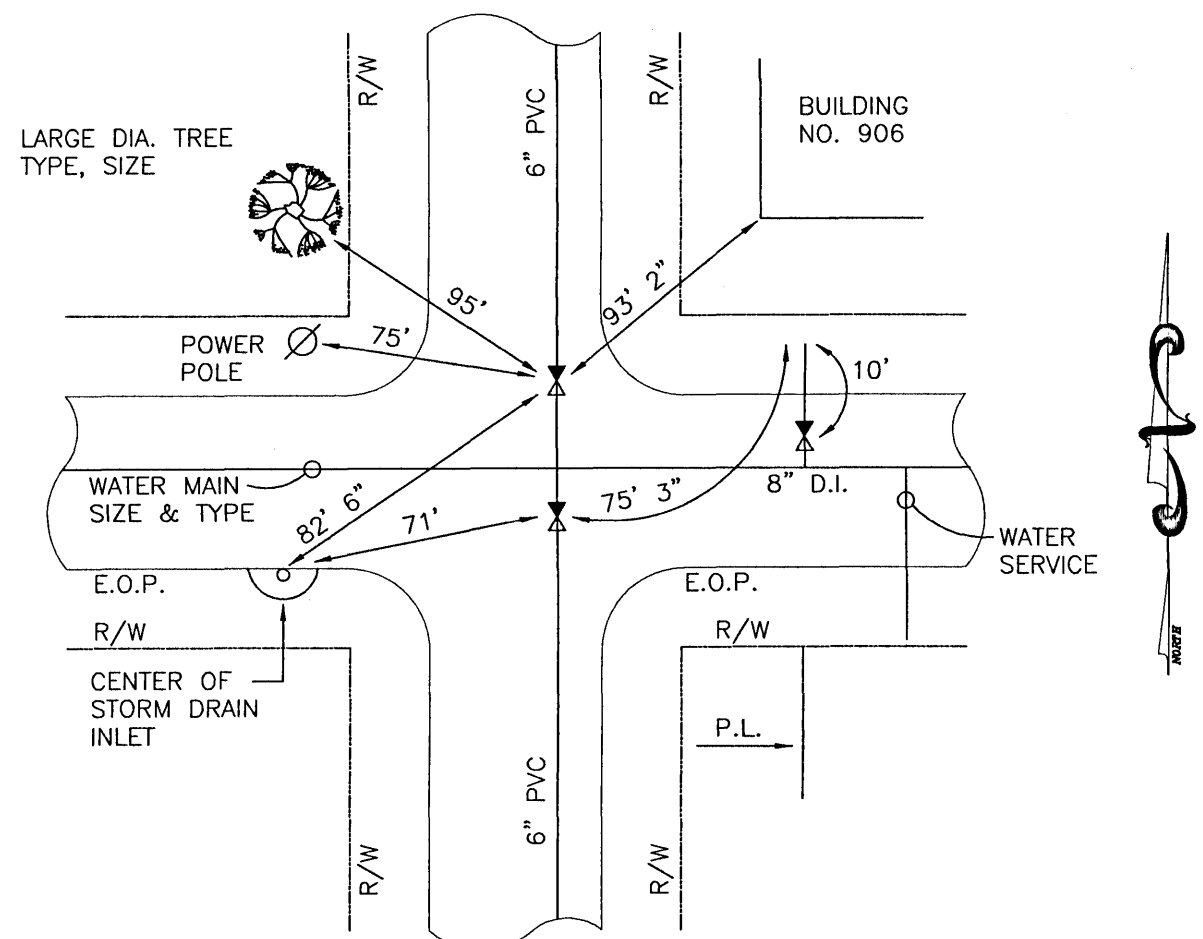


EXAMPLE FOR AS BUILT DRAWINGS OF WATER LINES AND VALVES

1. AS BUILT DRAWINGS WILL BE PREPARED INDICATING LOCATIONS OF ALL SERVICES, LOCATIONS AND TYPES OF ALL FITTINGS, WITH RESPECT TO LOT CORNERS, LOCATIONS OF ALL VALVE AND DEAD END RUNS WITH THREE (3) TIES TO PHYSICAL FEATURES (BUILDING CORNERS, MANHOLES, EXISTING STRUCTURES, POWER POLES, STORM DRAIN INLETS, CENTER OF FIRE HYDRANTS, FACE OF LARGE DIAMETER TREES > 18").
2. AS BUILT DRAWINGS MUST BE SUBMITTED TO THE ENGINEER FOR REVIEW AND APPROVAL BEFORE A LETTER OF ACCEPTANCE WILL BE ISSUED.
3. CONTRACTOR SHALL ALSO PROVIDE CERTIFIED AS-BUILTS BY A P.S.M. REGISTERED IN THE STATE OF FLORIDA IN DIGITAL AND HARD COPY SIGNED AND SEALED. THE AS-BUILTS SHALL BE IN STATE PLANE COORDINATES.

AS-BUILT REQUIREMENTS

N.T.S.

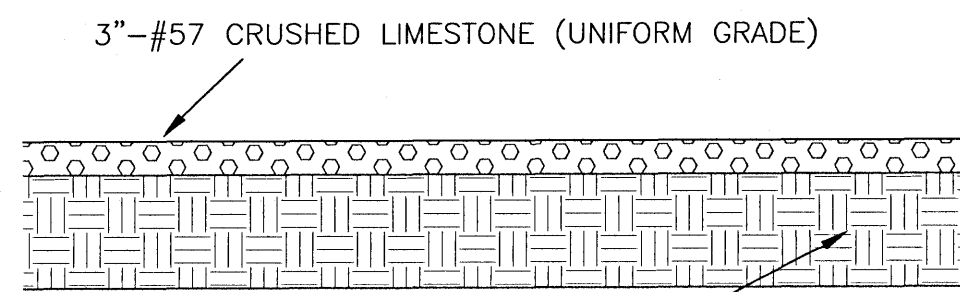


8" SUB GRADE COMPACTED TO 98% PER ASTM D 1557. MIN. LBR 40

TYPICAL ROCK PARKING LOT SECTION


N.T.S.

*NOTE: FINISHED SURFACE MUST WITHSTAND A MINIMUM OF 40 TONS

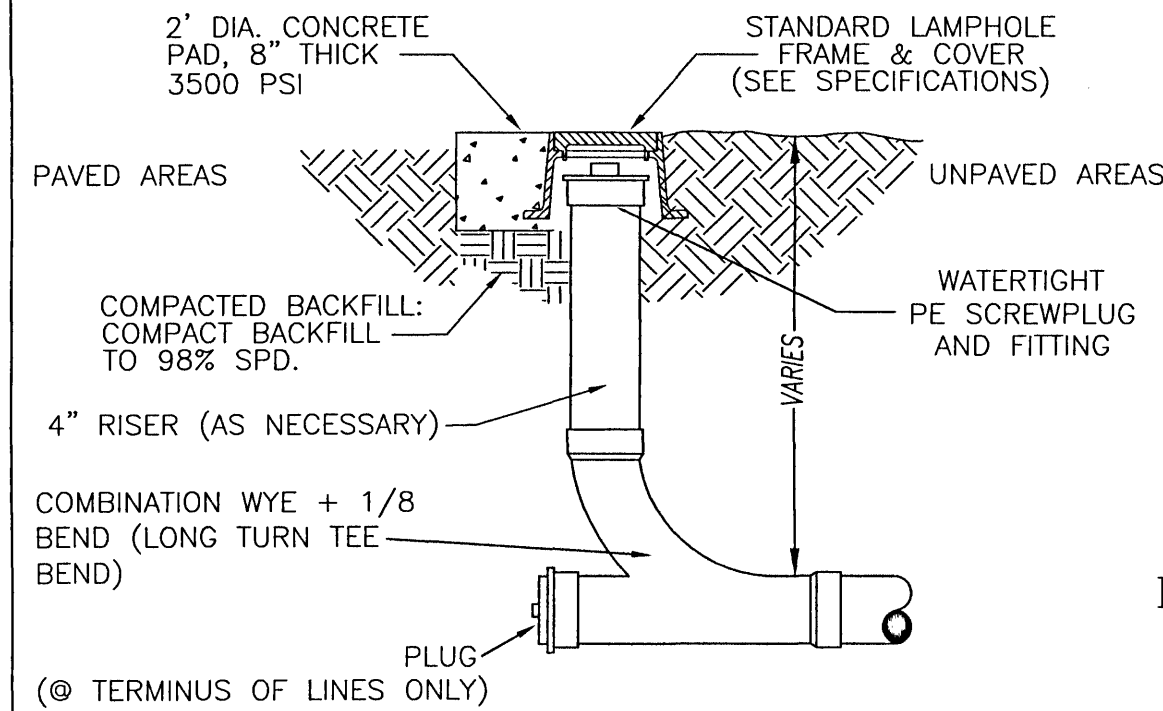

SANITARY CLEANOUT DETAIL


N.T.S.

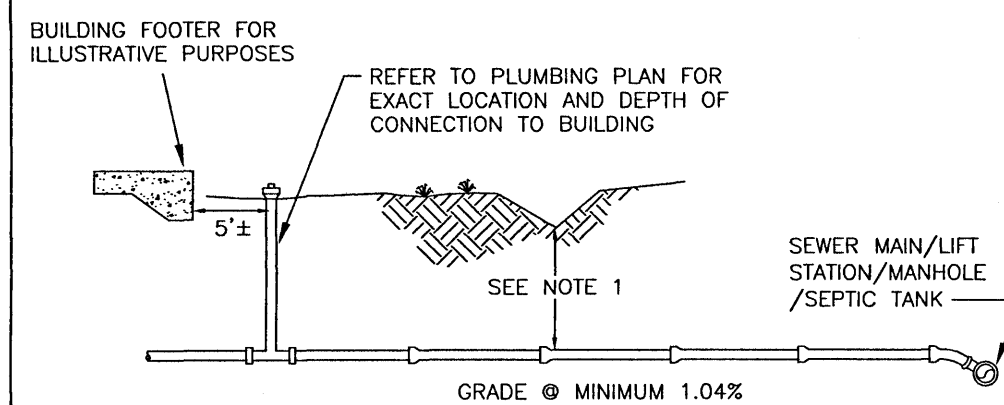

TYPICAL LATERAL SEWER SERVICE


N.T.S.

1. MAINTAIN 18" MINIMUM COVER OR USE 6 L.F. CONCRETE ENCASEMENT
2. ALL LATERALS TO BE 4" Ø PVC 3034 DR SEWER PIPE UNLESS FLOW DICTATES A LARGER DIAMETER.
3. A CLEAN OUT SHALL BE PROVIDED WITHIN 5 FT OF BUILDING WHERE THE SEWER LATERAL EXISTS

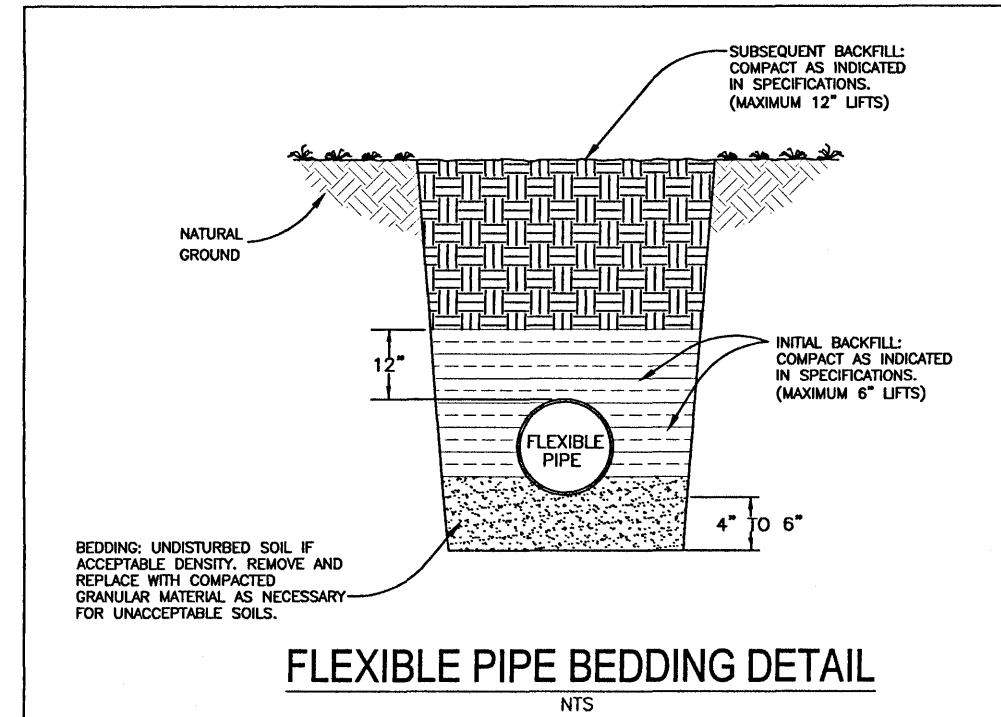

FLEXIBLE PIPE BEDDING DETAIL

N.T.S.

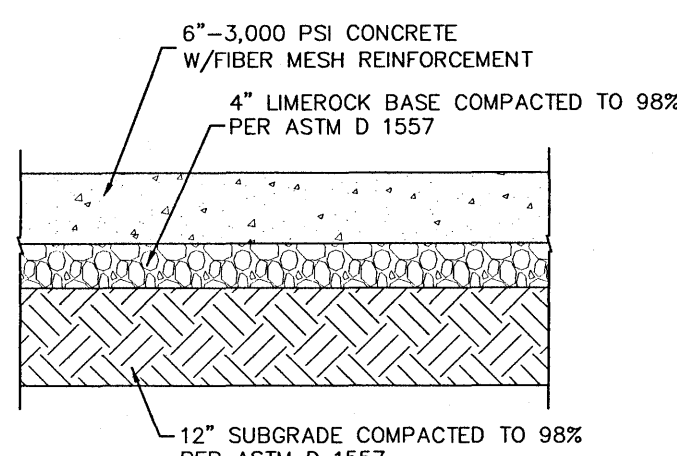


STANDARD CONCRETE SECTION

N.T.S.

NOTES:

1. SAWED OR SCORED CONTROL JOINTS SHALL BE SPACED AT 5 FT MAXIMUM FOR SIDEWALKS AND 12 FT FOR DRIVES.
2. CONSTRUCT EXPANSION JOINTS WHERE NEW CONCRETE ABUTS NEW OR EXISTING CONCRETE CURBS, ASPHALT, OR OTHER STRUCTURES AND/OR ON 40 FT CENTERS ON SIDEWALKS AND 30' CENTERS ON DRIVES.
3. THOROUGHLY CLEAN JOINT OF ALL SAND, SOIL AND MISC. DEBRIS. APPLY MASKING TAPE ALONG SIDES OF JOINT FOR TEMPORARY PROTECTION DURING SEALANT APPLICATIONS. APPLY FULL BEAD OF VULKEM 116 OR 245 (NON SAG), OR APPROVED EQUAL, POURABLE SEALANT AND TOOL LIGHTLY. REMOVE TAPE IMMEDIATELY.
4. ALL CONCRETE SHALL BE TYPE 1 AND MEET THE REQUIREMENTS OF THE APPROPRIATE SECTIONS OF THE FDOT STANDARD SPECIFICATIONS, LATEST EDITION, UNLESS OTHERWISE NOTED ON DETAILS OR PLANS.
5. MATERIAL, DESIGN AND TEST SUBMITTALS SHALL BE PER THE FDOT STANDARD SPECIFICATIONS, LATEST EDITION.

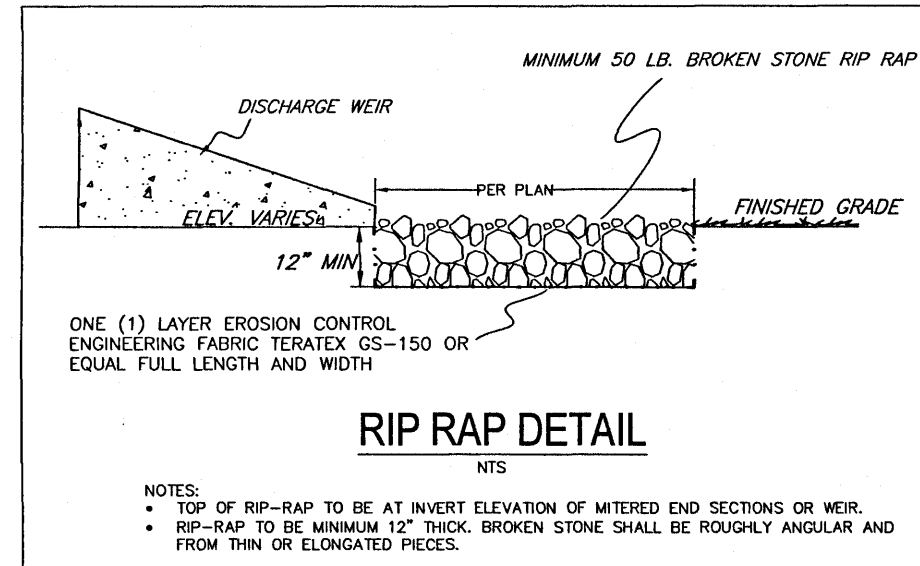


RIP RAP DETAIL

N.T.S.

1. TOP OF RIP-RAP TO BE AT INVERT ELEVATION OF MITERED END SECTIONS OR WEIR.
2. RIP-RAP TO BE MINIMUM 12" THICK. BROKEN STONE SHALL BE ROUGHLY ANGULAR AND FROM THIN OR ELONGATED PIECES.


NOTE: ALL DETAILS ILLUSTRATED PERTAIN TO ONSITE WORK ONLY. ALL WORK WITHIN PUBLIC R/W SHALL BE PERFORMED IN ACCORDANCE WITH THE CURRENT EDITION OF THE ECUA ENGINEERING MANUAL. CONTRACTOR TO REFERENCE ECUA ENGINEERING MANUAL FOR CONSTRUCTION DETAILS AND PROCEDURES.

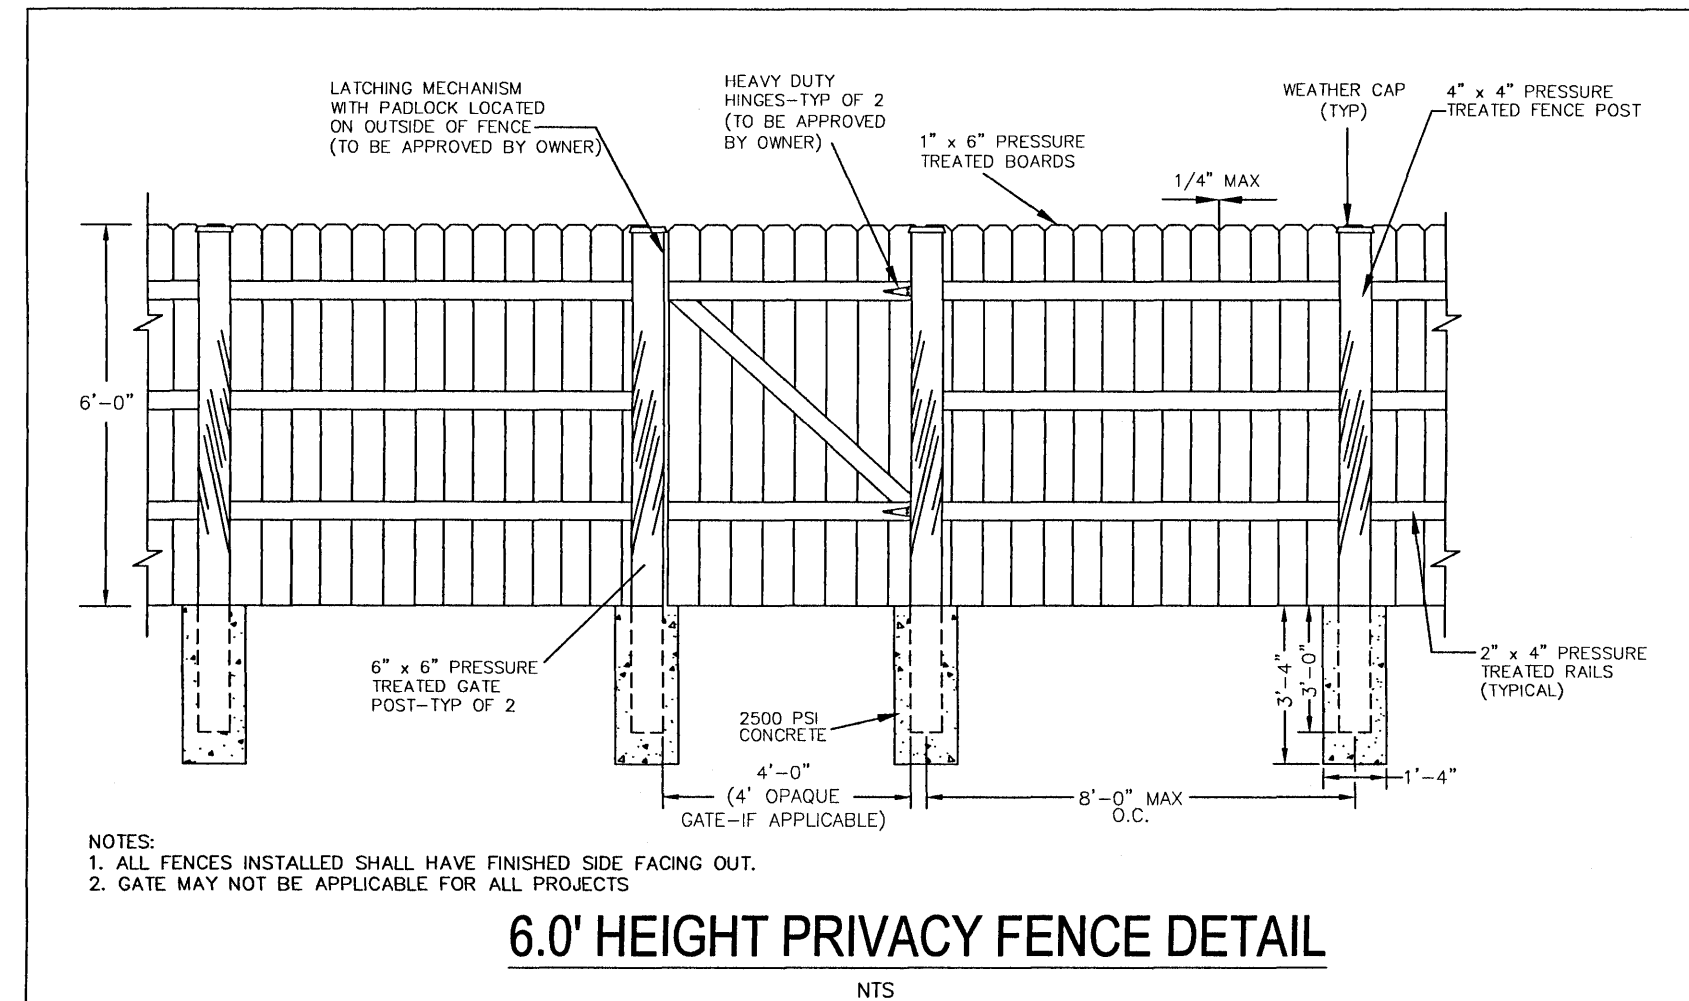

6.0' HEIGHT PRIVACY FENCE DETAIL


N.T.S.

1. ALL FENCES INSTALLED SHALL HAVE FINISHED SIDE FACING OUT.
2. GATE MAY NOT BE APPLICABLE FOR ALL PROJECTS

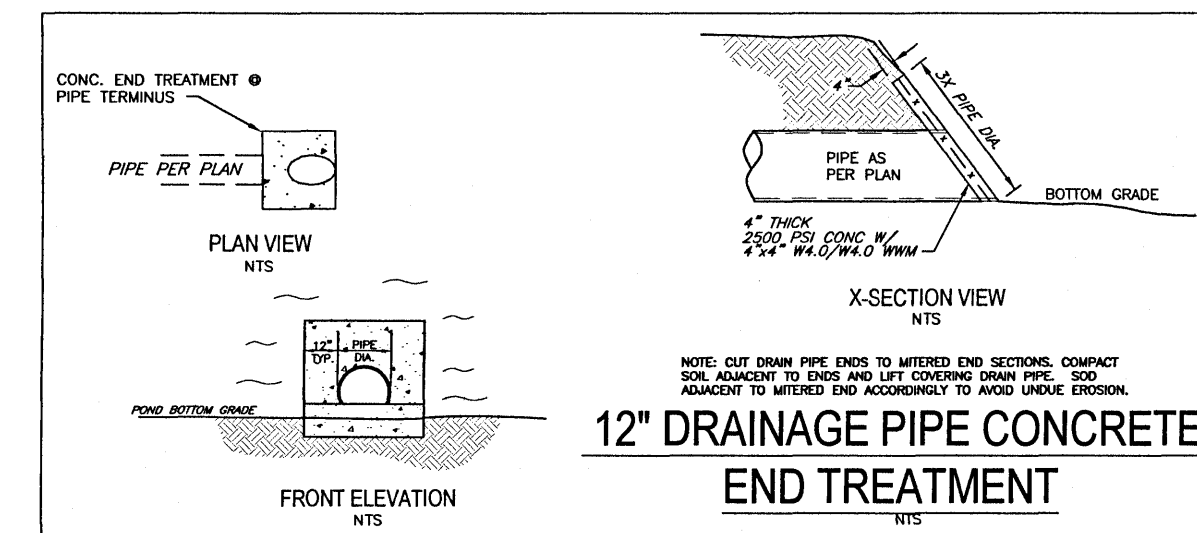

12" DRAINAGE PIPE CONCRETE END TREATMENT


N.T.S.

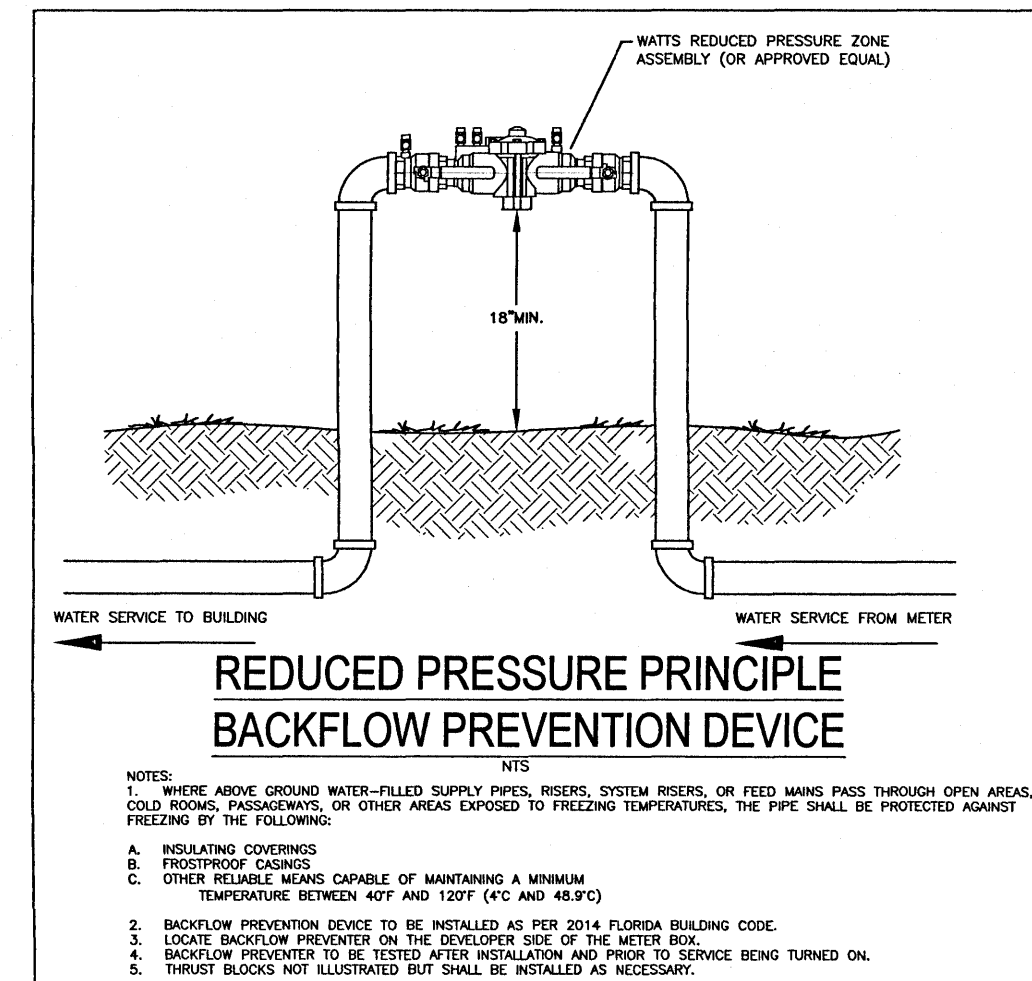

REDUCED PRESSURE PRINCIPLE BACKFLOW PREVENTION DEVICE


N.T.S.

1. WHERE ABOVE GROUND WATER-FILLED SUPPLY PIPES, RISERS, SYSTEM RISERS, OR FEED MAINS PASS THROUGH OPEN AREAS, OLD IRONS, PARAPETS, OR OTHER AREAS EXPOSED TO FREEZING TEMPERATURES, THE PIPE SHALL BE PROTECTED AGAINST FREEZING BY THE FOLLOWING:
- A. INSULATING COVERS
- B. PROTECTIVE CHIMNEYS
- C. OTHER RELIABLE MEANS CAPABLE OF MAINTAINING A MINIMUM TEMPERATURE BETWEEN 40°F AND 120°F (4°C AND 48.3°C)
2. BACKFLOW PREVENTION DEVICE TO BE INSTALLED AS PER 2014 FLORIDA BUILDING CODE.
3. LOCATE BACKFLOW PREVENTER ON THE DOWNHILL SIDE OF THE METER BOX.
4. BACKFLOW PREVENTER TO BE TESTED AFTER INSTALLATION AND PRIOR TO SERVICE BEING TURNED ON.
5. THROTTLE BLOCKS NOT ILLUSTRATED BUT SHALL BE INSTALLED AS NECESSARY.

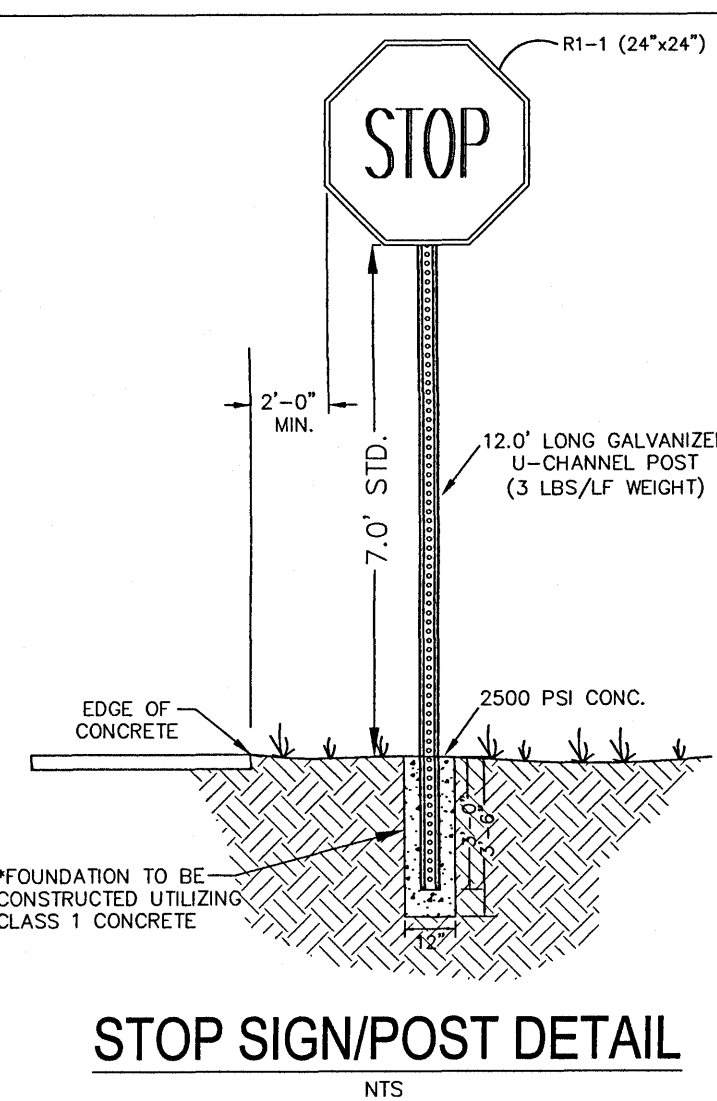

STOP SIGN/POST DETAIL

N.T.S.

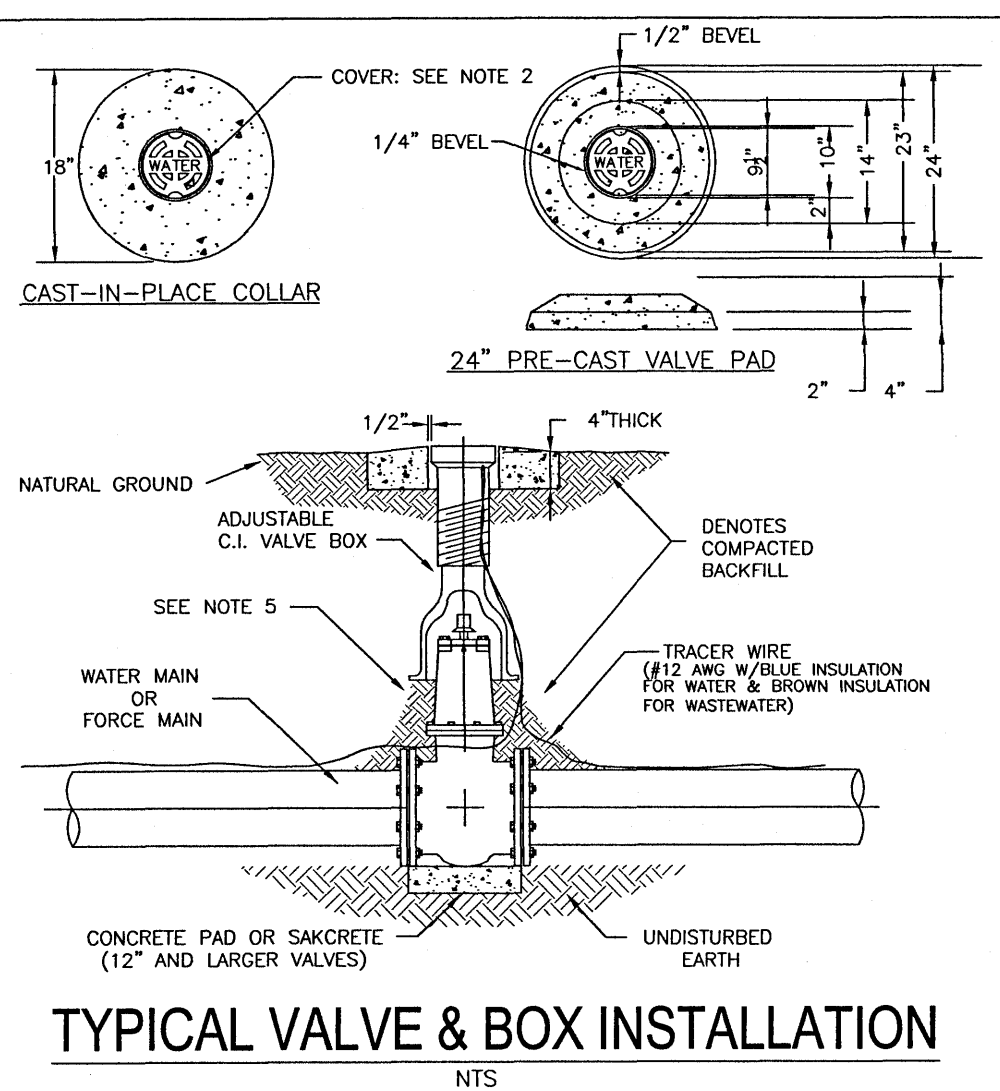

TYPICAL VALVE & BOX INSTALLATION

N.T.S.

1. VALVE BOX AND BOOT SHALL BE CAST IRON.
2. VALVE COVER SHALL BE MARKED "WATER" OR "SEWER" AS APPLICABLE.
3. VALVE BOX TOP SHALL BE FLUSH WITH FINISHED GRADE OR 1/2" ABOVE NATURAL GROUND LEVEL.
4. GATE VALVE SHALL BE RESILIENT SEAT WITH MECHANICAL JOINT ENDS OR APPROVED EQUIVALENT.
5. EARTH UNDER FLANGE OF VALVE BOX & COLLAR TO BE FIRM AND WELL TAMPED TO ENSURE AGAINST VALVE BOX SETTLING.

TYPICAL TRENCH CROSS-SECTION (N.T.S.)

NOTES:

1. ALL PIPE SYSTEMS SHALL BE INSTALLED IN ACCORDANCE WITH ASTM D2321, "STANDARD PRACTICE FOR UNDERGROUND INSTALLATION OF THERMOPLASTIC PIPE FOR SEWERS AND OTHER GRAVITY FLOW APPLICATIONS", LATEST ADDITION
2. MEASURES SHOULD BE TAKEN TO PREVENT MIGRATION OF NATIVE FINES INTO BACKFILL MATERIAL, WHEN REQUIRED.
3. FOUNDATION: WHERE THE TRENCH BOTTOM IS UNSTABLE, THE CONTRACTOR SHALL EXCAVATE TO A DEPTH REQUIRED BY THE ENGINEER AND REPLACE WITH SUITABLE MATERIAL AS SPECIFIED BY THE ENGINEER. AS AN ALTERNATIVE AND AT THE DISCRETION OF THE DESIGN ENGINEER, THE TRENCH BOTTOM MAY BE STABILIZED USING A GEOTEXTILE MATERIAL.
4. BEDDING: SUITABLE MATERIAL SHALL BE CLASS I, II OR III. THE CONTRACTOR SHALL PROVIDE DOCUMENTATION FOR MATERIAL SPECIFICATION TO ENGINEER. UNLESS OTHERWISE NOTED BY THE ENGINEER, MINIMUM BEDDING THICKNESS SHALL BE 4" (100mm) FOR 4"-24" (100mm-600mm); 6" (150mm) FOR 30"-60" (750mm-900mm).
5. INITIAL BACKFILL: SUITABLE MATERIAL SHALL BE CLASS I, II OR III IN THE PIPE ZONE EXTENDING NOT LESS THAN 6' ABOVE CROWN OF PIPE. THE CONTRACTOR SHALL PROVIDE DOCUMENTATION FOR MATERIAL SPECIFICATION TO ENGINEER. MATERIAL SHALL BE INSTALLED AS REQUIRED IN ASTM D2321, LATEST EDITION.
6. MINIMUM COVER: MINIMUM COVER, H, IN NON-TRAFFIC APPLICATIONS (GRASS OR LANDSCAPE AREAS) IS 12" FROM THE TOP OF PIPE TO GROUND SURFACE. ADDITIONAL COVER MAY BE REQUIRED TO PREVENT FLOATION. FOR TRAFFIC APPLICATIONS, MINIMUM COVER, H, IS 12" UP TO 48" DIAMETER PIPE AND 24" OF COVER FOR 54"-60" DIAMETER PIPE, MEASURED FROM TOP OF PIPE TO BOTTOM OF FLEXIBLE PAVEMENT OR TO TOP OF RIGID PAVEMENT.

HDPE PIPE-TYPICAL TRENCH INSTALLATION DETAIL

N.T.S.

RECOMMENDED MINIMUM TRENCH WIDTHS

PIPE DIA.	MIN. TRENCH WIDTH
4"	21"
6"	23"
8"	26"
10"	28"
12"	30"
15"	34"
18"	39"
24"	48"
30"	56"
36"	64"
42"	72"
48"	80"
54"	88"
60"	96"

MINIMUM RECOMMENDED COVER BASED ON VEHICLE LOADING CONDITIONS

PIPE DIA.	H-25 SURFACE LIVE LOADING CONDITION	HEAVY CONSTRUCTION (75T AXLE LOAD) *
12"-48"	12"	48"
54"-60"	24"	60"

* VEHICLES IN EXCESS OF 75T MAY REQUIRE ADDITIONAL COVER

MINIMUM RECOMMENDED COVER BASED ON RAILWAY LOADING CONDITIONS

PIPE DIA.	COOPER E-80**
UP TO 24"	24"
30"-36"	36"
42"-60"	48"

- ** COVER IS MEASURED FROM TOP OF PIPE TO BOTTOM OF RAILWAY TIE.
- *** E-80 COVER REQUIREMENTS, ARE ONLY APPLICABLE TO ASTM F 2306 PIPE.

OTHER PIPE	HORIZONTAL SEPARATION	CROSSINGS (1)	JOINT SPACING CROSSINGS (FULL JOINT CENTERED)
STORM SEWER, STORMWATER FORCE MAIN	WATER MAIN 3 FT. MINIMUM OTHER PIPE	WATER MAIN 12 INCHES IS THE MINIMUM, EXCEPT FOR STORM SEWER. THEN 6 INCHES IS THE MINIMUM AND 12 INCHES IS PREFERRED OTHER PIPE	WATER MAIN ALTERNATE 3 FT. MINIMUM
GRAVITY OR PRESSURE SANITARY SEWER, SANITARY SEWER FORCE MAIN	WATER MAIN 10 FT. PREFERRED 6 FT. MINIMUM (2) OTHER PIPE	WATER MAIN 12 INCHES IS THE MINIMUM, EXCEPT FOR GRAVITY SEWER. THEN 6 INCHES IS THE MINIMUM AND 12 INCHES IS PREFERRED OTHER PIPE	WATER MAIN ALTERNATE 6 FT. MINIMUM

- (1) WATER MAIN SHOULD CROSS ABOVE OTHER PIPE, WHEN WATER MAIN MUST BE BELOW OTHER PIPE, THE MINIMUM SEPARATION IS 12 INCHES.
- (2) 3 FT. GRAVITY SANITARY SEWER WHERE THE BOTTOM OF THE WATER MAIN IS LAID AT LEAST 6 INCHES ABOVE THE TOP OF THE GRAVITY SANITARY SEWER.


NOTES:

- A. INFORMATION PROVIDED FROM FDEP RULE 62-555. IF OTHER FDEP RULES CONFLICT, THEN USE THE MOST STRINGENT RULE.
- B. IF THERE ARE CONFLICTS IN THE SEPARATION REQUIREMENTS BETWEEN COLLECTION SYSTEMS AND DRINKING WATER FACILITIES ESTABLISHED IN FOOTNOTES (1) AND (2) ABOVE THOSE ESTABLISHED IN CHAPTER 62-532 OR 62-555, F.A.C., THEN THE REQUIREMENTS IN CHAPTER 62-532 OR 62-555, F.A.C., SHALL APPLY

WATER SEWER/SEPARATION

REVISIONS
NO. DATE
111/206/2010 REVISED PLANS AS PER ESCAMBIA COUNTY DRC REVIEW COMMENTS

HAMMOND ENGINEERING, INC.
FLORIDA AUTHORIZATION NO. 9130
ALABAMA AUTHORIZATION NO. 3277
3802 NORTH 5TH STREET
PENSACOLA, FLORIDA 32505
850 434-2603
FAX 850-434-2650
TOM@SELANDDESIGN.COM

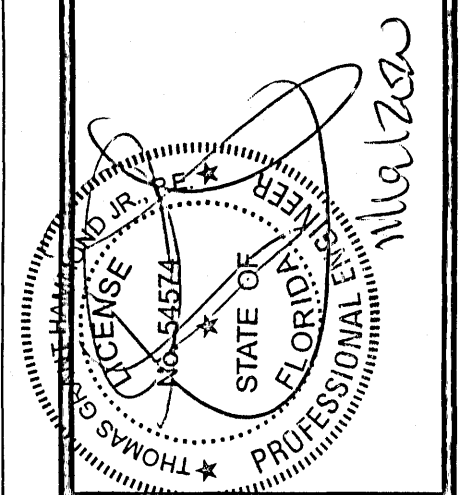


SITE DEVELOPMENT PLANS FOR FRONTIER MOTORS PRIVATE STORAGE CONSTRUCTION DETAILS


DRAWN BY: CUG
DESIGNED BY: RLS
CHECKED BY: TSH
DATE: 9-3-20
SCALE: AS SHOWN
NOT RELEASED FOR CONSTRUCTION
BY: DATE:

PROJECT NO: 20-035

SHEET: C9

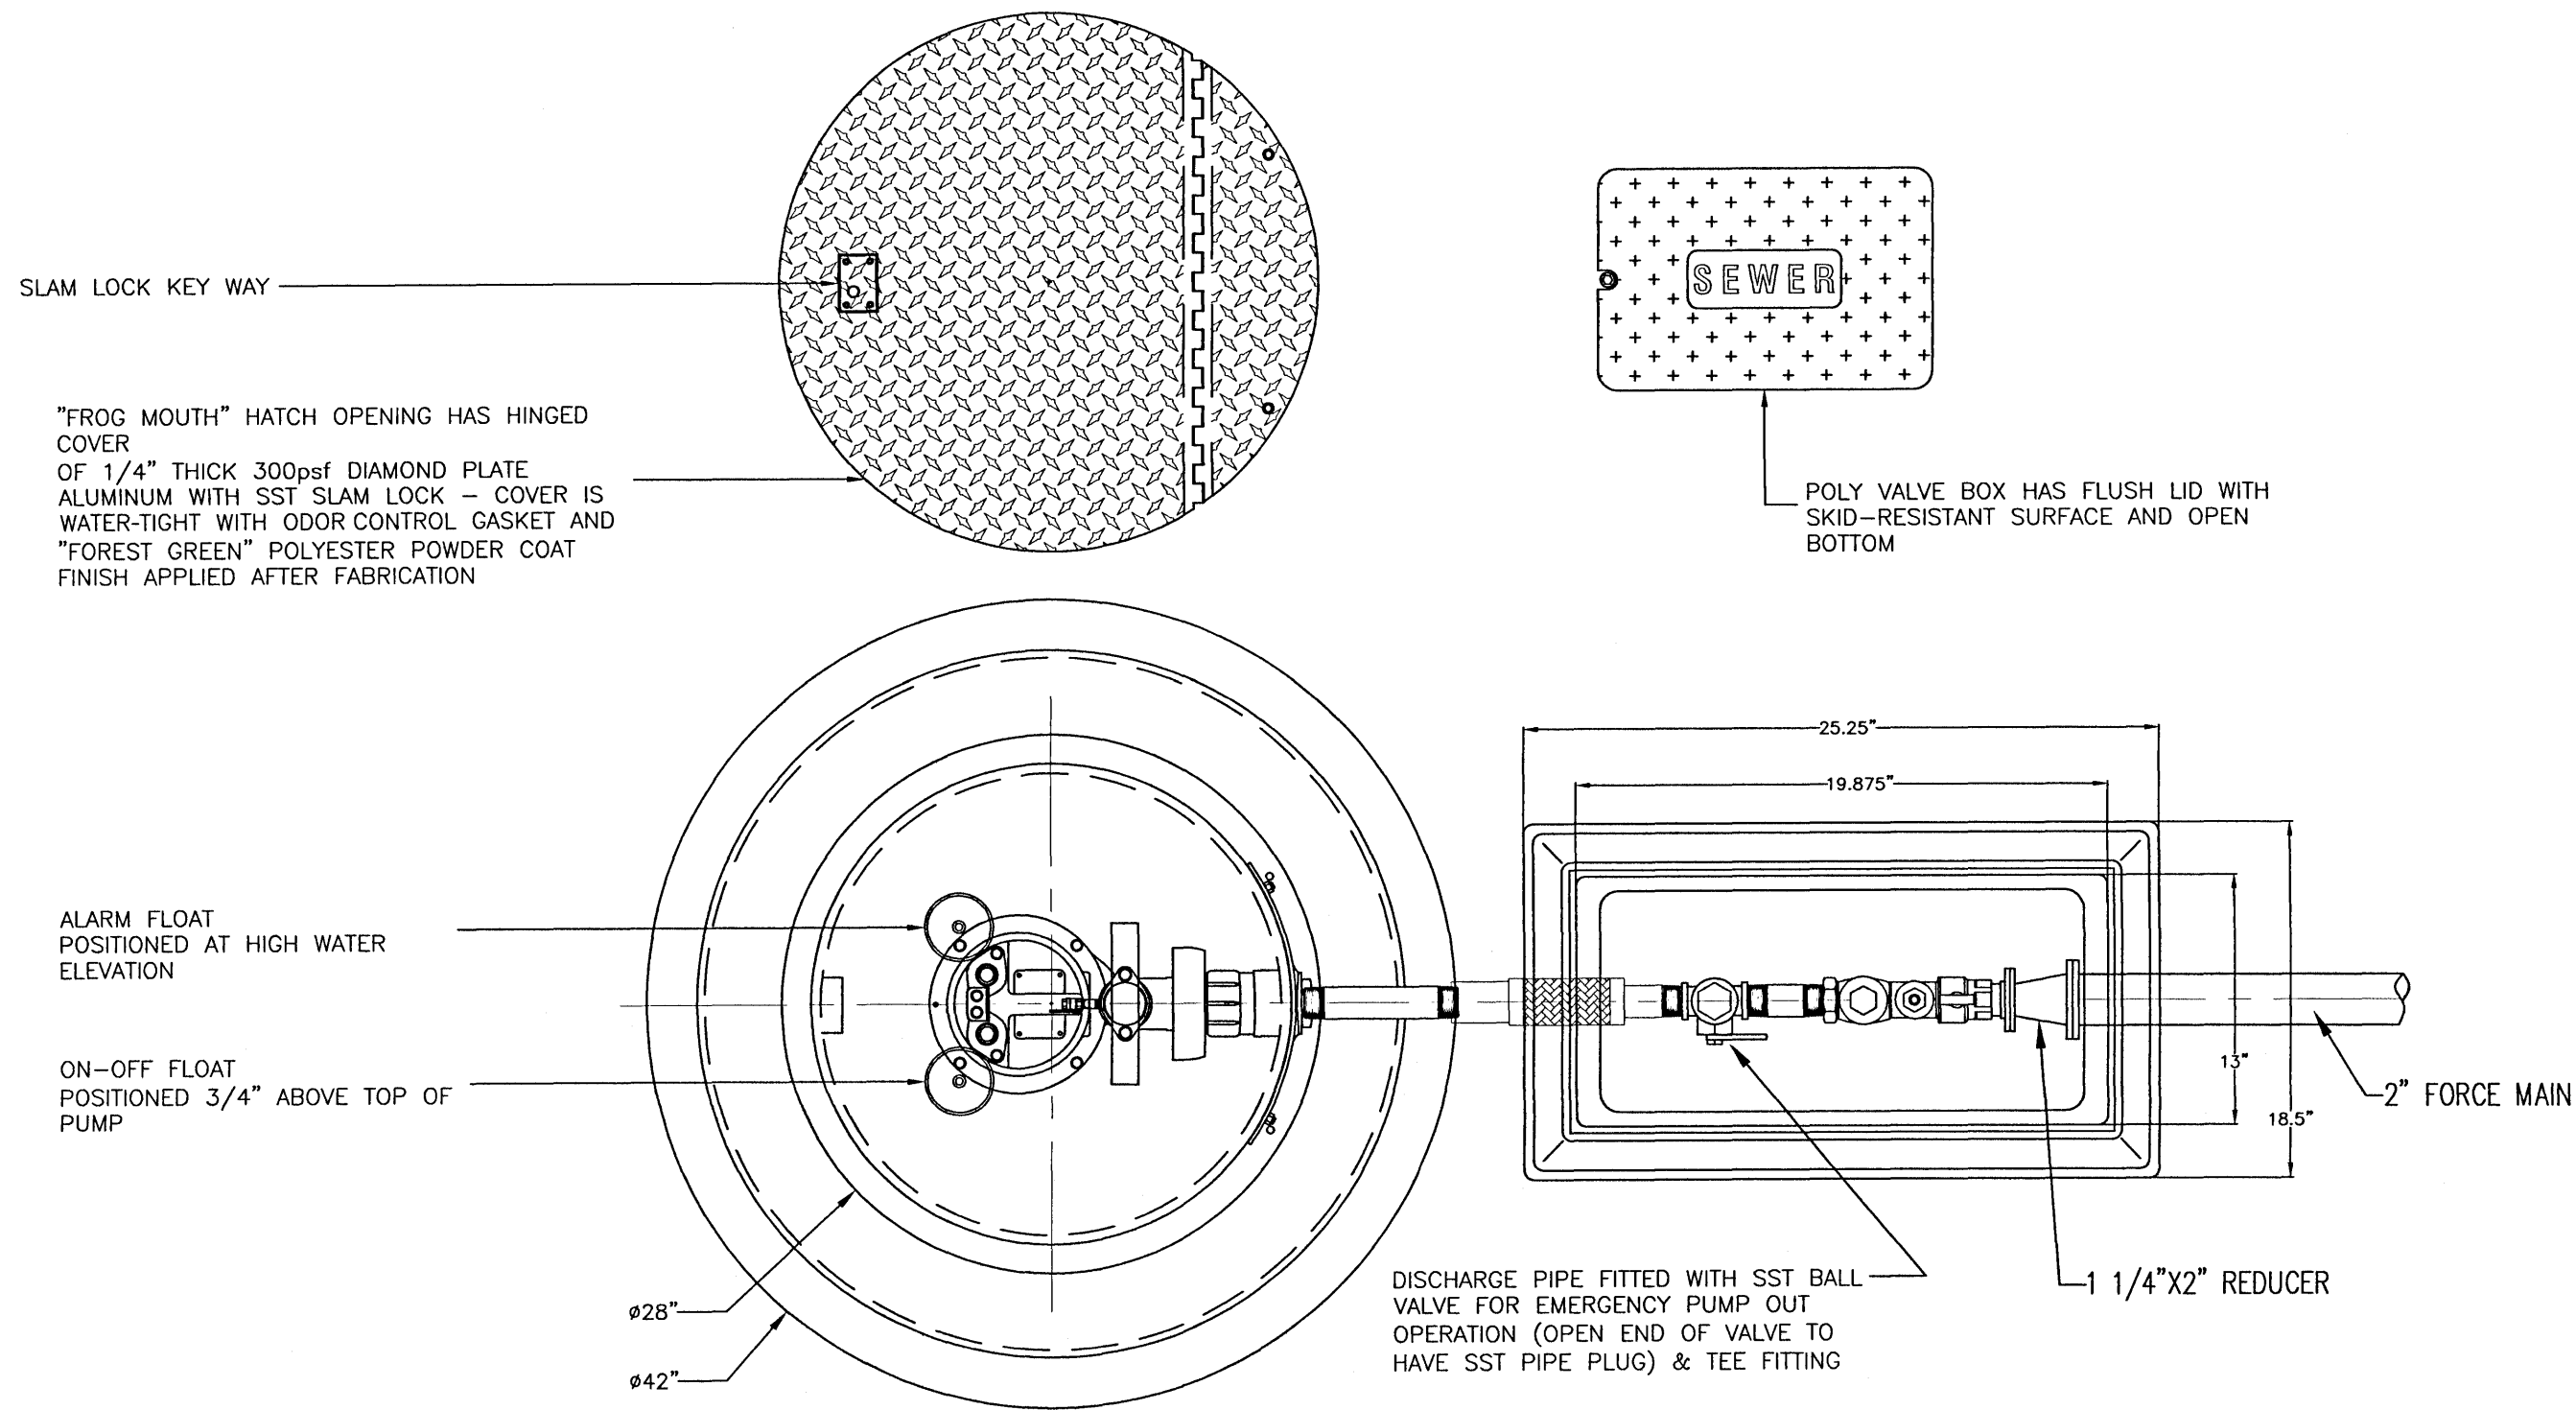

TOP VIEW

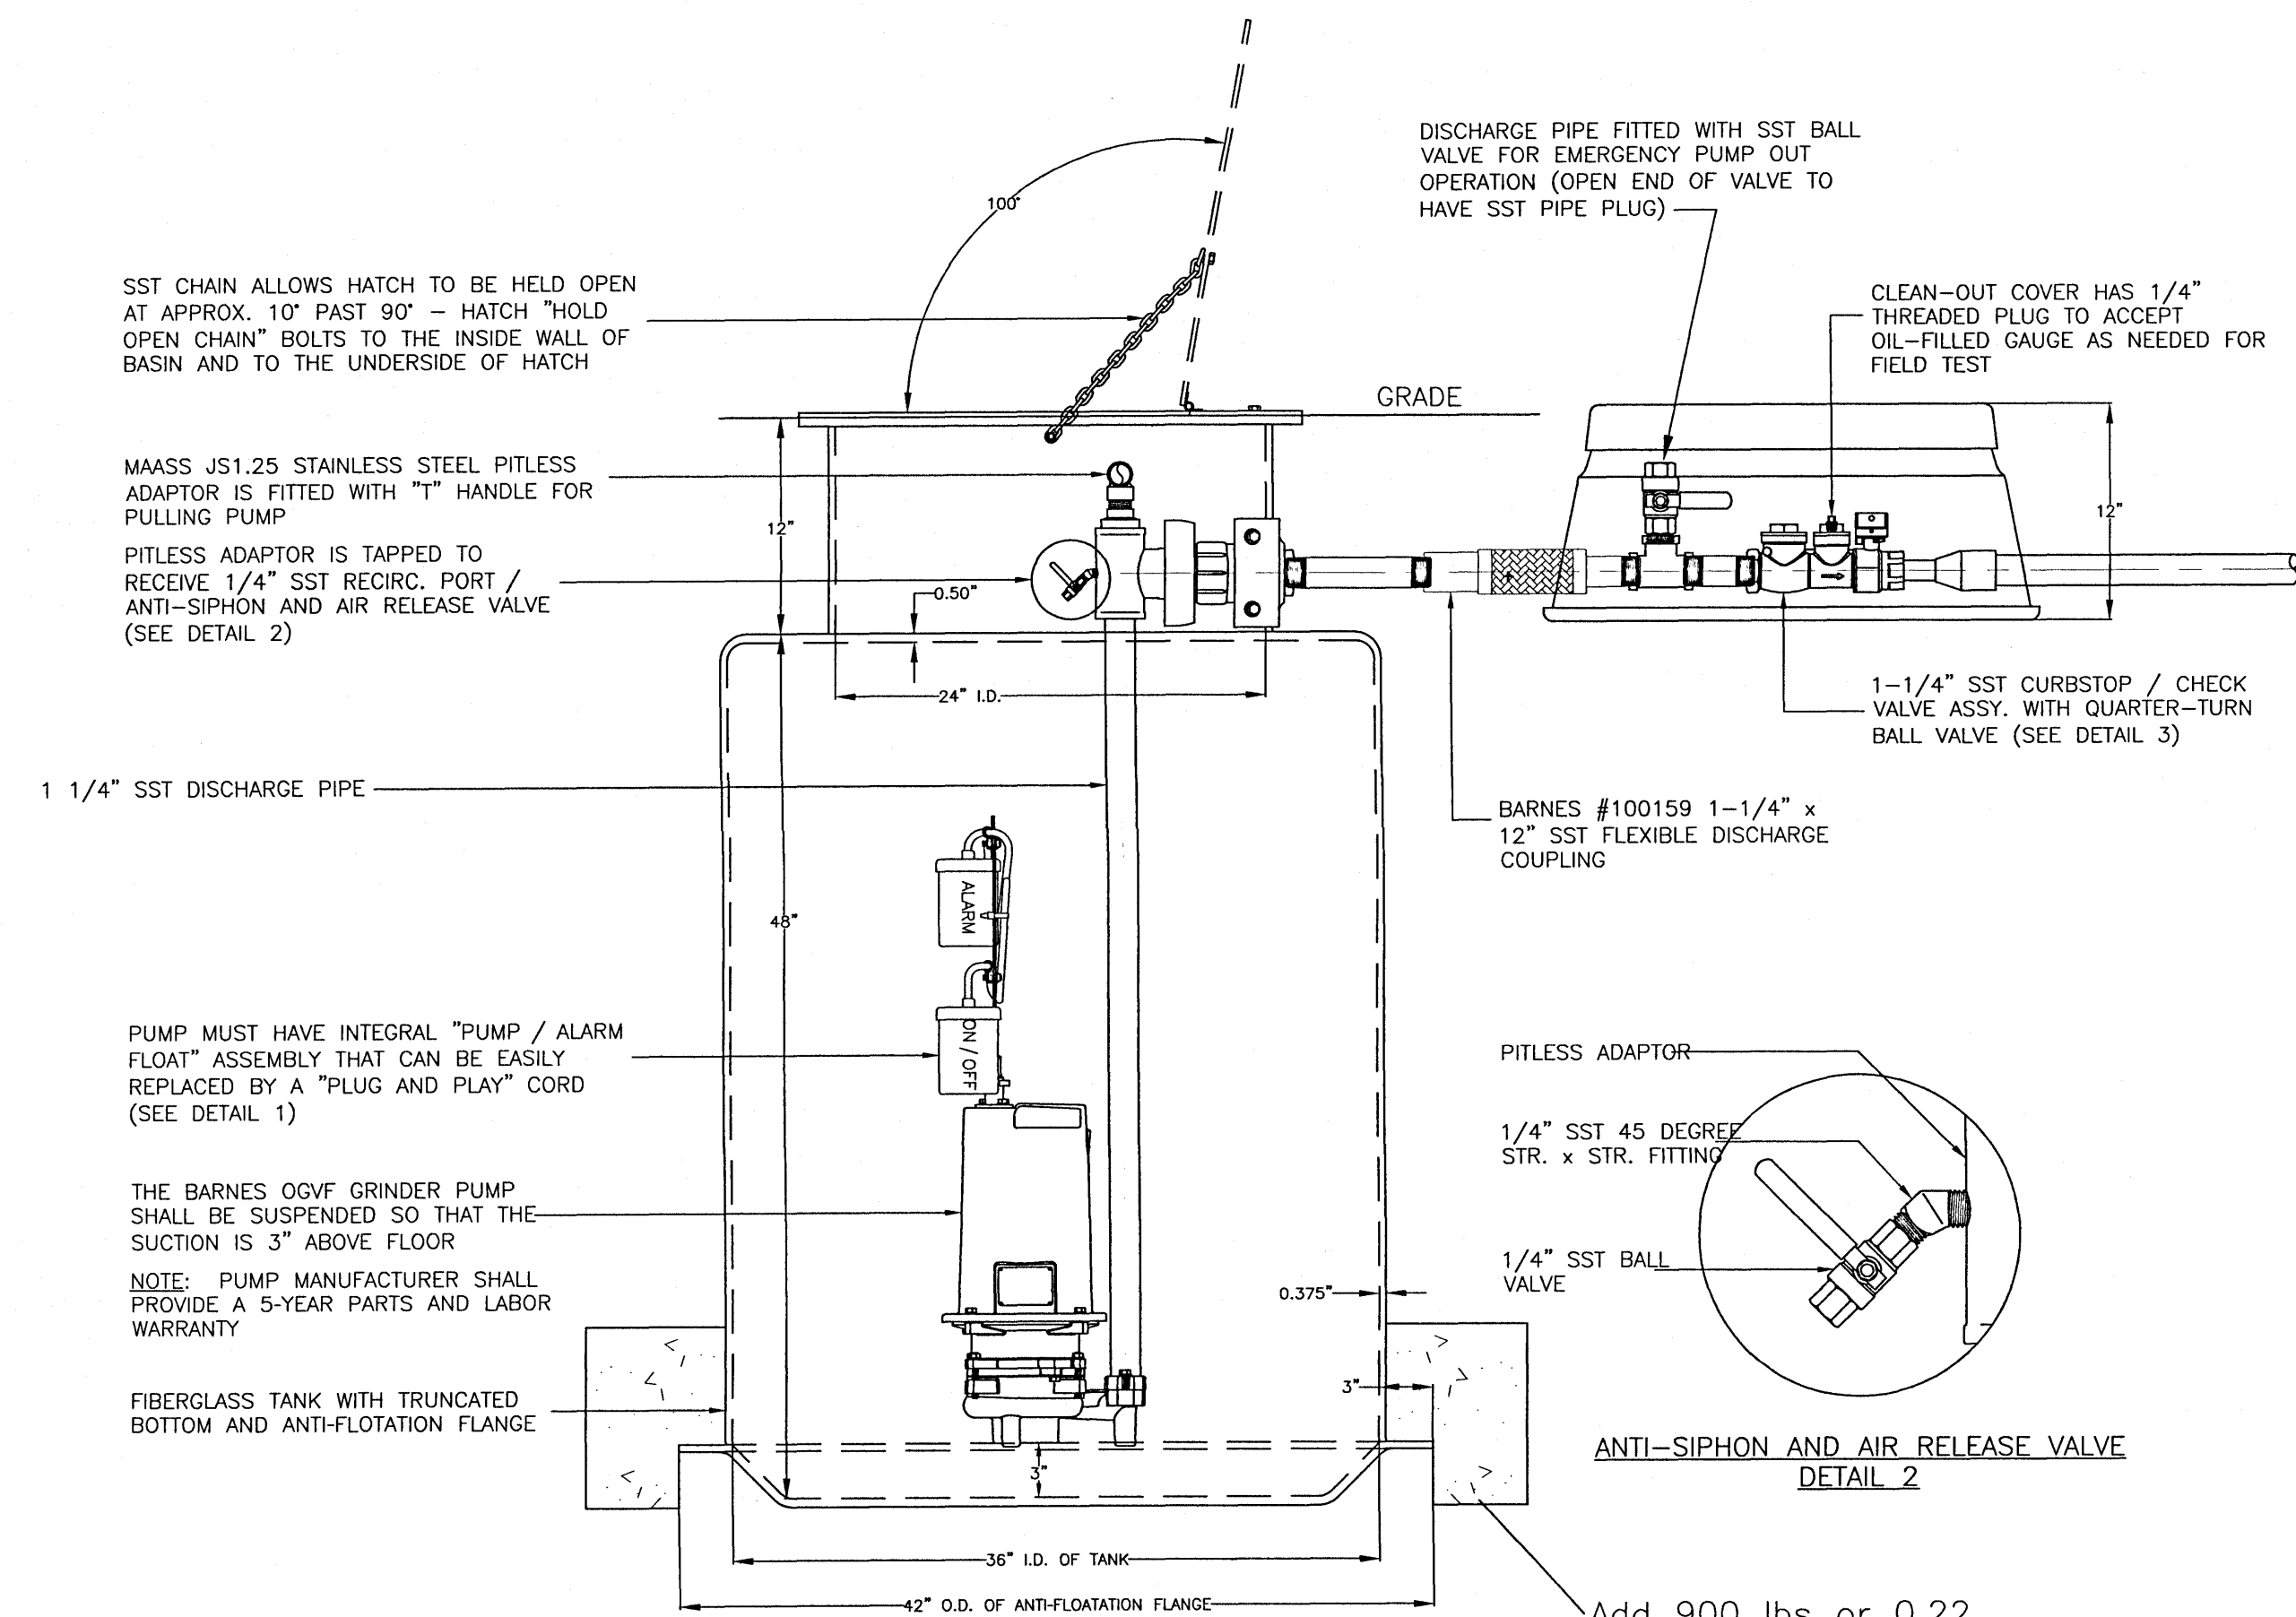


WET WELL ELEVATION


Add 900 lbs or 0.22 cubic yards of Concrete Ballast

PUMP DATA TABLE	
MANUFACTURER	
MODEL	32GF22.2H
VOLTAGE	230
PHASE	1
HP	3
FLA	14.2
RPM	3440
GPM	21
TDH (FEET)	116



WET WELL DATA	
WET WELL DIAMETER	36"
WET WELL DEPTH	48"
INFLUENT ELEV.	91.10
FORCE MAIN DIAMETER	2"
BOTTOM ELEV.	87.50
PUMP OFF ELEV.	89.00
PUMP ON ELEV.	90.20
HIGH LEVEL ALARM ELEV.	91.00
TOP ELEV.	92.50

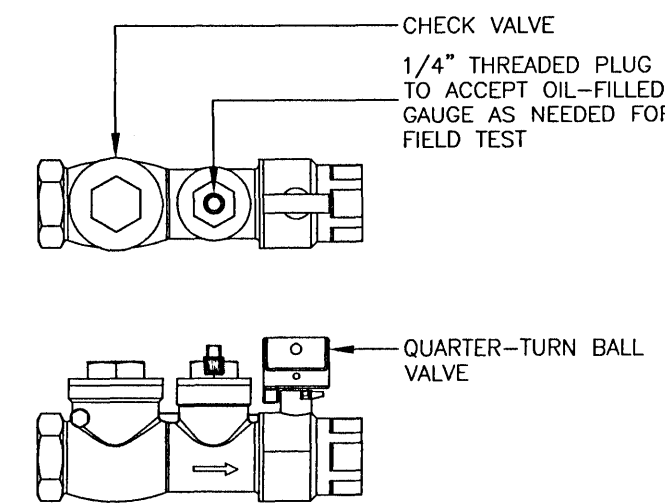

BARNES #140774 1-1/4" SST CURBSTOP/CHECK VALVE ASSEMBLY DETAIL 3

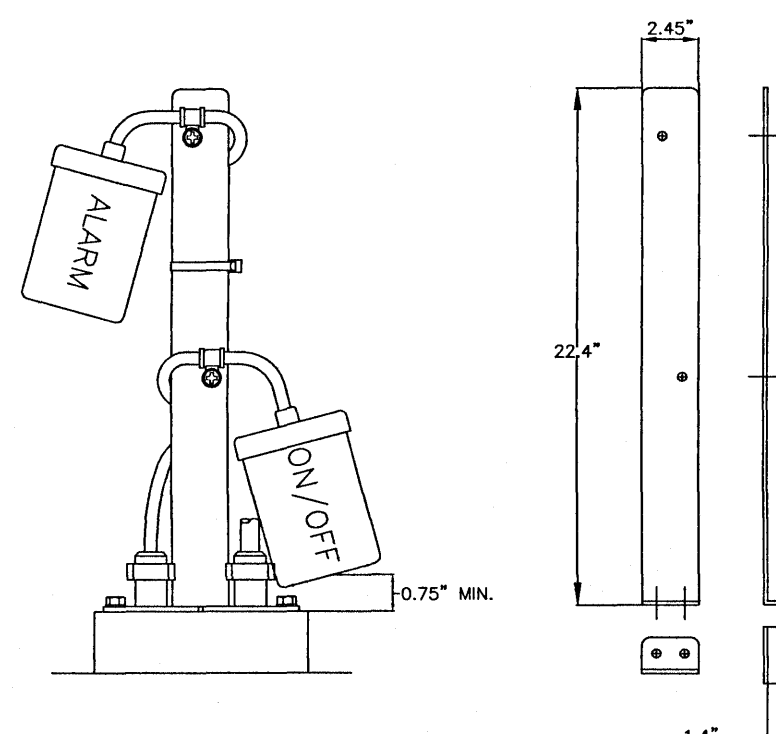

SST FLOAT BRACKET ASSEMBLY DETAIL 1

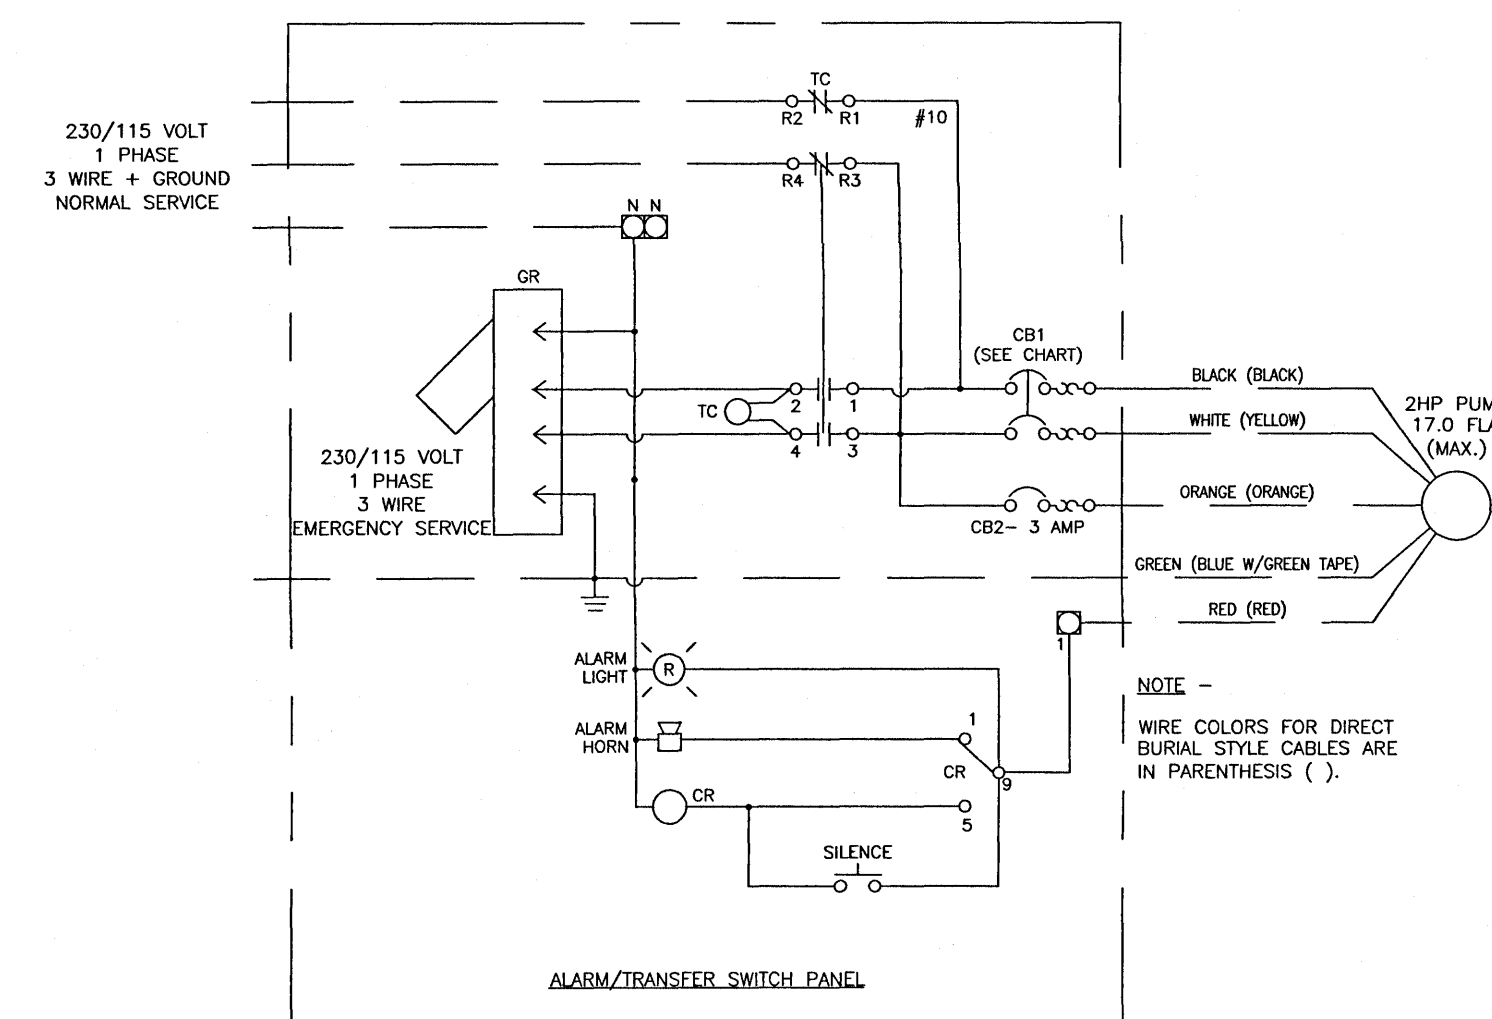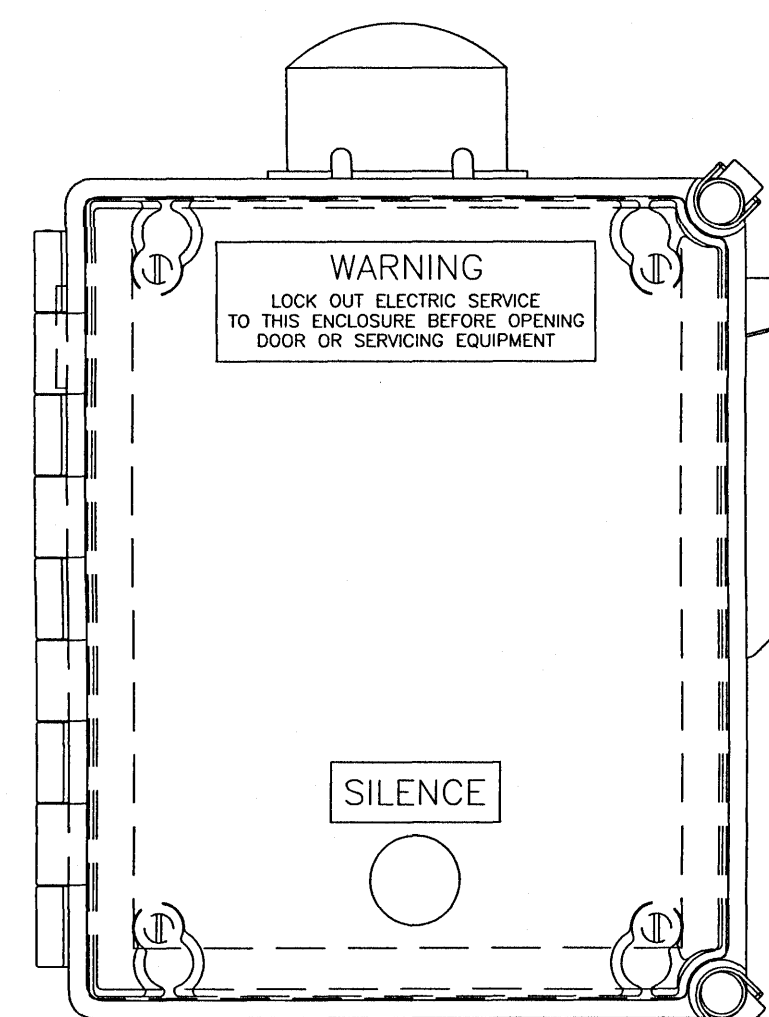


PART NO.	STYLE	CB1 BREAKER SIZE
111566	OGP/DOV/SCPC	25 AMP DOUBLE POLE
111583	SGV	30 AMP DOUBLE POLE

NOTES:

- PANEL GROUND TERMINAL MUST BE CONNECTED TO EARTH GROUND
- FIELD WIRING SHOWN AS
- FACTORY WIRING SHOWN AS
- GENERATOR RECEPTACLE NEMA CODE L14-30.

NO.	DATE	REVISIONS
1	11/11/2020	REVISED PLANS AS PER ESCAMBIA COUNTY DPC REVIEW COMMENTS

HAMMOND ENGINEERING, INC.
FLORIDA AUTHORIZATION NO. 9130
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TOM@SELANDDESIGN.COM

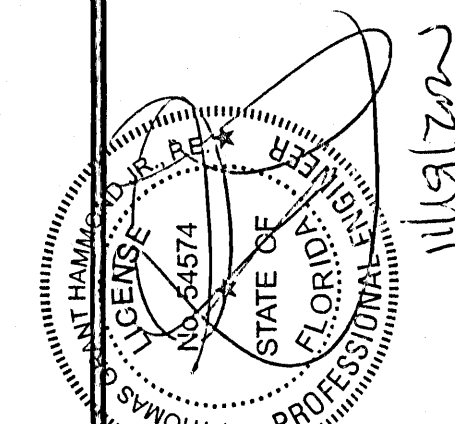


**SITE DEVELOPMENT
PLANS FOR
FRONTIER MOTORS
PRIVATE STORAGE
LIFT STATION
DETAILS**

DRAWN BY: CJB
DESIGNED BY: RLS
CHECKED BY: TGH
DATE: 9-3-20
SCALE: AS SHOWN
NOT RELEASED FOR CONSTRUCTION
BY: DATE:


PROJECT NO: 20-035

SHEET: C10

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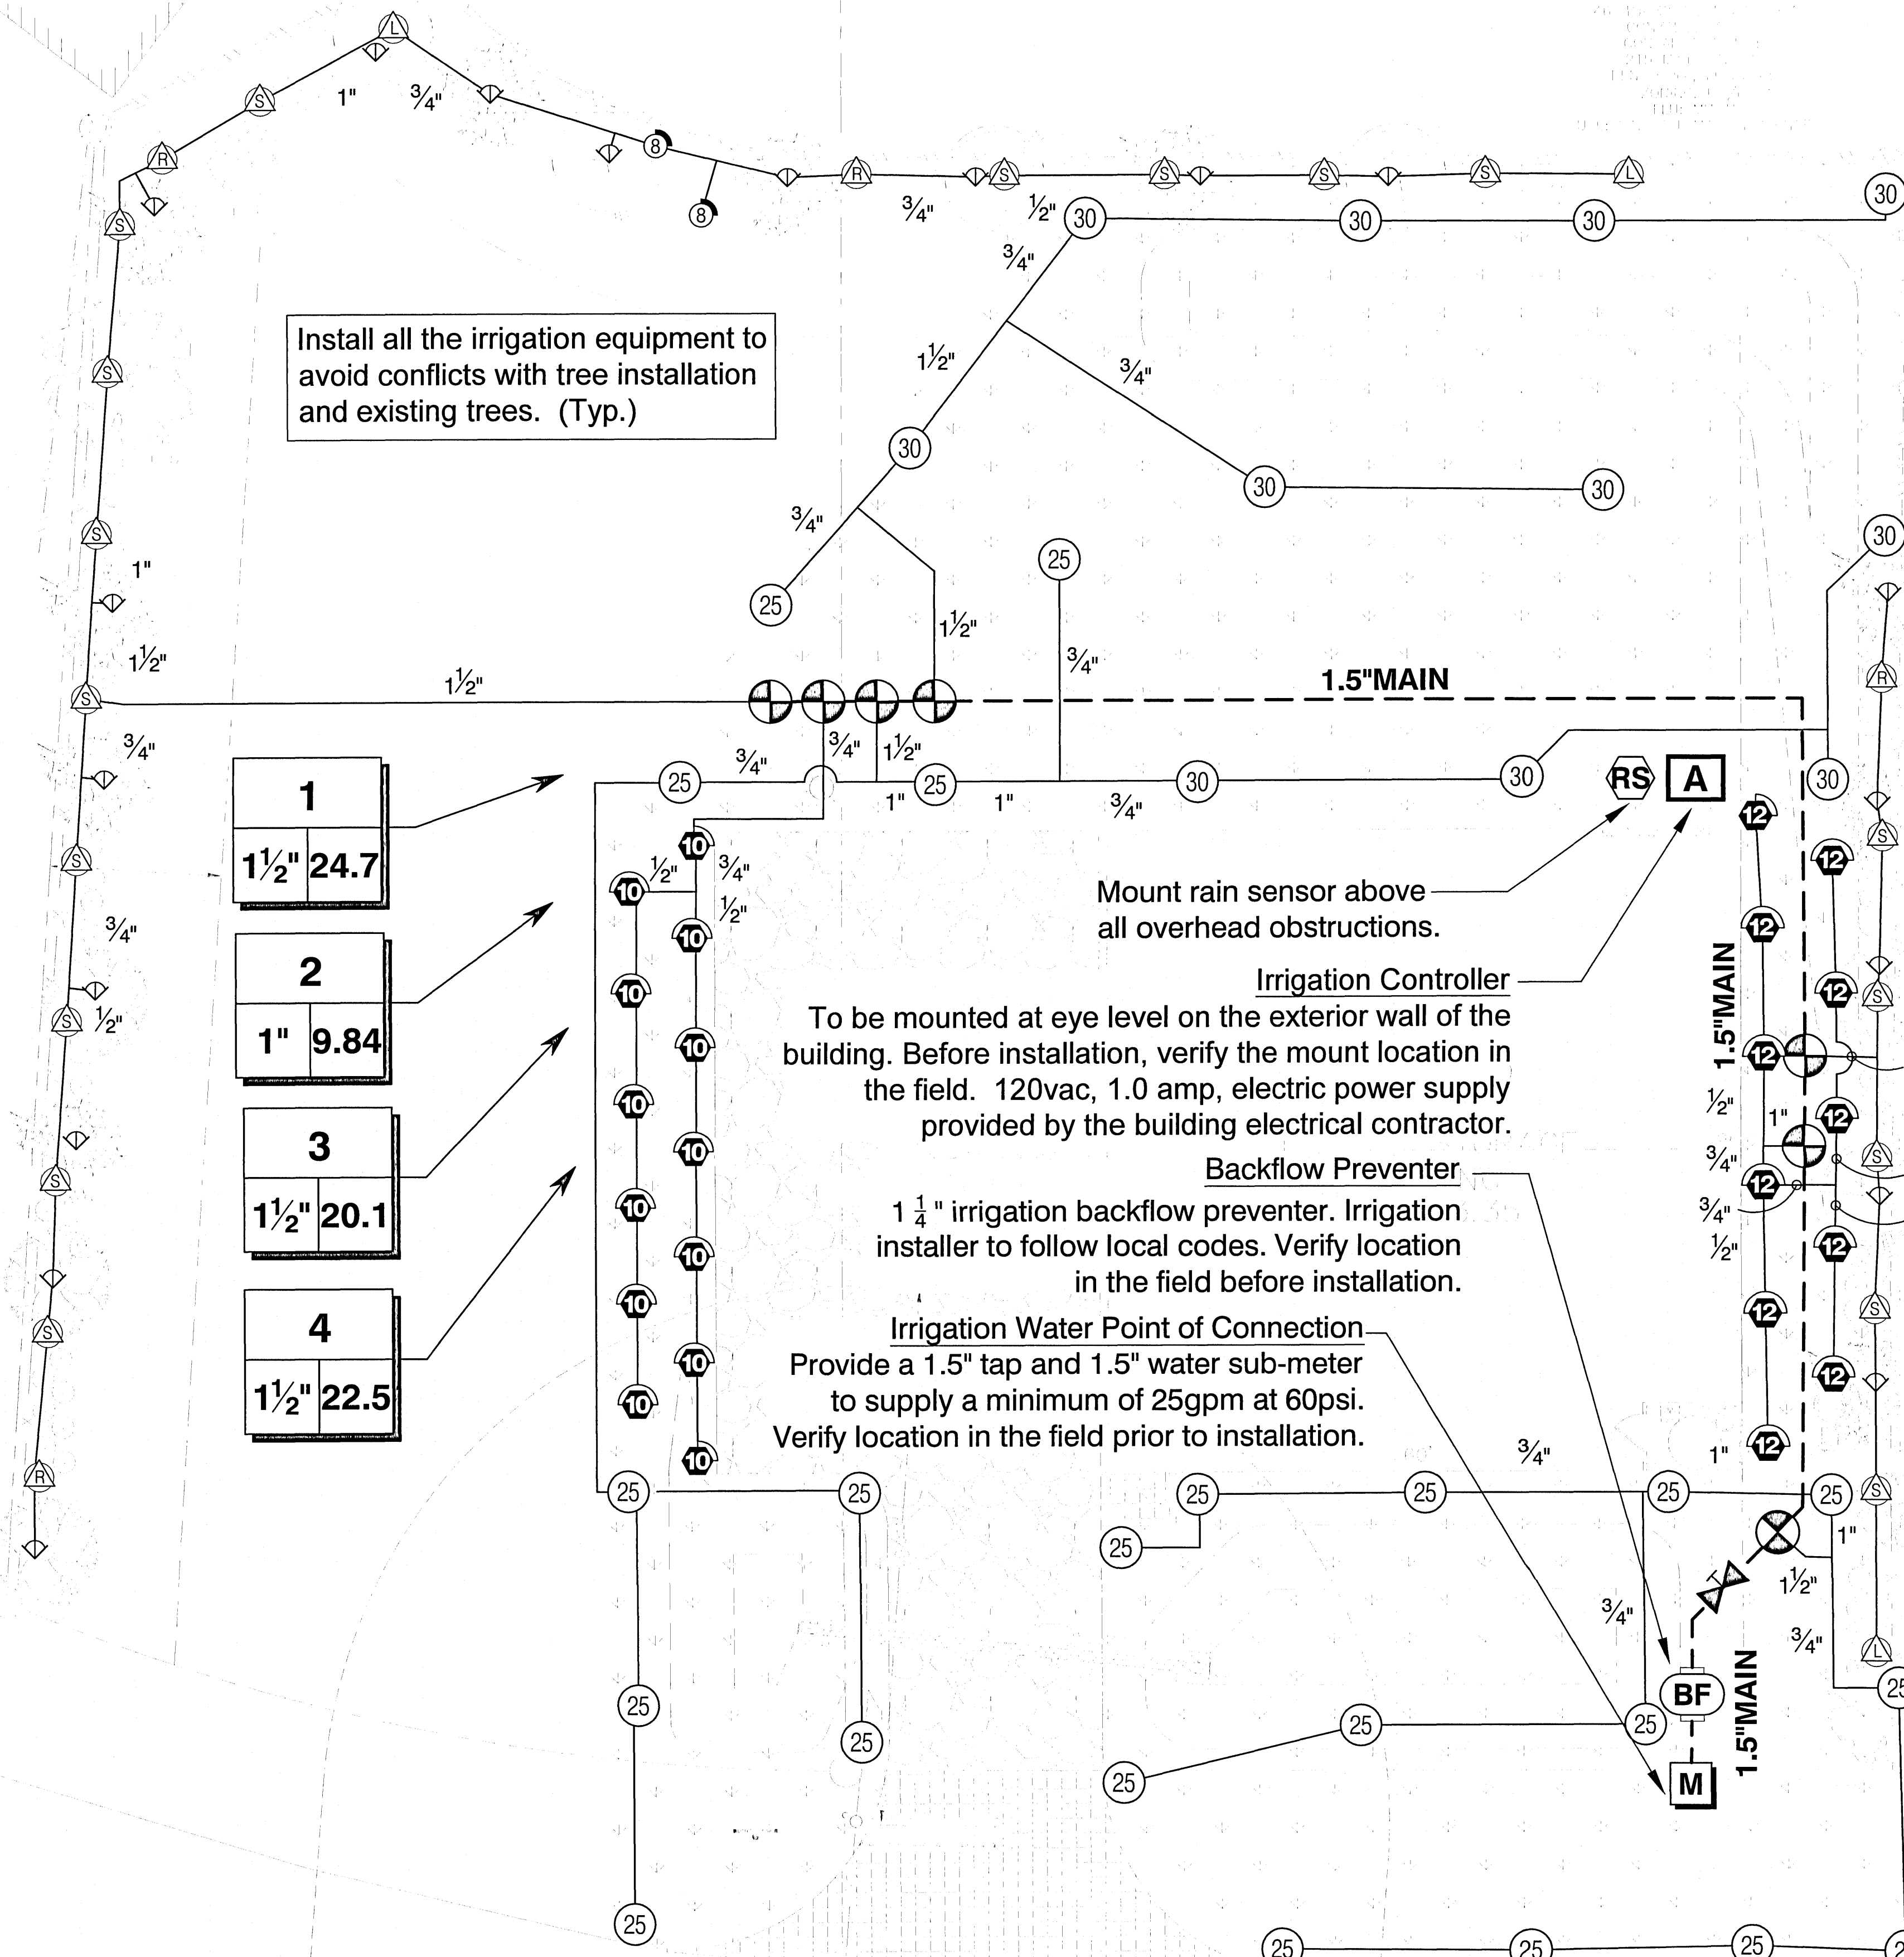
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1.800.422.4133
UNDERGROUND SERVICE ALERT

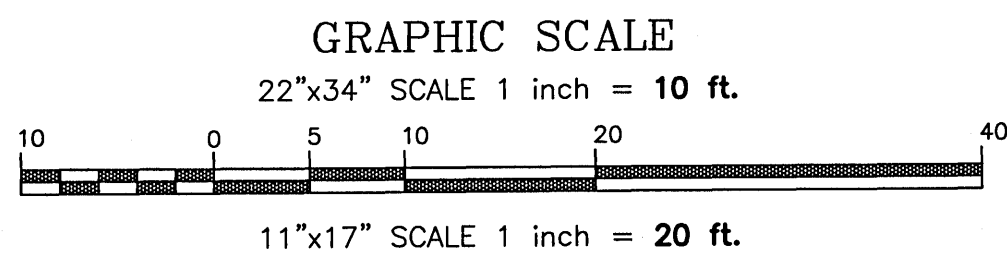

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WWW.IRRIDESIGNSTUDIO.COM

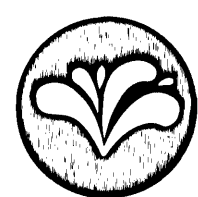IRRIGATION NOTES

- The plans and drawings are diagrammatic of the work to be performed. Some components may be shown outside the work area for clarity. The work shall be executed in a manner to avoid conflicts with utilities and other elements of construction, including landscape materials. All deviations from the plans shall be approved by the owner's representative before being installed.
- The irrigation system shall be installed in accordance with the plans, irrigation system specifications and all contract documents. The contractor shall comply with all current local codes, ordinances, and regulations.
- All irrigation mainline and lateral lines are to not exceed a velocity of 5FPS.
- The contractor shall not willfully install any aspect of the irrigation system as shown on the plans and drawings, when it is obvious in the field that obstructions, grade differences, or discrepancies exist that might not have been known during the design of the irrigation system. In the event that notification of the conflict is not approved by the owner's representative, the contractor will assume full responsibility for all revisions.
- Refer to the landscape plans when trenching to avoid tree root balls when installing irrigation equipment. Call 811 and refer to utility plans prior to trenching.
- Irrigation contractor shall verify all site conditions, including utility locations before installation of the irrigation system. The contractor is responsible for coordinating installation with all other construction on site, especially landscape installation. The irrigation system shall be relocated at no additional cost for any conflict with landscape installation or any other site construction or existing conditions.
- Sixty (60) psi minimum static water pressure is required for the efficient operation of the irrigation system as designed. Verify the minimum static water pressure is available at the project site prior to beginning the irrigation installation. Notify the irrigation design consultant and landscape architect in writing if the minimum static water pressure or water volume is not available.
- Where existing or new trees, light fixtures, signs, electronic controllers and/or other objects are an obstruction to an irrigation sprinkler's pattern, the component and piping shall be relocated as necessary to obtain proper coverage of an irrigation sprinkler's pattern. The component and piping shall be relocated as necessary to obtain the proper coverage without damaging the obstruction.
- 100% head to head coverage is required. Assume that any modified spacing does not exceed the spacing shown in the plans.
- Irrigation contractor shall adjust all sprinklers to avoid over spray onto impervious areas.
- All materials and equipment shown shall be new and installed as shown on the plans. If the drawings do not thoroughly describe the techniques to be used, the installer shall follow the installation methods and instructions recommended by the product manufacturer.
- The location of the irrigation mainline shall be identified in the field and approved by the owner's representative before installation.
- Contractor is to submit product specification sheets for all irrigation equipment to be used for approval by the landscape architect prior to installation.
- The quantities shown in the legend sheets shall not be used for bidding purposes. The contractor will be responsible for conducting a comprehensive materials takeoff to determine the actual quantities of material necessary to execute the work described in the documents.
- All trenches shall be backfilled with clean debris-free materials.
- Irrigation contractor is to install christy zone tags with the corresponding controller zone number at each control valve.
- As built documents are to be provided to the owner upon completion of the project. The mainline, control valves, isolation valves, ground rods and splice boxes shall be located with a measurement from two fixed points.
- Irrigation contractor shall secure any and all necessary permits for the work prior to commencement of on-site operations.
- A mainline pressure test is to be conducted before backfilling. All findings are to be reported to the landscape architect within twenty four hours post test.
- Bahia turf is to be irrigated until established. The owner will then determine whether to continue irrigating the Bahia. Shrub zones are to be irrigated per the county allowance.



Install all the irrigation equipment to avoid conflicts with tree installation and existing trees. (Typ.)

Mount rain sensor above all overhead obstructions.

Irrigation Controller
To be mounted at eye level on the exterior wall of the building. Before installation, verify the mount location in the field. 120vac, 1.0 amp, electric power supply provided by the building electrical contractor.

Backflow Preventer
1 1/4" irrigation backflow preventer. Irrigation installer to follow local codes. Verify location in the field before installation.

Irrigation Water Point of Connection
Provide a 1.5" tap and 1.5" water sub-meter to supply a minimum of 25gpm at 60psi. Verify location in the field prior to installation.


5
1" 9.53

6
1" 13.7

7
1 1/2" 20.9

REQUIRED MITIGATION
NO PROTECTED TREES TO BE REMOVED AS PART OF THIS DEVELOPMENT, NO MITIGATION REQUIRED.

(P)YOAKUM COURT - (F)YOAKUM STREET
(50' PUBLIC R/W)

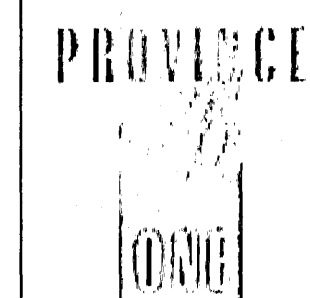


LAND PLANNING
SITE DESIGN
LANDSCAPE ARCHITECTURE

Destin, Florida
Pensacola/Gulf Breeze, Florida
(850) 723-4282

NO.	DATE	REVISIONS
1	11/11/2020	REVISED PLANS AS PER ESCAMBIA COUNTY DRG REVIEW COMMENTS

HAMMOND ENGINEERING, INC.
FLORIDA AUTHORIZATION NO. 9130
ALABAMA AUTHORIZATION NO. 3277
3802 NORTH "S" STREET
PENSACOLA, FLORIDA 32505
850 434-2603
FAX 850-434-2650
TOM@SELANDESIGN.COM

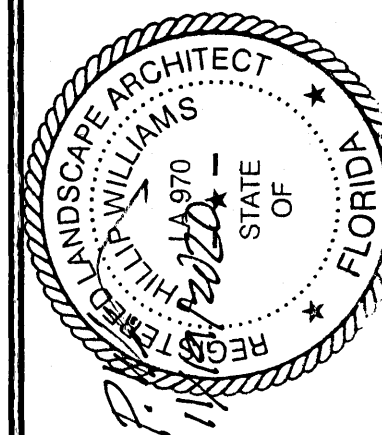

SITE DEVELOPMENT
PLANS FOR
FRONTIER MOTORS
PRIVATE STORAGE
IRRIGATION PLAN
FLORIDA
ESCAMBIA COUNTY

DRAWN BY: GJB
DESIGNED BY: RLS
CHECKED BY: TGH
DATE: 9-3-20
SCALE: AS SHOWN
NOT RELEASED FOR
CONSTRUCTION
BY: DATE:

PROJECT NO: 20-035

SHEET: C7.1

IRRIGATION SCHEDULE

SYMBOL	MANUFACTURER/MODEL/DESCRIPTION	QTY	PSI
	Rain Bird 1806-U-PRS U10 Series Turf Spray 6.0" Pop-Up Sprinkler with Co-Molded Wiper Seal. Side and Bottom Inlet. 1/2" NPT Female Threaded Inlet. Pressure Regulating.	13	30
	Rain Bird 1806-U-PRS U12 Series Turf Spray 6.0" Pop-Up Sprinkler with Co-Molded Wiper Seal. Side and Bottom Inlet. 1/2" NPT Female Threaded Inlet. Pressure Regulating.	11	30
	Rain Bird 1812-PRS-U 15 Strip Series Shrub Spray, 12.0" Pop-Up Sprinkler with Co-Molded Wiper Seal. Side and Bottom Inlet. 1/2" NPT Female Threaded Inlet. With Pressure Regulating Device.	25	30
	Rain Bird 1812-PRS-U U8 Series Shrub Spray, 12.0" Pop-Up Sprinkler with Co-Molded Wiper Seal. Side and Bottom Inlet. 1/2" NPT Female Threaded Inlet. With Pressure Regulating Device.	2	30
	Rain Bird 1800-1400 Flood 1401 Fixed flow rate (0.25-2.0GPM), full circle bubbler, 1/2" FIPT.	19	30


SYMBOL	MANUFACTURER/MODEL/DESCRIPTION	QTY	PSI	GPM	RADIUS
	Rain Bird 5006-R-PC,FC-MPR Turf Rotor, 6.0" Pop-Up, Plastic Riser, Matched Precipitation Rotor (MPR nozzle). Arc and Radius as per Symbol. 25 ft=red, 30 ft=green, 35ft=beige. Pressure Regulating.	22	35		24'
	Rain Bird 5006-R-PC,FC-MPR Turf Rotor, 6.0" Pop-Up, Plastic Riser, Matched Precipitation Rotor (MPR nozzle). Arc and Radius as per Symbol. 25 ft=red, 30 ft=green, 35ft=beige. Pressure Regulating.	11	35		30'

SYMBOL	MANUFACTURER/MODEL/DESCRIPTION	QTY
	Rain Bird PEB-PRS-D 1", 1-1/2", 2" Plastic Industrial Valves. Low Flow Operating Capability, Globe Configuration. With Pressure Regulator Module.	7
	Landscape Products Inc. CWV Slip Socket 1/2", 3/4", 1", 1-1/4", 1-1/2", 2" Slip Socket Plastic Ball Valve. Quarter-turn shutoff designed for irrigation, spas, pools and other general cold water applications. 125 psi rating. Same size as mainline.	1
	Watts LF909M1 1-1/4" Lead Free Reduced Pressure Backflow Preventer.	1
	Rain Bird ESP4ME3 with (2) ESP-SM3 10 Station, Hybrid Modular Outdoor Controller. For Residential or Light Commercial Use. LNK WiFi Module and Flow Sensor Ready.	1
	Rain Bird RSD-BEx Rain Sensor, with metal latching bracket, extension wire.	1
	Water Meter 1-1/2" Rainbird FMD Series sub-meter	1
	Irrigation Lateral Line: PVC Class 200 SDR 21	1,558 l.f.
	Irrigation Mainline: PVC Class 200 SDR 21	202.2 l.f.
	Valve Callout	


*The quantities shown in the legend sheets shall not be used for bidding purposes. The contractor will be responsible for conducting a comprehensive materials takeoff to determine the actual quantities of material necessary to execute the work described in the documents.

VALVE SCHEDULE

NUMBER	MODEL	SIZE	TYPE	GPM	WIRE	PSI	PRECIP
1	Rain Bird PEB-PRS-D	1-1/2"	Shrub Spray	24.70	108.9	39.65	1.94 in/h
2	Rain Bird PEB-PRS-D	1"	Turf Spray	9.84	103.9	34.44	1.46 in/h
3	Rain Bird PEB-PRS-D	1-1/2"	Turf Rotor	20.08	98.9	41.01	0.60 in/h
4	Rain Bird PEB-PRS-D	1-1/2"	Turf Rotor	22.51	93.5	41.06	0.59 in/h
5	Rain Bird PEB-PRS-D	1"	Shrub Spray	9.53	126.9	33.20	2.06 in/h
6	Rain Bird PEB-PRS-D	1"	Turf Spray	13.65	135.3	33.16	1.44 in/h
7	Rain Bird PEB-PRS-D	1-1/2"	Turf Rotor	20.94	172.4	40.55	0.71 in/h
	Common Wire				202.2		

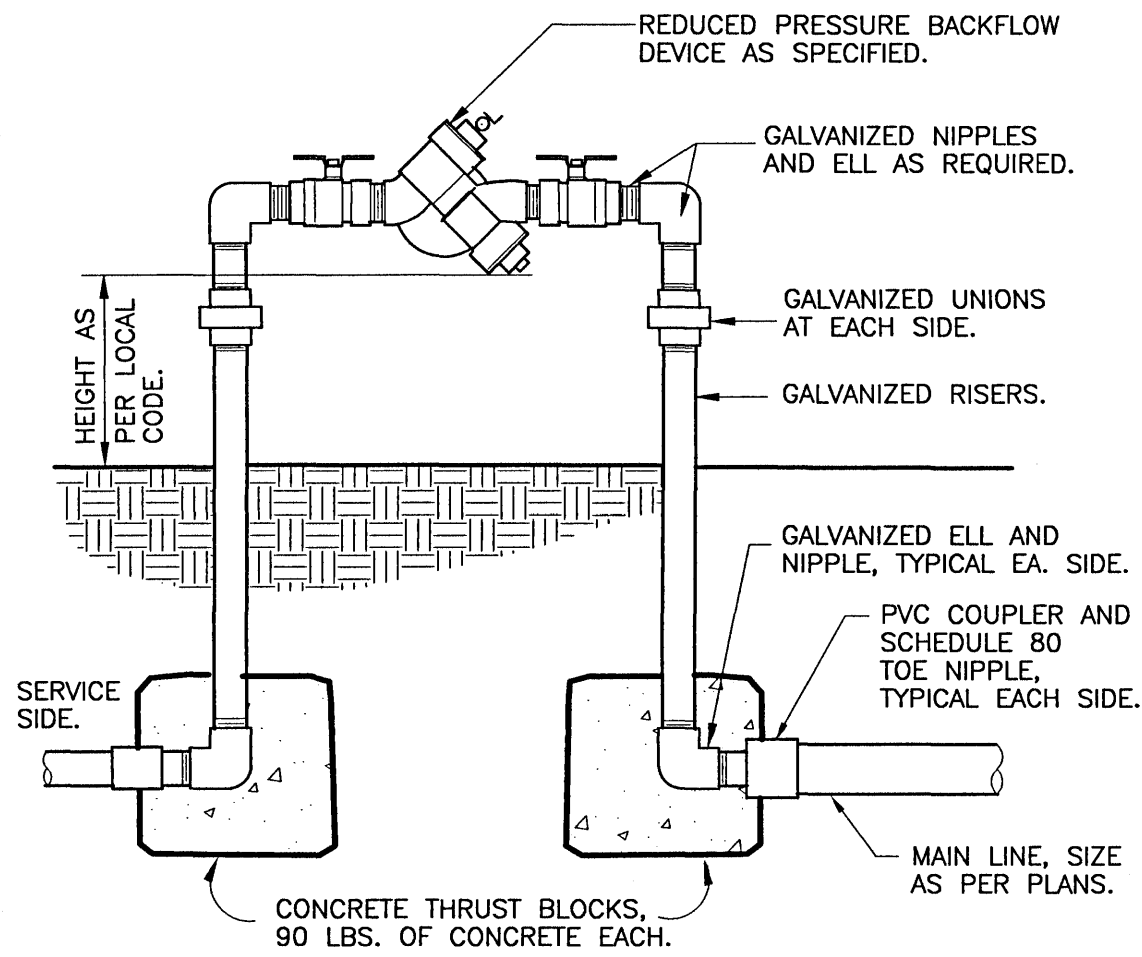


1 REDUCED PRESSURE BACKFLOW DEVICE
1" = 1'-0" FX-IR-FX-BACK-03

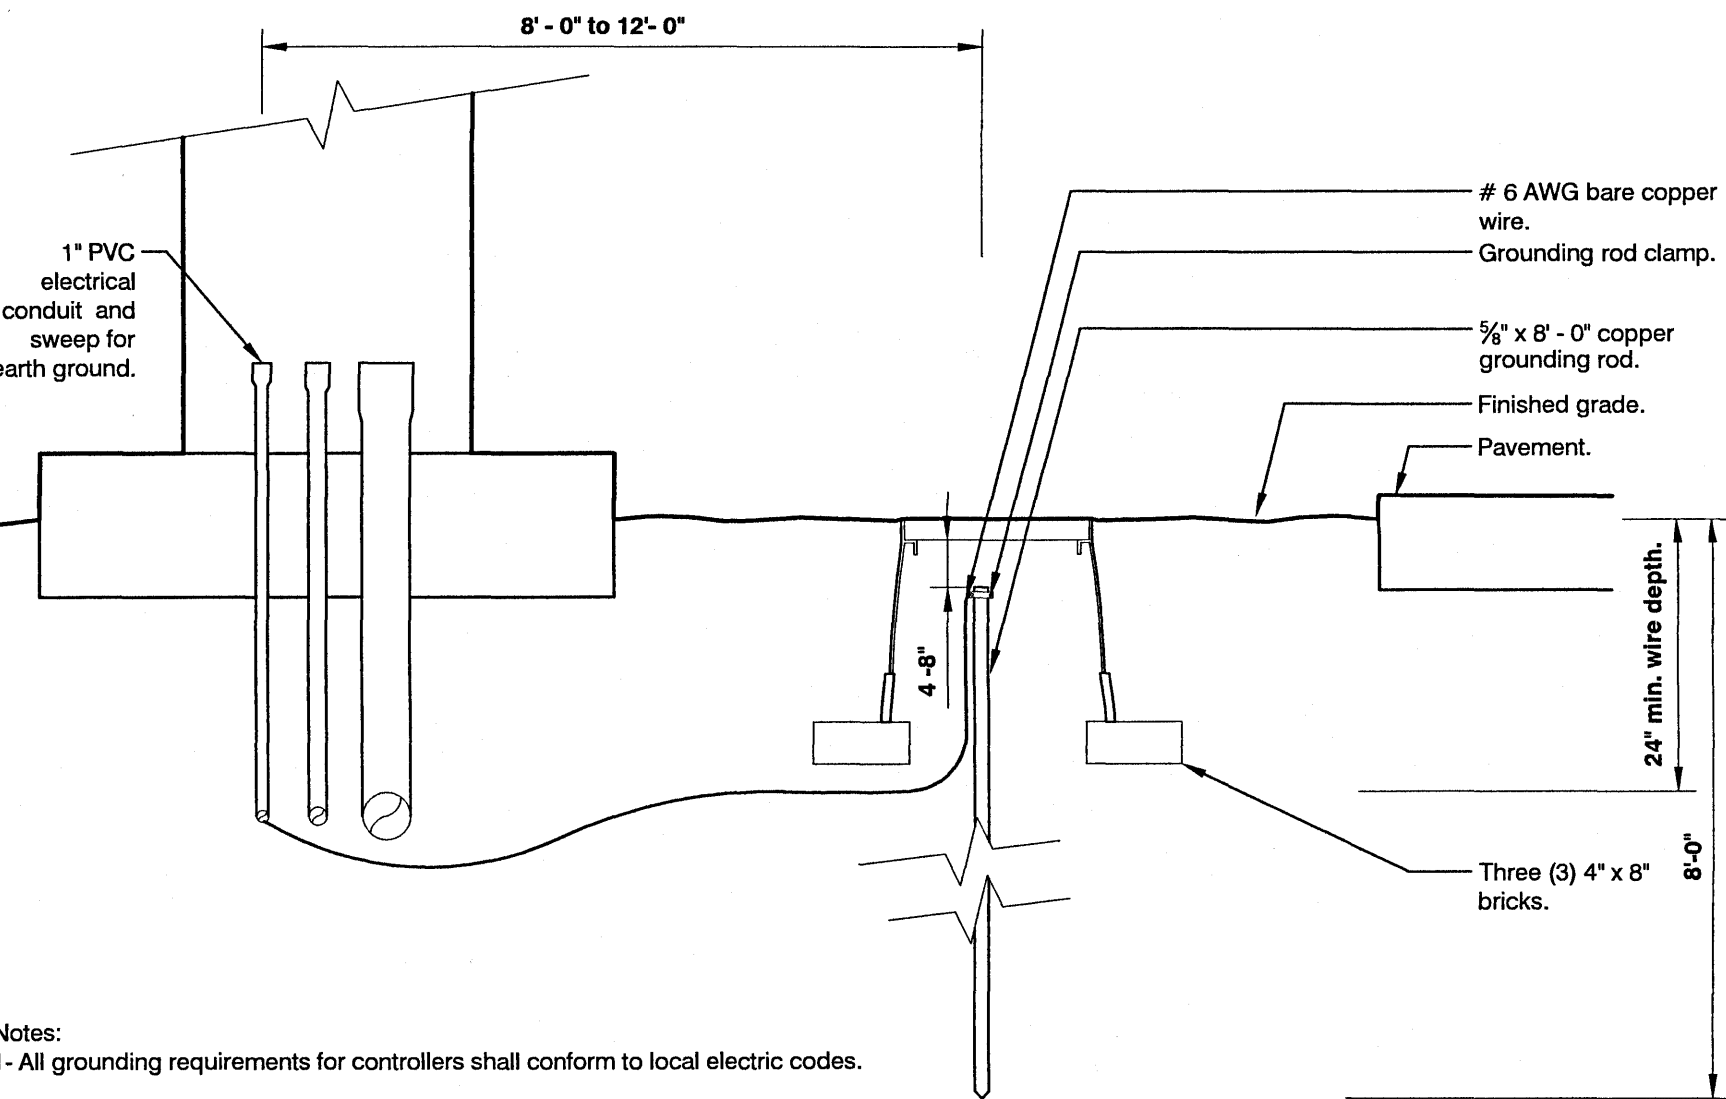


- Notes:
- All grounding requirements for controllers shall conform to local electric codes.
 - Grounding rod shall not be located in the same trench as the irrigation mainlines or lateral lines.
 - Valve box shall be wrapped with a minimum 3 mil thick plastic and secured to the valve box using duct tape or electrical tape.
 - Install grounding rod per the controller manufacturer's specifications and recommendations.

3 GROUNDING ROD
1 1/2" = 1'-0" FX-IR-FX-AUXEQ-01

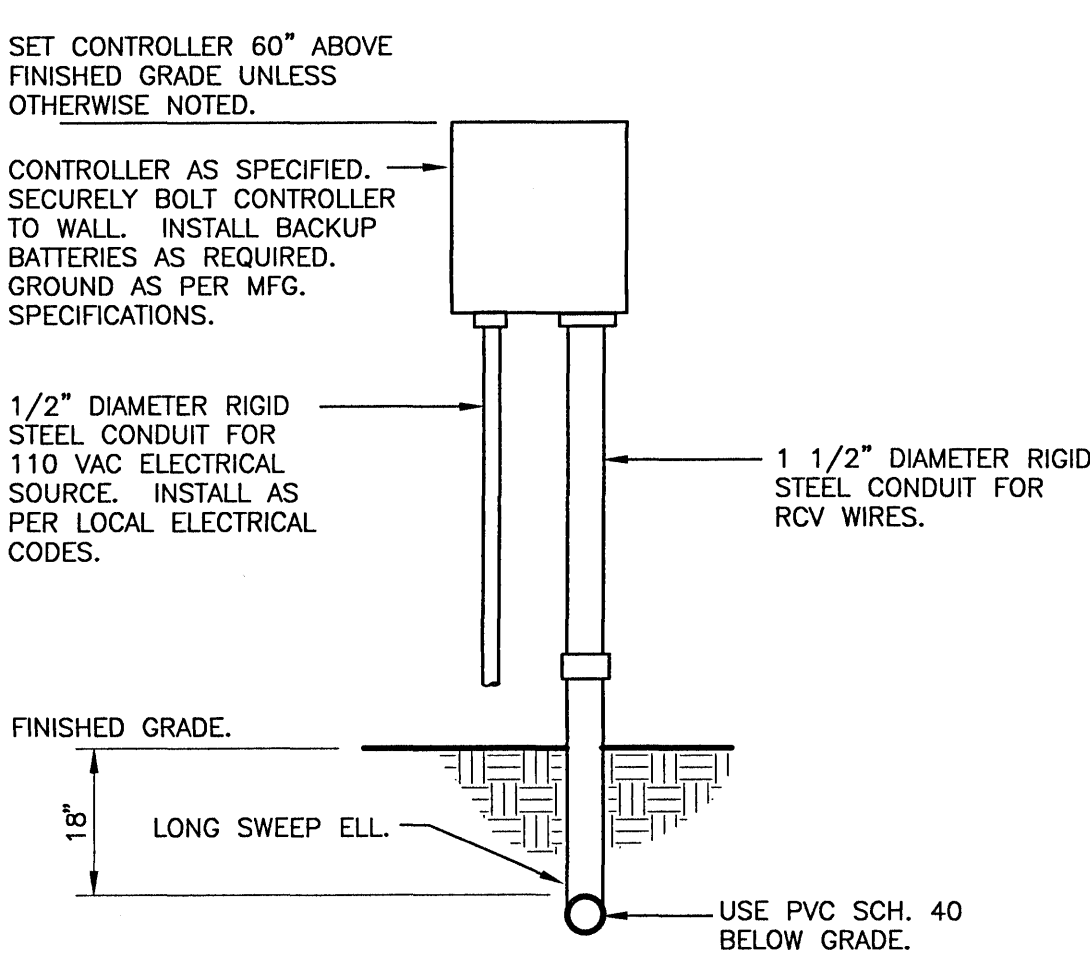

2 WALL MOUNT CONTROLLER
1" = 1'-0" FX-IR-FX-CONT-07

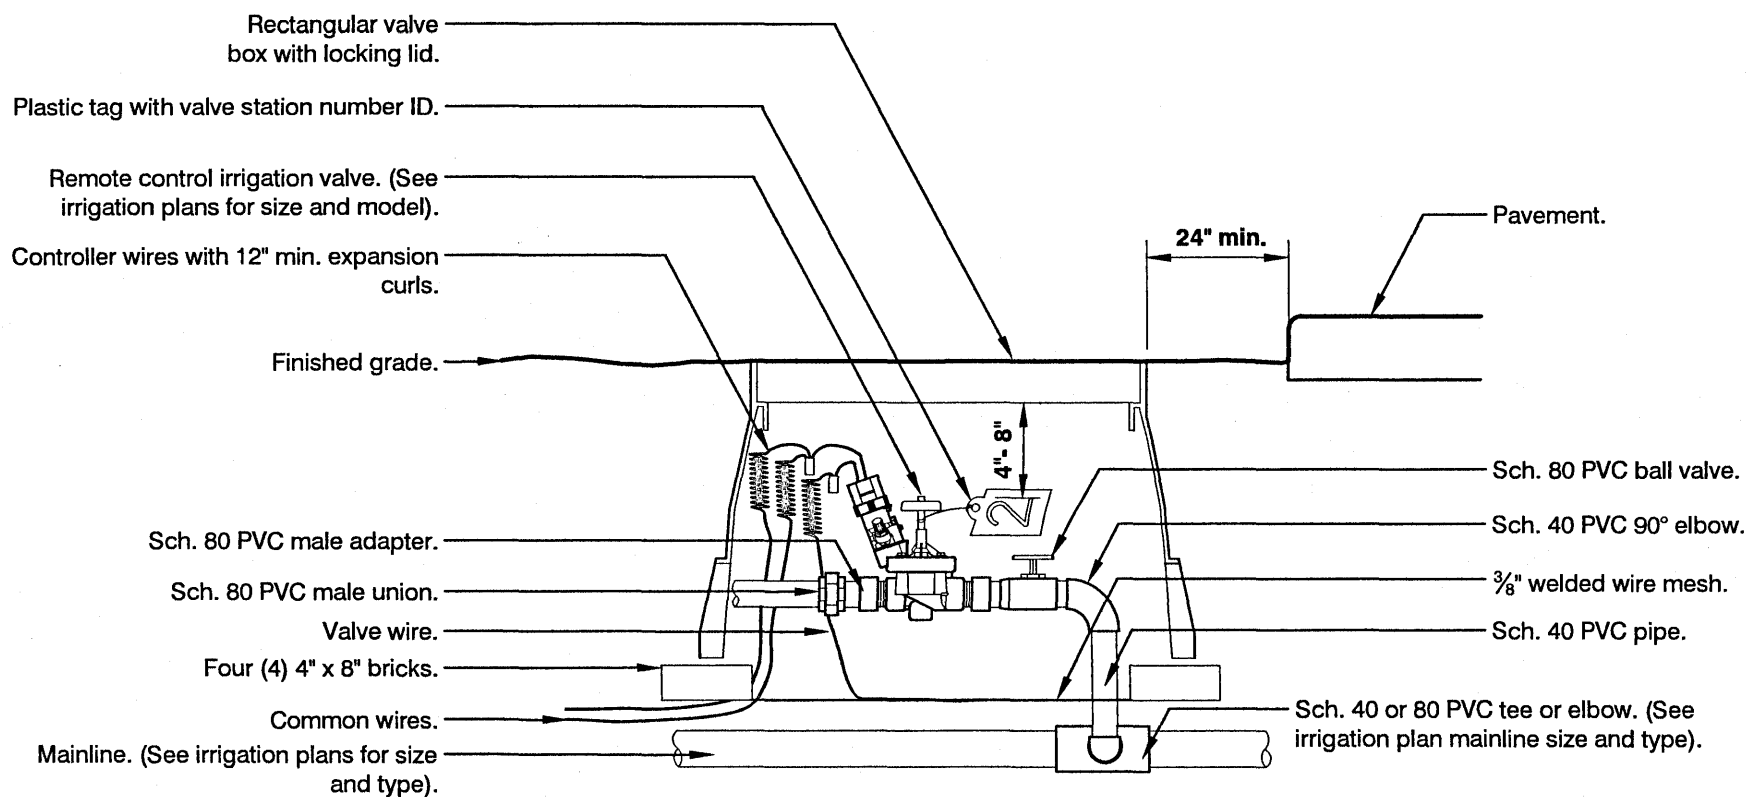


- Note:
- Locate valve box within 24" of pavement edge in planting area where easily accessible whenever possible.
 - Common wire and controller wire shall be direct burial 14 AWG or larger. Color: Common (white), controller wire for turf (blue), and controller wire for shrubs (red). (See specifications for 2-wire controllers).
 - All wire runs shall be continuous without any splices unless approved by the Owner's Representative. See splice box detail. Wire connections shall be made using DBR/Y-6 connectors or approved equal.
 - Valve box shall be wrapped with min. 3 mil thick plastic and secure it using duct tape or electrical tape.
 - Mainlines 4" or larger shall use saddles at the connections points to the irrigation valve. (See specifications for irrigations saddles).
 - All Sch. 80 PVC to Sch. 40 PVC threaded connections shall be made using teflon tape.
 - Valve boxes shall be located in planting areas.

4 REMOTE CONTROL IRRIGATION VALVE
1 1/2" = 1'-0" FX-IR-FX-RCV-02

NO.	DATE	REVISIONS	REVISED PLANS AS PER ESCAMBIA COUNTY DRC REVIEW COMMENTS
A	11/10/2020		


HAMMOND ENGINEERING, INC.
FLORIDA AUTHORIZATION NO. 9130
ALABAMA AUTHORIZATION NO. 3277
3802 NORTH "S" STREET
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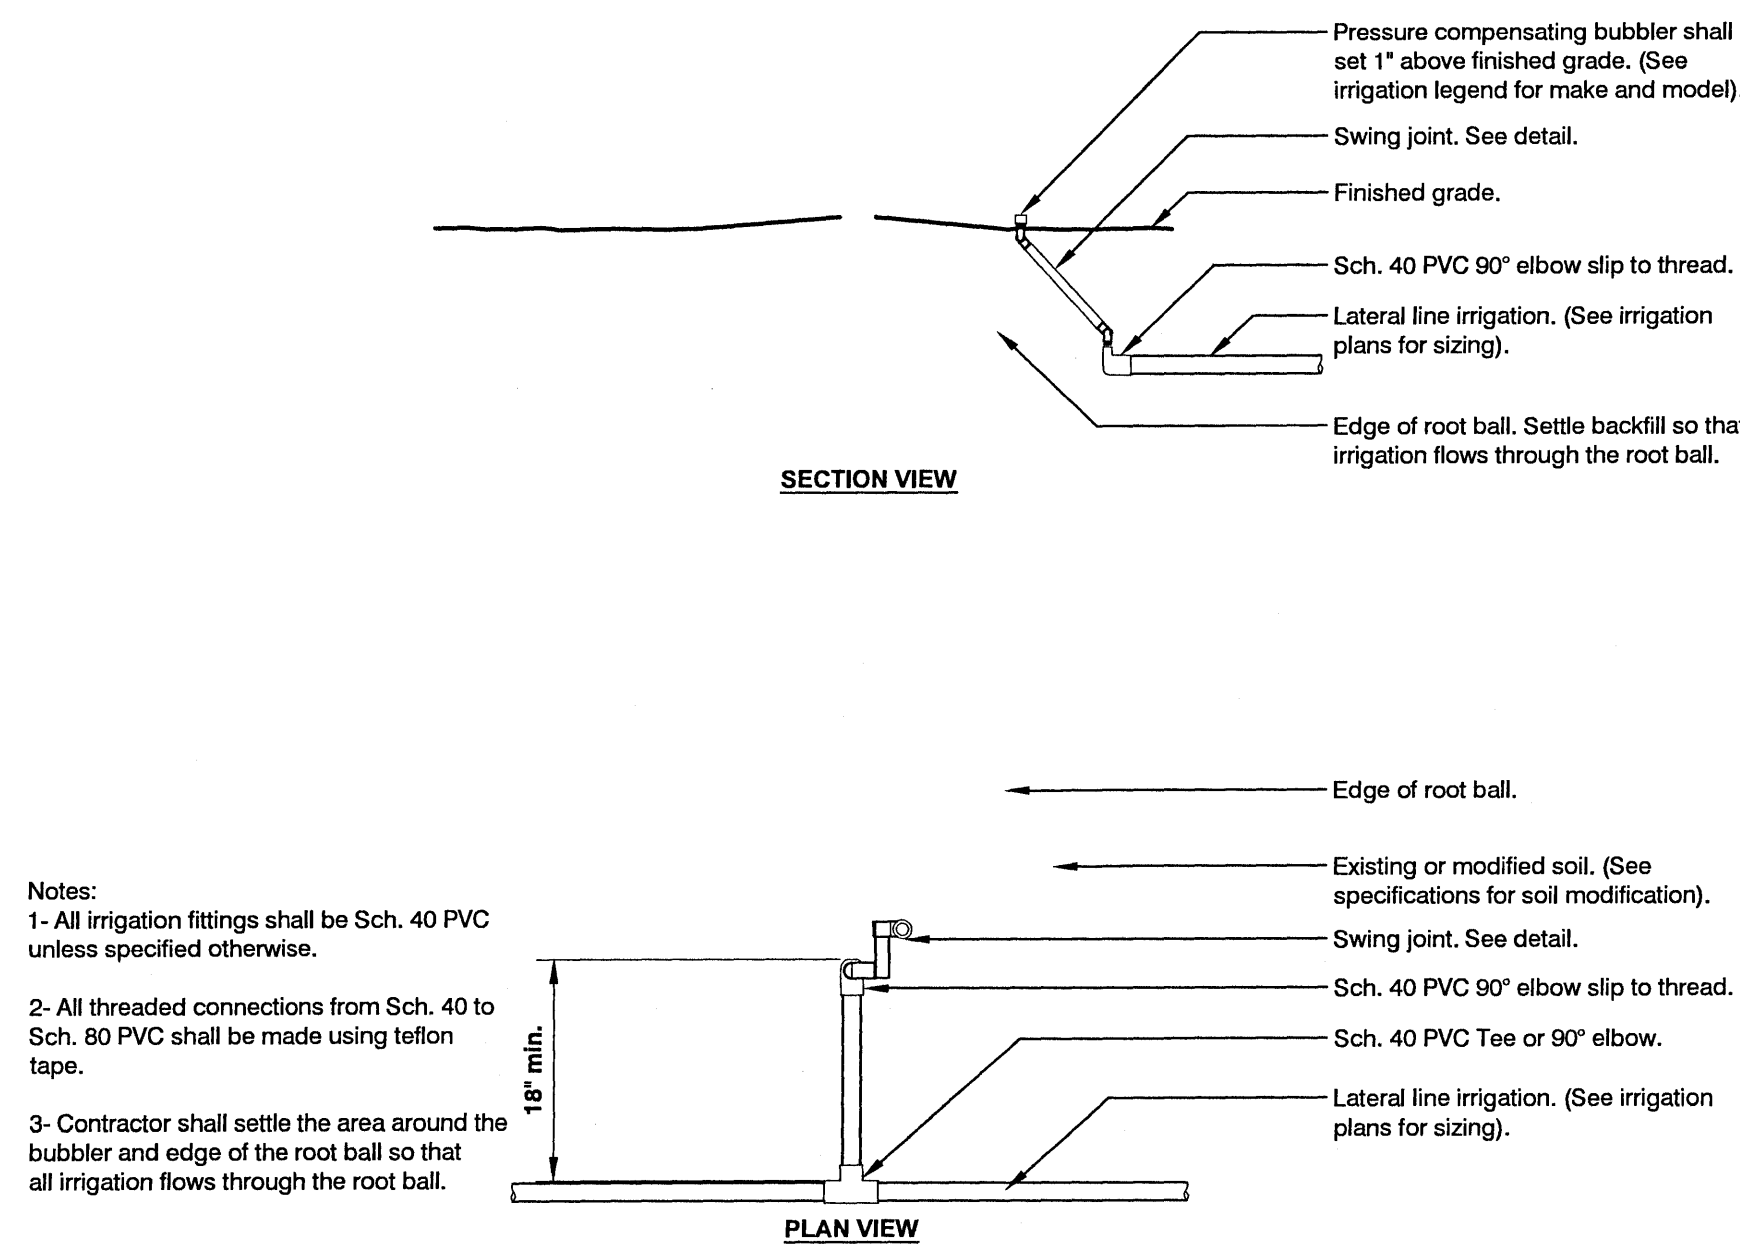
SITE DEVELOPMENT
PLANS FOR
FRONTIER MOTORS
PRIVATE STORAGE
IRRIGATION LEGEND
& DETAILS
ESCAMBIA COUNTY FLORIDA

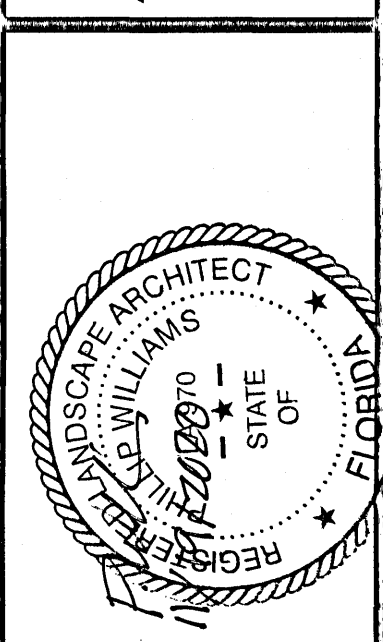DRAWN BY: CUB	DESIGNED BY: RLS
CHECKED BY: TGH	DATE: 9-3-20
SCALE: AS SHOWN	NOT RELEASED FOR CONSTRUCTION
BY:	DATE:


PROJECT NO: 20-035
SHEET: C7.2




1 IRRIGATION TRENCHING
1 1/2" = 1'-0"

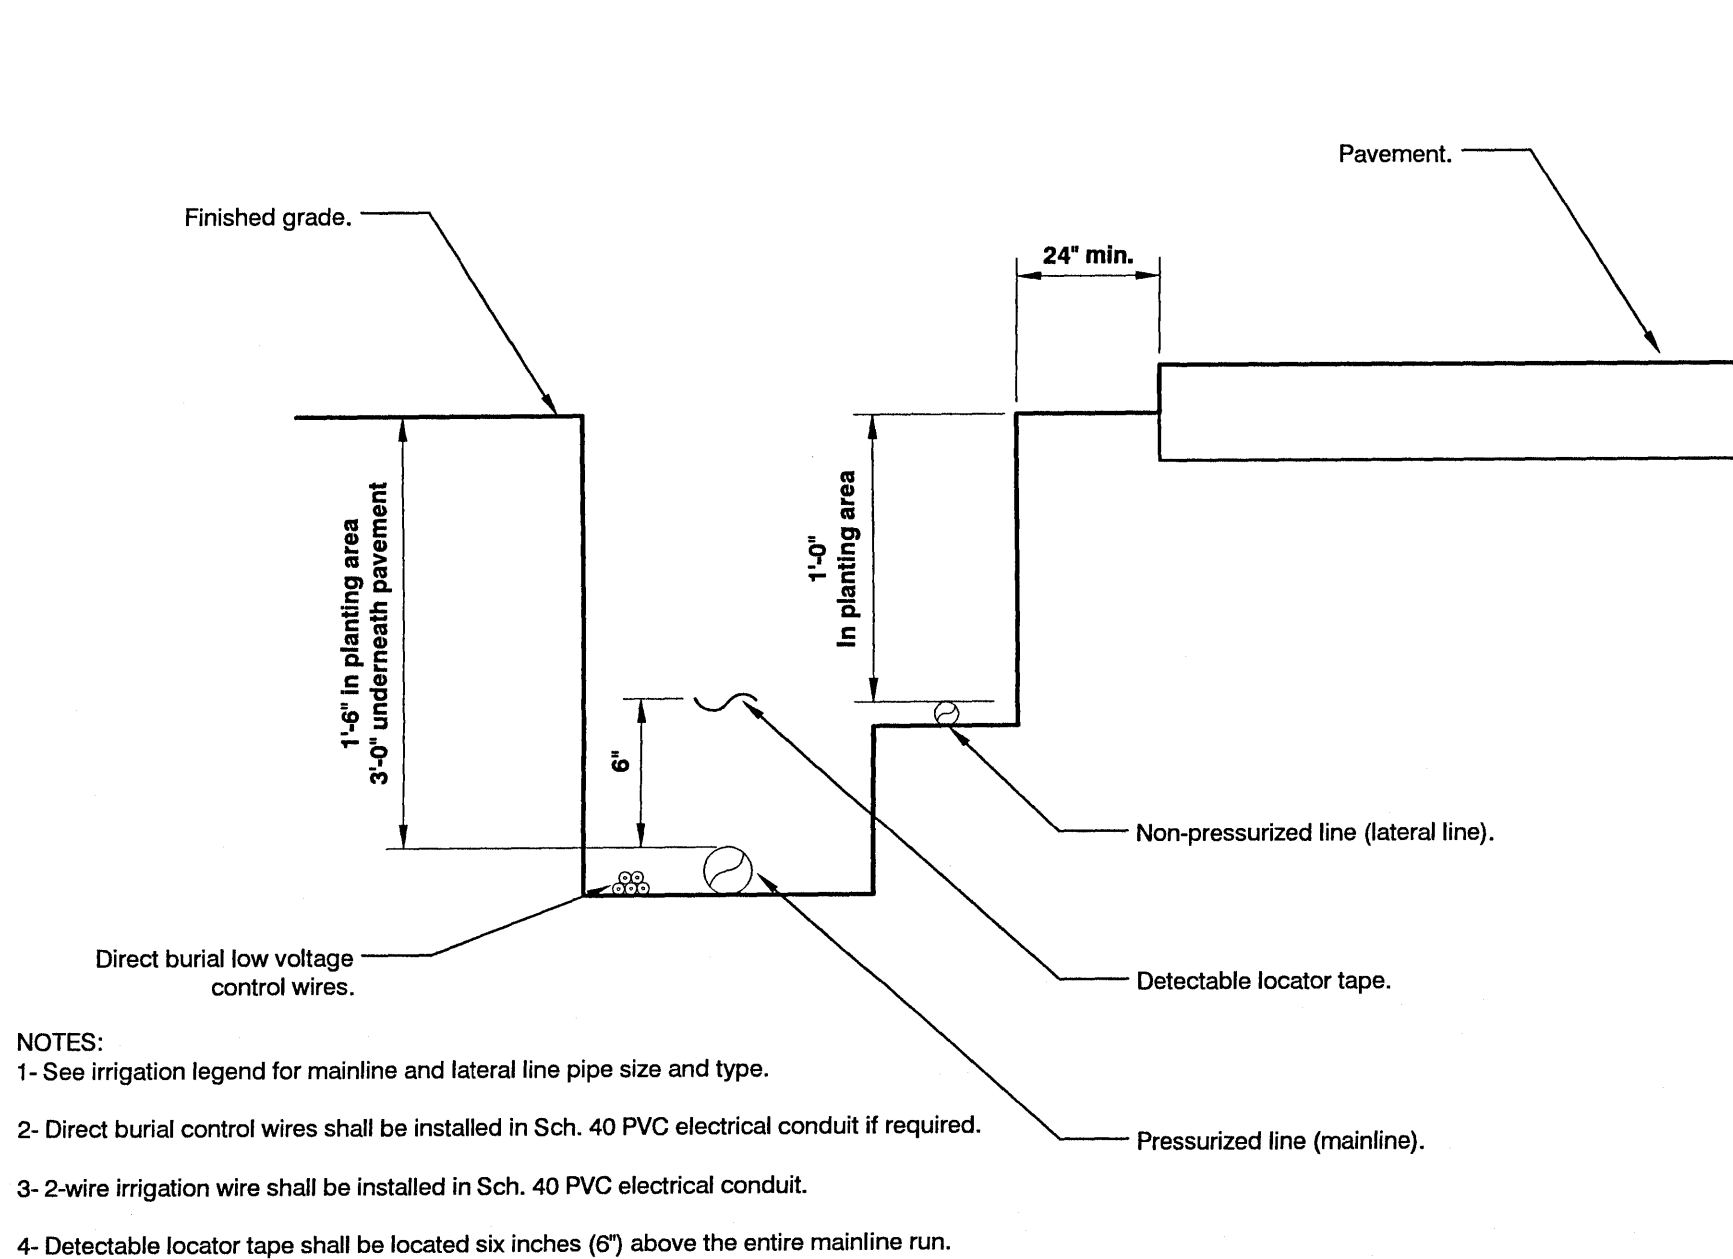


2 IRRIGATION BUBBLER W/ LAYOUT
3/4" = 1'-0"

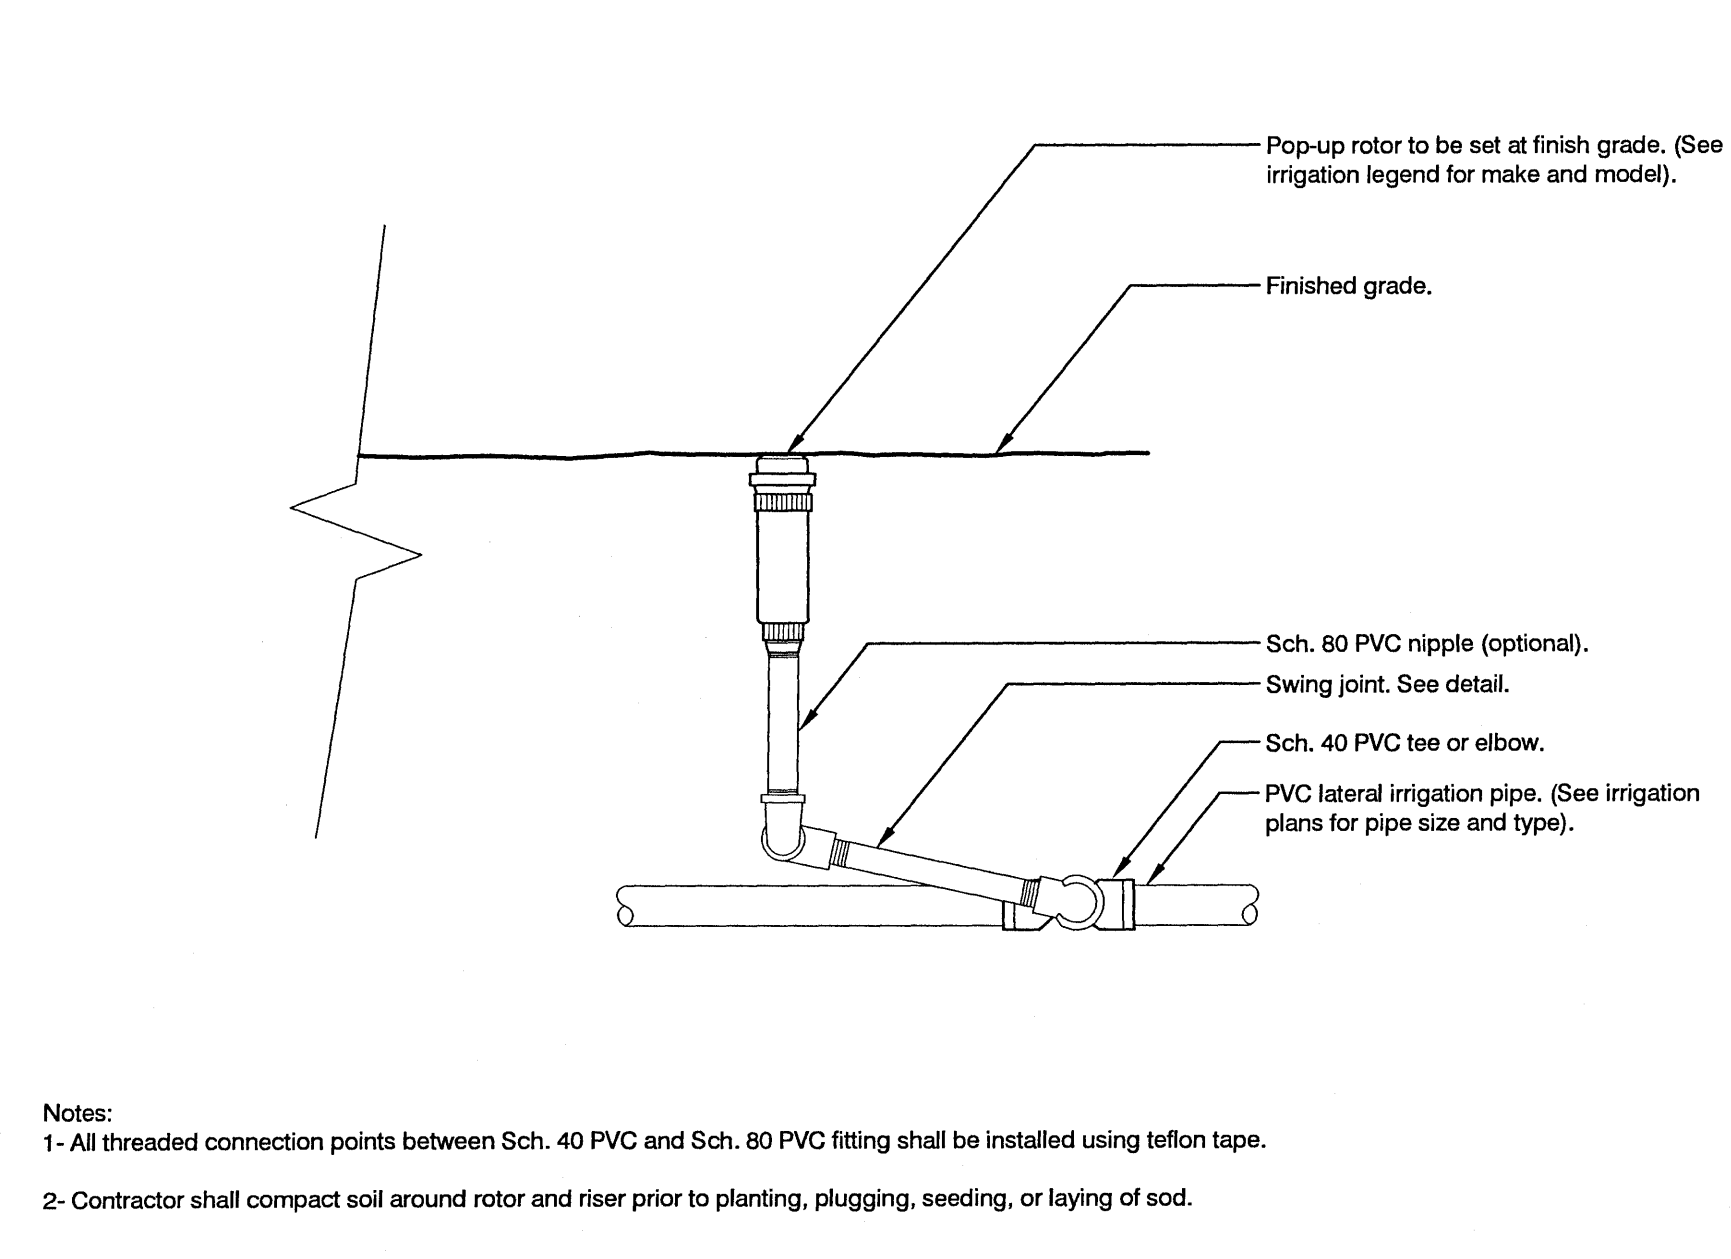


3 ROTOR SPRAYHEAD
1 1/2" = 1'-0"

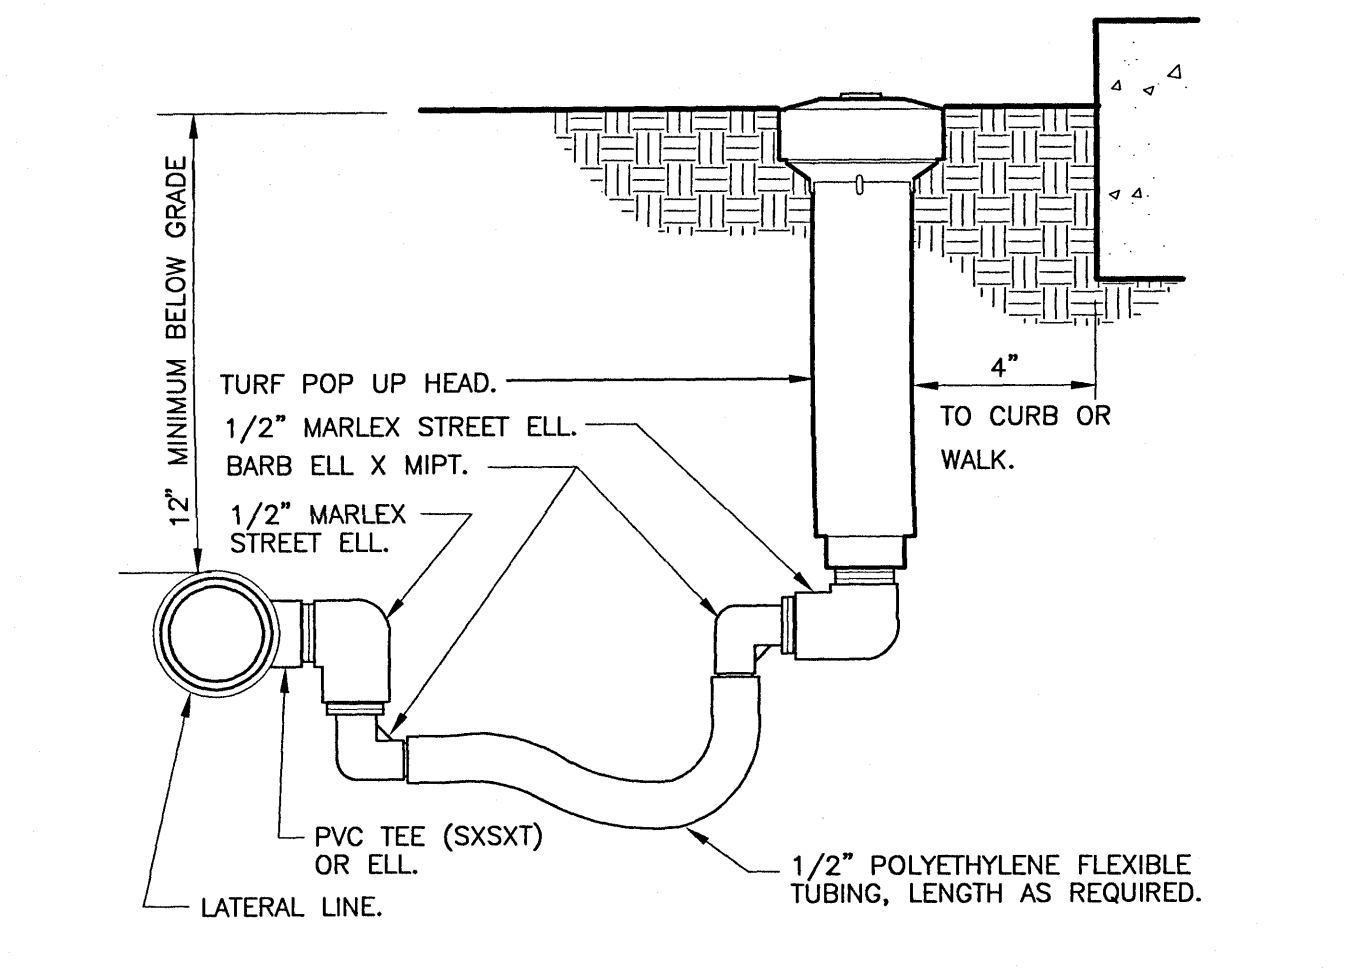

4 TURF SPRAY FLEX ASSEMBLY
3" = 1'-0"

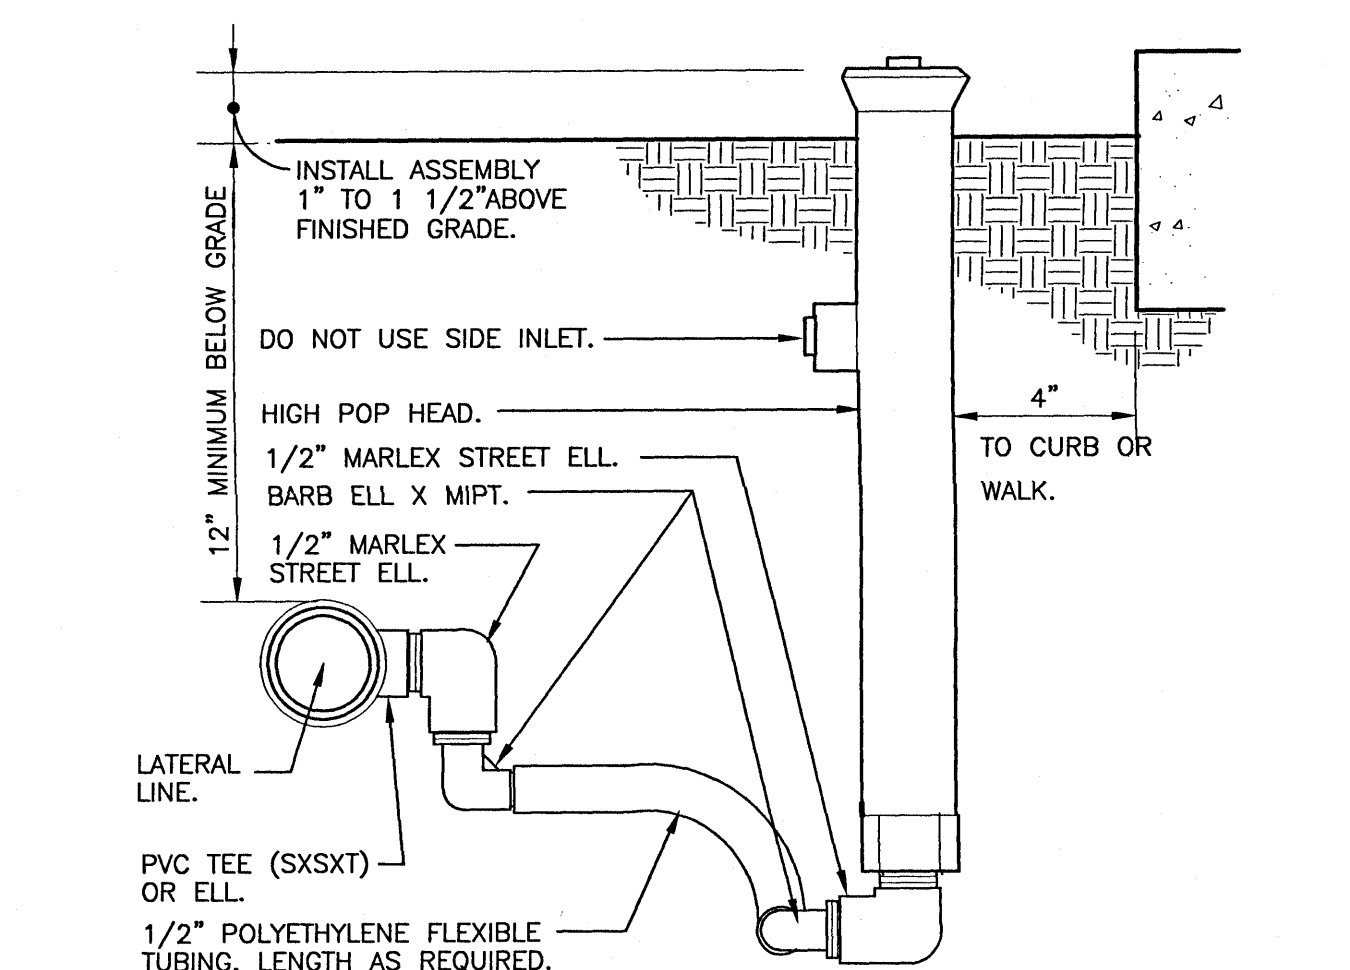

5 SHRUB SPRAY HIGHPOP W/FLEX ASSEMBLY
3" = 1'-0"

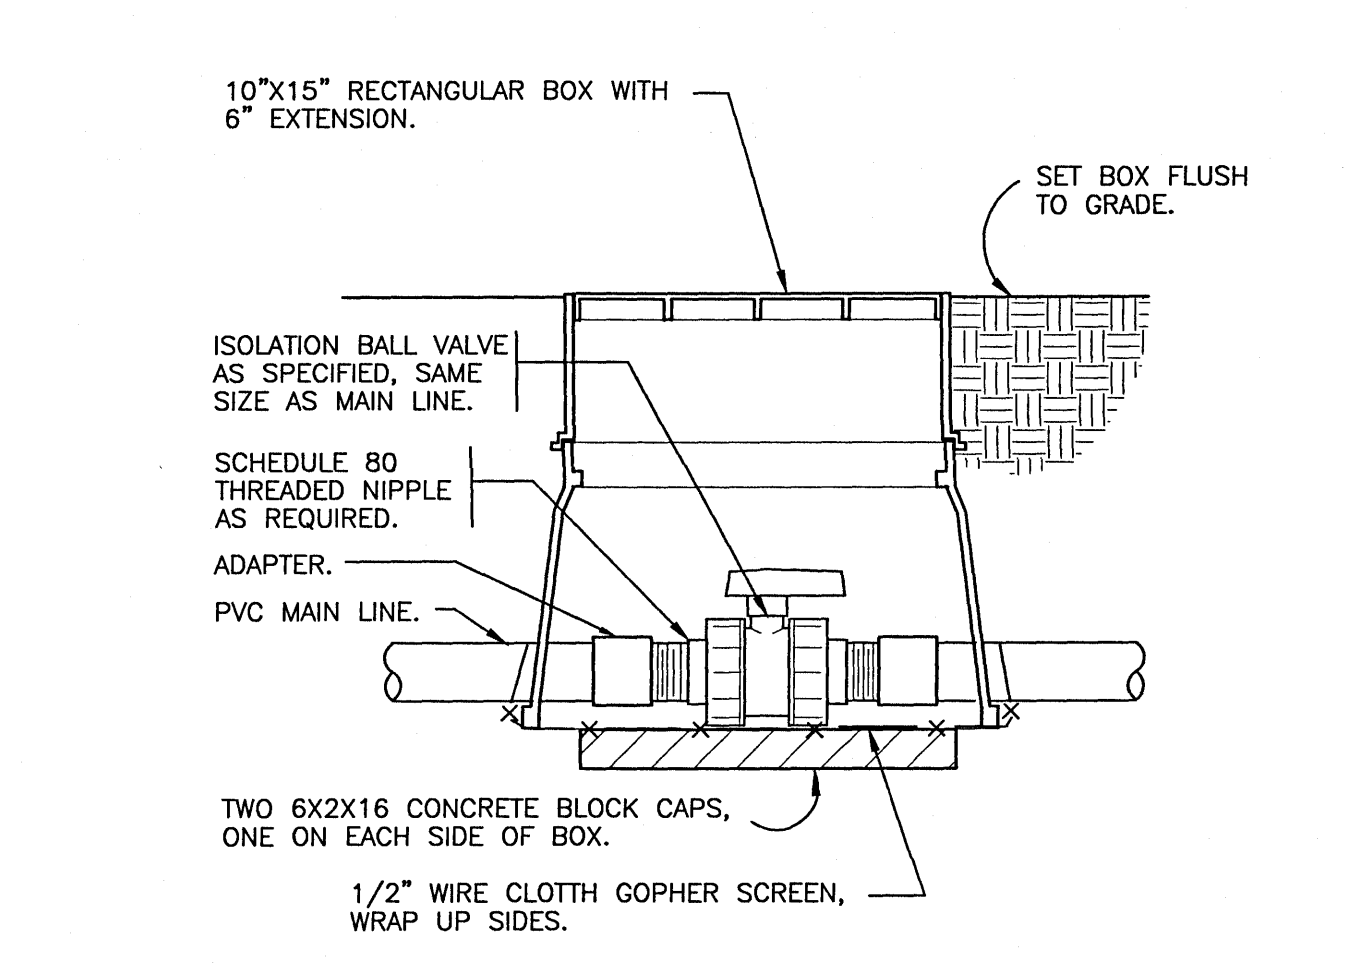

6 TRUE UNION BALL ISOLATION VALVE
1 1/2" = 1'-0"

REVISIONS NO. DATE A 11/08/2020 REVISED PLANS AS PER ESCAMBA COUNTY DRC REVIEW COMMENTS	
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HAMMOND ENGINEERING, INC. FLORIDA AUTHORIZATION NO. 9130 ALABAMA AUTHORIZATION NO. 3277 3802 NORTH "S" STREET PENSACOLA, FLORIDA 32505 850 434-2603 FAX 850-434-2650 TOM@SELANDESIGN.COM	
REGISTERED LANDSCAPE ARCHITECT WILLIAM S. WILLIAMS No. 19178 State of FLORIDA	
SITE DEVELOPMENT PLANS FOR FRONTIER MOTORS PRIVATE STORAGE IRRIGATION DETAILS ESCAMBA COUNTY FLORIDA	
DRAWN BY: CJS DESIGNED BY: RLS CHECKED BY: TGH DATE: 9-3-20 SCALE: AS SHOWN NOT RELEASED FOR CONSTRUCTION	BY: DATE:
PROJECT NO: 20-035 SHEET: C7.3	