SITE DATA

Gross Project Area: Wetland Area:

Gross Density: Current Zoning: Type of Subdivision

Number of Lots:

Contour Interval:

Street Length:

Type of Streets: R/W Width:

Pavement Width: Street Maintenance: Stormwater Maintenance

Min. Depth of Front Yard:

Min. Depth of Rear Yard:

SADDLE RIDGE PHASE ONE LEGAL DESCRIPTION

SAID POINT FURTHER DESCRIBED AS BEING THE POINT OF BEGINNING;

THENCE N 03°21'00" E A DISTANCE OF 175.80';

THENCE S 86°39'00' E A DISTANCE OF 50.00'; THENCE N 03°21'00" E A DISTANCE OF 88.69" THENCE S 86°52'12" E A DISTANCE OF 435.44'; THENCE N 03°07'48" E A DISTANCE OF 180.00

Property Owner(s): Donald E. & Rita K. Wise

OR BK 7905, PG 370

OR BK 3742, PG 926

Breland Homes Coastal, LLC

801 W. Romana St. Suite A Pensacola, FL 32502

801 W. Romana St. Suite A

801 W. Romana St. Suite A Pensacola, FL 32502

(251) 263-3513 - kevin@mullinsllc.net

(256) 975-0653 - eric@mullinsllc.net Eric Lane, P.E. - FL License # 86920

0 Acres

Single-Family 83 Lots

26' B.O.C. To B.O.C.

52.00' x 130.0' (6,760 SF)

One-Foot

4,332 LF

Public

25 feet

25.91 Acres (25.91 Buildable)

3.20 Units / Acre (Residential)

Florida North NAD1983 & NGVD88

Kevin Gardner, PLS - FL License # 7258

Pensacola, FL 32502

Clayton E. Wise

Mullins, LLC

Mullins, LLC

CONSTRUCTION PLANS FOR Total Drainage Fee \$4,002.14 SADDLE RIDGE PHASE 1

A 83 LOT SUBDIVISION IN A PORTION OF SECTION 16 TOWNSHIP 1 SOUTH, RANGE 31 WEST ESCAMBIA COUNTY, FLORIDA

ZONED: LDR

FUTURE LAND USE: MU-S

DEVELOPER: BRELAND HOMES COASTAL, LLC 801 W. ROMANA ST. SUITE A PENSACOLA, FL 32502

HILLAHASSEE BASE LINE

LOCATION MAP

ISSUED FOR CONSTRUCTION



DRAINAGE FEE

This document has been reviewed in accordance with

Regulations and Ordinances, and does not in any way

relieve the submitting Architect, Engineer, Surveyor, or

other signatory from responsibility of details as drawn.

requirements of applicable Escambia County

COVED

Imperv. Surf. 119,467 Sq ft

Stormwater Ret. .67 % (F)

Pond Maint. Fee: MSBU

The ECUA Engineering Manual, dated December 18, 2014, along with Update # 1 dated September 1, 2016 (hereinafter "Manual"), located at www.ecua.fl.gov, is hereby incorporated by reference into this Project's official contract documents as if fully set forth therein. It is the Contractor's responsibility to be knowledgeable of the Manual's contents and to construct the Project in accordance with the Manual. The Contractor shall provide its employees access to the Manual at all times, via Project site or office, via digital or paper format. In the event of a conflict between the Manual and Plans, Contractor shall consult Engineer of Record for proper resolution.

ECUA Engineering Manual Reference Note*

applicable only to ECUA infrastructure to be constructed in public ROW or in utility easement; not to be

applied to private water/sewer facilities on private property (see Building Code) A. ECUA Engineering Manual Incorporated by Reference

B. Additional Documents (to be completed by the Engineer of Record) Does this Project have additional technical specifications or construction details that supplement and/or supersede the Manual listed above? ★YES NO□. If yes, Contractor shall construct Project in accordance with said documents as listed and

Document Type		Location	
Specifi- cation	Detail	Plans	Project Manual*
	X	X	
	X	X	
	Specifi-	Specification Detail	Specification Detail Plans

C. Engineer of Record Responsibilities

The Engineers of Record (EORs) that have affixed their seals and signatures on these plans warrant their portions of the plans have been designed in accordance with the Manual (unless otherwise directed by the ECUA Project Engineer). The EORs shall be knowledgeable of the Manual's contents and shall assume responsibility for its use

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PLANS PREPARED BY:



801 W. Romana St., Suite A, Pensacola, FL 32502 (850) 462-8412

Mullins Project No. 20-123P

NOTE: THE SCALE OF THESE PLANS MAY HAVE CHANGED DUE TO REPRODUCTION.

> CONSTRUCTION PLAN SET February 2021

SHOP DRAWINGS TO BE SUBMITTED TO: MULLINS, LLC ATTN: ERIC LANE, P.E. 801 W. ROMANA ST. SUITE A PENSACOLA, FL 32502

ENGINEERING STATEMENT

ALL PROPOSED ROADWAYS, DRAINAGE, AND OTHER IMPROVEMENTS ARE DESIGNED TO COMPLY WITH ALL APPLICABLE FEDERAL, STATE, AND LOCAL DEVELOPMENT REQUIREMENTS.

ENGINEER OF RECORD: ERIC LANE, P.E. P.E. NO. <u>86920</u>

On each side, 5 feet or 10% of the lot width at the street right-of-way, whichever is greater, but not required to exceed 15 feet Will have one front setback (25') and a fifteen feet setback (15') COMMENCING AT A CAPPED 1/2" REBAR FOUND ON THE NORTHERLY RIGHT OF WAY MOBILE HIGHWAY(U.S. HIGHWAY 90), SAID POINT FURTHER DESCRIBED AS BEING ON THE WEST LINE OF SECTION 16 AND LOCATED N 03°10'02" E A DISTANCE OF 1687.48' FROM THE SOUTHWEST CORNER OF SECTION 16, TOWNSHIP 1 SOUTH, RANGE 31 WEST, ESCAMBIA COUNTY, FLORIDA; THENCE FROM THE POINT OF COMMENCEMENT AND ALONG THE EXISTING SAID NORTHERLY RIGHT OF WAY \$ 58°19'55' F. A. DISTANCE OF 473.34' TO A CAPPED 1/2" REBAR FOUND(KL MONIE 4655). THENCE CONTINUE ALONG THE EXISTING SAID NORTHERLY RIGHT OF WAY \$ 58°13'20" E A DISTANCE OF 193.47' TO A CAPPED 1/2" REBAR FOUND(PARKER 3286), THENCE LEAVING THE EXISTING SAID NORTHERLY RIGHT OF WAY LINE N 04°52′16" E A DISTANCE OF 19.00' TO A POINT ON THE DEDICATED NORTHERLY RIGHT OF WAY FOR MOBILE HIGHWAY(U.S. 90), THENCE FROM THE POINT OF BEGINNING AND LEAVING SAID DEDICATED NORTHERLY RIGHT OF WAY N 04"52"16" E A DISTANCE OF 315.09"

THENCE S 86°52'12" E A DISTANCE OF 9.68'; THENCE N 03°07'48" E A DISTANCE OF 130.00' THENCE N 86°52'12" W A DISTANCE OF 52.00'; THENCE N 03°07'48" E A DISTANCE OF 180.00'; THENCE S 86°52'12" E A DISTANCE OF 117.73'; THENCE WITH A CURVE TURNING TO THE LEFT HAVING AN ARC LENGTH OF 29.07', A RADIUS OF 25.00', A CHORD BEARING OF N 59°49'08' E, AND A CHORD LENGTH OF 27.46'; THENCE WITH A CURVE TURNING TO THE RIGHT HAVING AN ARC LENGTH OF 7.82', A RADIUS OF 325.00', A CHORD BEARING OF N 27°11'50' E, AND A CHORD LENGTH OF 7.82'; THENCE N 27°53'11" E A DISTANCE OF 114.98'; THENCE N 62°06'49" W A DISTANCE OF 850.40'; THENCE N 27°53'11" E A DISTANCE OF 38.78' TO A CAPPED 1/2" REBAR FOUND (ROWE FL 1540); THENCE N 01°42'44" E A DISTANCE OF 336.11' TO THE SOUTHERLY LINE OF BRIDLEWOOD AS RECORDED IN PLAT BOOK 19 PAGE 21 IN THE ESCAMBIA COUNTY CLERK'S OFFICE; THENCE ALONG SAID SOUTHERLY LINE OF BRIDLEWOOD S 86°39'29" E A DISTANCE OF 866.28' TO A 4" X 4" CONCRETE MONUMENT FOUND(RLS 0044); THENCE ALONG THE WESTERLY LINE OF BRIDLEWOOD S 03°07'46" W A DISTANCE OF 1.954.50': THENCE N 87°16'30" W A DISTANCE OF 357.09' TO A FENCE CORNER POST;

THENCE S 32°57'04" W A DISTANCE OF 25.26' TO FENCE CORNER POST; THENCE N 87°06'54" W A DISTANCE OF 266.53" TO A POINT ON THE DEDICATED NORTHERLY RIGHT OF WAY FOR MOBILE HIGHWAY(U.S. 90): THENCE ALONG SAID DEDICATED NORTHERLY RIGHT OF WAY N 58°33'43' W A DISTANCE OF 126.69' TO THE POINT OF BEGINNING, CONTAINING 25.16 ACRES, MORE OR LESS.

together with a 25' wide drainage right of way more particularly described as follows: COMMENCING AT A CAPPED 1/2" REBAR FOUND ON THE NORTHERLY RIGHT OF WAY MOBILE HIGHWAY(U.S. HIGHWAY 90), SAID POINT FURTHER DESCRIBED AS BEING ON THE WEST LINE OF SECTION 16 AND LOCATED N 03°10'02" E A DISTANCE OF 1687.48' FROM THE SOUTHWEST CORNER OF SECTION 16. TOWNSHIP 1 SOUTH, RANGE 31 WEST, ESCAMBIA COUNTY, FLORIDA: THENCE FROM THE POINT OF COMMENCEMENT AND ALONG THE EXISTING SAID NORTHERLY RIGHT OF WAY 5 58°19'55' E A DISTANCE OF 473.34' TO A CAPPED 1/2' REBAR FOUND(KJ MONIE 4655); THENCE CONTINUE ALONG THE EXISTING SAID NORTHERLY RIGHT OF WAY \$ 58°13'20" E A DISTANCE OF 193.47' TO A CAPPED 1/2" REBAR FOUND(PARKER 3286); THENCE LEAVING THE EXISTING SAID NORHTERLY RIGHT OF WAY LINE N 04°52'16' E A DISTANCE OF 19.00' TO A POINT ON THE DEDICATED NORTHERLY RIGHT OF WAY FOR MOBILE HIGHWAY(U.S. 90); THENCE LEAVING SAID DEDICATED NORTHERLY RIGHT OF WAY N 04°52′16″ E A DISTANCE OF 315.09′; THENCE N 03°21'00° E A DISTANCE OF 175.80' TO THE POINT OF BEGINNING;

THENCE FROM THE POINT OF BEGINNING N 03°21'00" E A DISTANCE OF 193.40'; THENCE WITH A CURVE TURNING TO THE LEFT HAVING AN ARC LENGTH OF 39.37', A RADIUS OF 25.00', A CHORD BEARING OF N 41°45'36' W, AND A CHORD LENGTH OF 35.42'; THENCE N 86°52'12" W A DISTANCE OF 133.28';

THENCE WITH A CURVE TURNING TO THE RIGHT HAVING AN ARC LENGTH OF 33.39', A RADIUS OF 225.00', A CHORD BEARING OF N 07°22'54' E, AND A CHORD LENGTH OF33.36'; THENCE N 11°38'00" E A DISTANCE OF 62.30": THENCE WITH A CURVE TURNING TO THE LEFT HAVING AN ARC LENGTH OF 30.85', A RADIUS OF 475.00', A CHORD BEARING OF N 09°46'22' E, AND A CHORD LENGTH OF 30.84 THENCE WITH A CURVE TURNING TO THE RIGHT HAVING AN ARC LENGTH OF 78.44', A RADIUS OF 225.00', A CHORD BEARING OF N 17°53'57" E. AND A CHORD LENGTH OF 78.04'.

THENCE N 27°53'11" E A DISTANCE OF 164.82'; THENCE S 62°06'49" E A DISTANCE OF 25.00'; THENCE S 27°53'11" W A DISTANCE OF 164.82', THENCE WITH A CURVE TURNING TO THE LEFT HAVING AN ARC LENGTH OF 69.72', A RADIUS OF 200.00', A CHORD BEARING OF \$ 17°53'57" W, AND A CHORD LENGTH OF 69.37'; THENCE S 07°54'44" W A DISTANCE OF 199 20'

THENCE WITH A CURVE TURNING TO THE RIGHT HAVING AN ARC LENGTH OF 32.47', A RADIUS OF 500.00', A CHORD BEARING OF 5 09°46'22° W, AND A CHORD LENGTH OF 32.47'; THENCE WITH A CURVE TURNING TO THE LEFT HAVING AN ARC LENGTH OF 29.68', A RADIUS OF 200.00', A CHORD BEARING OF S 07°22'54' W, AND A CHORD LENGTH OF 29.65'; THENCE S 03°07'48" W A DISTANCE OF 193.57'. THENCE WITH A CURVE TURNING TO THE LEFT HAVING AN ARC LENGTH OF 117.81', A RADIUS OF 75.00', A CHORD BEARING OF \$ 41°52'12' E, AND A CHORD LENGTH OF 106.07'; THENCE S 86°52'12" E A DISTANCE OF 183.48';

THENCE S 03°21'00" W A DISTANCE OF 243.60', THENCE N 86°39'00" W A DISTANCE OF 25.00' TO THE POINT OF BEGINNING, CONTAINING 0.75 ACRES, MORE OR LESS

February 2021

GENERAL NOTES

- 1. THE CONTRACTORS SHALL NOTIFY THE COUNTY DESIGN ENGINEER OR DESIGNEE 48 HOURS PRIOR TO CONSTRUCTION.
- 2. ALL CONDITIONS AND STIPULATIONS OF THE CONSTRUCTION PERMITS AND THE APPROVALS ISSUED BY THE ESCAMBIA COUNTY ENGINEER SHALL BE COMPLIED WITH IN EVERY DETAIL.
- 3. ALL ROADS DAMAGED BY CONSTRUCTION OPERATIONS ARE TO BE PATCHED OR RECONSTRUCTED AS DIRECTED BY THE COUNTY ENGINEER OR DESIGNEE.
- 4. THE CONTRACTOR SHALL TAKE STEPS NECESSARY TO PREVENT EROSION AND ANY OFF SITE SEDIMENT TRANSPORT RESULTING FROM INCREASED RUNOFF DURING CONSTRUCTION BY PROVIDING SILT FENCE AND/OR STAKED HAY BALES AS REQUIRED BY FDOT SPECIFICATION 104, THE FLORIDA STORMWATER, EROSION, AND SEDIMENT CONTROL INSPECTOR'S MANUAL, LATEST EDITION, OR AS INDICATED ON THE PLANS. ALL EROSION CONTROL MEASURES SHALL REMAIN IN PLACE UNTIL ASSOCIATED DISTURBED AREAS ARE STABILIZED AS TO REDUCE SEDIMENT RUNOFF, UNLESS OTHERWISE DIRECTED BY THE ENGINEER OR DESIGNEE.
- 5. ANY NECESSARY PERMITS WILL BE THE RESPONSIBILITY OF THE CONTRACTOR. ESCAMBIA COUNTY OR ITS DESIGNEE WILL ASSIST THE CONTRACTOR WITH REQUIRED PERMITS.
- 6. THE CONTRACTOR IS CAUTIONED TO VISIT THE SITE AND FAMILIARIZE THEMSELVES WITH THE PROJECT PRIOR TO BIDDING AND/OR CONSTRUCTION.
- 7. IT SHALL BE THE CONTRACTORS RESPONSIBILITY TO PRESERVE OR RELOCATE ALL BENCHMARKS (VERTICAL CONTROL) AS NEEDED DURING CONSTRUCTION. ALL PUBLIC OR PRIVATE CORNER MONUMENTATION IS IN DANGER OF BEING DESTROYED AND HAS NOT BEEN PROPERLY REFERENCED, THE CONTRACTOR SHALL NOTIFY THE ENGINEER OR DESIGNEE IMMEDIATELY. ANY ESCAMBIA COUNTY HARN/GPS NETWORK MONUMENTS OR BUREAU OF SURVEY AND MAPPING GPS NETWORK MONUMENTS WITHIN THE LIMITS OF CONSTRUCTION SHALL BE PROTECTED. IF ANY HARN/GPS NETWORK MONUMENTS OR BUREAU OF SURVEY AND MAPPING GPS NETWORK MONUMENTS ARE DISTURBED OR DESTROYED THE CONTRACTOR SHALL BE RESPONSIBLE FOR REPLACEMENT OF THE MONUMENTS AND HAVE THE MONUMENTS POSITION DETERMINED BY A FLORIDA LICENSED PROFESSIONAL SURVEYOR AND MAPPER USING GUIDELINES AS ESTABLISHED BY NATIONAL GEODETIC SURVEY FOR BLUE BOOKING AND APPROVAL.
- 8. EXISTING DRAINAGE FEATURES WITHIN CONSTRUCTION LIMITS SHALL REMAIN UNLESS OTHERWISE NOTED.
- 9. THE CONTRACTOR SHALL MATCH EXISTING CONDITIONS AT THE BEGINNING AND END OF CONSTRUCTION AS DIRECTED BY THE COUNTY ENGINEER OR DESIGNEE.
- 10 EXISTING STREETS AND DRIVES SHALL BE MAINTAINED TO LOCAL TRAFFIC AND PROPERTY OWNERS.
- 11. ALL ROADWAY CONSTRUCTION SHALL COMPLY WITH THE ESCAMBIA COUNTY TECHNICAL SPECIFICATIONS, LATEST EDITION.
- 12. ALL MATERIALS, TESTING AND CONSTRUCTION METHODS SHALL CONFORM TO THE ESCAMBIA COUNTY TECHNICAL SPECIFICATIONS, LATEST EDITION.
- 13. ANY REFERENCE TO FDOT STANDARD SPECIFICATIONS FOR ROAD AND BRIDGE CONSTRUCTION, LATEST EDITION, DIVISION 1, GENERAL REQUIREMENTS AND COVENANTS, SHALL BE EXCLUDED AND NOT APPLICABLE TO ANY SPECIFICATION REFERRED HEREIN OR OTHERWISE LISTED IN THESE PLANS OR RELATED DOCUMENTS OR THE ESCAMBIA COUNTY TECHNICAL SPECIFICATIONS.
- 14. EXISTING STREET AND ROAD NAME SIGNS ON THE PROJECT SHALL BE KEPT VISIBLE AT ALL TIMES FOR THE FACILITATION OF ACCESS BY EMERGENCY VEHICLES. ALL OTHER EXISTING SIGNS THAT CONFLICT WITH CONSTRUCTION OPERATIONS SHALL BE TAKEN DOWN AND STOCKPILED WITHIN THE R/W LIMITS BY THE CONTRACTOR, AS DIRECTED BY THE COUNTY ENGINEER OR DESIGNEE. ANY EXISTING SIGNS THAT ARE TO BE RELOCATED AND ARE DAMAGED BEYOND USE BY THE CONTRACTOR, SHALL BE REPLACED BY THE CONTRACTOR AT HIS/HER EXPENSE.
- 15. CONTRACTOR SHALL COMPLY WITH ALL F.D.E.P. AND ARMY CORP. OF ENGINEERS REQUIREMENTS.
- 16. IN THE EVENT THAT SURVEY MONUMENTATION OR REFERENCE POINTS ARE MISSING OR HAVE BEEN DESTROYED, PLEASE CONTACT:
- ESCAMBIA COUNTY SURVEYOR 3363 WEST PARK PLACE
- PENSACOLA, FLORIDA 32505 PH (850) 595-3427
- 17. GRADED AGGREGATE BASE SHALL BE REQUIRED WHERE THE SEASONAL HIGH GROUND WATER ENCROACHES WITHIN TWO (2) FEET OF THE BOTTOM OF BASE.
- 18. TREES WITHIN LIMITS OF CONSTRUCTION SHALL BE REMOVED UNLESS OTHERWISE NOTED IN PLANS.
- 19. ALL COMPACTED FILL SHALL BE PLACED IN FOUR INCH (4") LIFTS FOR HAND POWERED TAMPERS AND EIGHT INCH (8") LIFTS FOR HEAVY EQUIPMENT OPERATED TAMPERS.

CONTRACTOR SHALL CONTACT THE COUNTY TRAFFIC DEPARTMENT PRIOR TO INSTALLATION OF ANY SIGNING AND PAVEMENT MARKINGS.

- 20. MAINTENANCE OF TRAFFIC AS PER FDOT INDEX 600.
- 21. THE CONTRACTOR SHALL, AT A MINIMUM, MATCH EXISTING SIGNING AND PAVEMENT MARKINGS. ALL SIGNING AND PAVEMENT MARKINGS SHALL BE PLACED IN ACCORDANCE WITH THE LATEST FDOT DESIGN STANDARDS. THE
- 22. ALL ADEQUATE TREE PROTECTION MEASURES AND BARRICADES SHALL BE INSTALLED PRIOR TO SITE DISTURBANCE AND MAINTAINED IN GOOD WORKING ORDER UNTIL PROJECT IS COMPLETE AND SITE BECOMES STABILIZED.
- 22. ALL ADEQUATE TREE PROTECTION MEASURES AND BARRICADES STALLED FRIOR TO SHE DISTORDANCE AND MAINTAINED IN GOOD WORKING ORDER UNTIL PROJECT IS COMPLETE AND SHE BECOMES STABILIZED.
- 23. TEMPORARY BENCHMARKS HAVE BEEN ESTABLISHED ON THIS PROPERTY WHICH SHOULD BE USED BY THE CONTRACTOR DURING CONSTRUCTION. DESCRIPTIONS OF THE BENCHMARKS CAN BE FOUND IN THESE PLANS.

 24. CLEARING AND GRUBBING SHALL BE LIMITED TO THE ROADWAY RIGHT-OF-WAY DRAINAGE FASEMENTS AND DETENTION PONDS. NO ADDITIONAL CLEARING OTHER THAN SPECIFIED ON THE PLANS SHALL BE ALLOWED LINLESS.
- 24. CLEARING AND GRUBBING SHALL BE LIMITED TO THE ROADWAY RIGHT-OF-WAY, DRAINAGE EASEMENTS AND DETENTION PONDS. NO ADDITIONAL CLEARING OTHER THAN SPECIFIED ON THE PLANS SHALL BE ALLOWED, UNLESS PROPER PERMITS ARE OBTAINED THROUGH THE COUNTY.
- 25. ALL UNDERGROUND UTILITIES AND DRAINAGE STRUCTURES SHALL BE INSTALLED PRIOR TO CURB AND BASE CONSTRUCTION.
- 26. THE CONTRACTOR SHALL COORDINATE ALL REQUIRED TESTING WITH THE SOILS ENGINEER. PAYMENT FOR TESTING WILL BE IN ACCORDANCE WITH THE CONTRACT DOCUMENTS.
- 27. THE CONTRACTOR SHALL ADJUST ALL VALVE BOX AND MANHOLE CASTINGS TO MATCH FINAL SURFACE ELEVATIONS.
- 28. THE PROJECT ENGINEER (ENGINEER OF RECORD) SHALL PROVIDE TO ESCAMBIA COUNTY "AS-BUILT" RECORD DRAWINGS FOR VERIFICATION AND APPROVAL BY ESCAMBIA COUNTY ONE WEEK PRIOR TO REQUESTING A FINAL INSPECTION, AND PROVIDE "AS-BUILT" CERTIFICATION THAT THE PROJECT CONSTRUCTION ADHERES TO THE PERMITTED PLANS AND SPECIFICATIONS. THE "AS-BUILT" CERTIFICATION OR THE "AS-BUILT" RECORD DRAWINGS MUST BE SIGNED, SEALED AND DATED BY THE REGISTERED FLORIDA PROFESSIONAL ENGINEER.
- 29. CONTRACTOR SHALL MAINTAIN RECORD DRAWINGS DURING CONSTRUCTION WHICH SHOW "AS-BUILT" CONDITIONS OF ALL WORK INCLUDING PIPING, DRAINAGE STRUCTURES, TOPO OF POND(S), OUTLET STRUCTURES, DIMENSIONS, ELEVATIONS, GRADING ETC. RECORD DRAWINGS SHALL BE PROVIDED TO THE ENGINEER OF RECORD PRIOR TO REQUESTING FINAL INSPECTION.
- 30. THE OWNER OR HIS AGENT SHALL ARRANGE/SCHEDULE WITH THE COUNTY A FINAL INSPECTION OF THE DEVELOPMENT UPON COMPLETION AND ANY INTERMEDIATE INSPECTIONS AT (850) 595-3434. AS-BUILT PLANS AND CERTIFICATION ARE REQUIRED PRIOR TO REQUEST FOR FINAL INSPECTION/APPROVAL.
- 31. NOTIFY SUNSHINE UTILITIES 48 HOURS IN ADVANCE PRIOR TO DIGGING WITHIN R/W; 1-800-432-4770.
- 32. ALL ASPECTS OF THE STORMWATER/DRAINAGE COMPONENTS AND/OR TRANSPORTATION COMPONENTS SHALL BE COMPLETED PRIOR TO REQUESTING A FINAL INSPECTION.
- 33. NO DEVIATIONS OR REVISIONS FROM THESE PLANS BY THE CONTRACTOR SHALL BE ALLOWED WITHOUT PRIOR WRITTEN APPROVAL FROM BOTH THE DESIGN ENGINEER AND ESCAMBIA COUNTY. ANY DEVIATIONS MAY RESULT IN DELAYS IN COUNTY ACCEPTANCE OF IMPROVEMENTS.

DRAINAGE NOTES:

- 1. CONSTRUCT THE STORMWATER MANAGEMENT FACILITY INCLUDING INLET STRUCTURE, FILTER SYSTEM (TEMP. OR FINAL), AND OUTFALL SYSTEM AND STABILIZE WITH SOD. DO NOT CLEAR ANY OTHER AREAS OF THE SITE UNTIL POND
- 2. CLEAR THE REMAINING PORTION OF THE SITE AND CREATE DIVERSION CHANNELS TO DIRECT STORMWATER FLOW TO THE POND. WHERE NEEDED, CHECK DAMS CONSTRUCTED OF HAY BALES, DAMS SHALL BE USED TO TRAP SEDIMENT BEFORE IT REACHES THE POND.
- 3. ENDWALL DIMENSIONS, LOCATIONS AND POSITIONS ARE FOR ROUND AND ELLIPTICAL CONCRETE PIPE AND FOR ROUND AND PIPE -ARCH CORRUGATED METAL PIPE. ROUND CONCRETE PIPE SHOWN.
- 4. FRONT SLOPE AND DITCH TRANSITIONS SHALL BE IN ACCORDANCE WITH FDOT INDEX NO. 280.
- 5. ENDWALLS MAY BE CAST IN PLACE OR PRECAST CONCRETE. REINFORCING STEEL SHALL BE GRADES 40 OR 60. ADDITIONAL REINFORCEMENT NECESSARY FOR HANDLING PRECAST UNITS SHALL BE DETERMINED BY THE CONTRACTOR OR THE SUPPLIER. COST OF REINFORCEMENT SHALL BE INCLUDED IN THE CONTRACT UNIT PRICE FOR CONCRETE, (ENDWALLS).
- 6. ALL EXPOSED CORNERS AND EDGES OF CONCRETE ARE TO BE CHAMFERED 3/4".
- 7. CONSTRUCTION OF THE ROADWAY AND DRAINAGE SYSTEMS SHALL CONFORM TO THE MOST RECENT FDOT ROAD AND BRIDGE MANUAL AND SUPPLEMENTS.
- 8. CONCRETE MEETING THE REQUIREMENTS OF ASTM C-478 (4000 PSI) MAY BE USED IN LIEU OF CLASS 1 CONCRETE IN PRECAST ITEMS MANUFACTURED IN PLANTS WHICH ARE UNDER THE STANDARD OPERATING PROCEDURES FOR THE INSPECTION OF PRECAST DRAINAGE PRODUCTS.
- 9. ON OUTFALL DITCHES WITH SIDE SLOPES FLATTER THAN 11/2": 1, PROVIDE 20' TRANSITIONS FROM THE ENDWALL TO THE FLATTER SIDE SLOPES, RIGHT OF WAY PERMITTING.
- 10. FOR SODDING AROUND ENDWALLS SEE INDEX NO. 281.
- 11. PIPE LENGTH PLAN QUANTITIES SHALL BE BASED ON THE PIPE END LOCATIONS SHOWN IN THE STANDARD LOCATION CONTROL END VIEW, OR LENGTHS BASED ON SPECIAL ENDWALL LOCATIONS CALLED FOR IN THE PLANS.

CONSTRUCTION SEQUENCE:

- 1. THE FOLLOWING SEQUENCE OF CONSTRUCTION SHALL BE FOLLOWED:
- A) CONSTRUCT TREE PROTECTION BARRICADES AND SEDIMENTATION/EROSION CONTRILS AND CLEARLY FLAG THE LIMITS OF CONSTUCTION. DO NOT BEGIN CONSTRUCTION UNTIL EROSION CONTROL DEVICES HAVE BEEN INSPECTED AND APPROVED BY THE LOCAL PERMITTING AUTHORITY.
- BEEN INSPECTED AND APPROVED BY THE LOCAL PERMITTING AUTHORITY.

 B) CONSTRUCT ALL STORMWATER MANAGEMENT FACILITIES. DO NOT CLEAR ANY OTHER AREAS OF THE SITE UNTIL THE POND/SWALE IS STABILIZED.
- C) CLEAR THE REMAINING PORTION OF THE SITE AND CREATE DIVISION BERMS OR CHANNELS TO DIRECT RUNOFF TO THE STORMWATER FACILITES WHERE NEEDED, CHECK DAMS CONSISTING OF HAY BALES OR OTHER MATERIALS SHALL BE USED TO TRAP ANY SEDIMENTS BEFORE THEY REACH THE POND/SWALE.
- D) CONSTRUCT UTILITIES AND OTHER IMPROVEMENTS IN ACCORDANCE WITH THE APPROVED DRAWINGS.

 E) SEED/SOD AND LANDSCAPE IN ACCORDANCE WITH THE APPROVED DRAWINGS.
- F) OBTAIN A STORMWATER OPERATION AND MAINTENANCE PERMIT. RECORD DRAWINGS SHALL BE FILED WITH THE LOCAL PERMITTING AUTHORITY.

LAYOUT NOTES:

- 1. THE ELEVATIONS AS SHOWN HEREON ARE REFERENCED TO NATIONAL GEODETIC VERTICAL DATUM.
- 2. IT IS THE CONTRACTORS RESPONSIBILITY TO DETERMINE THE EXACT LOCATION OF EXISTING UTILITIES AND TO DETERMINE IF OTHER UTILITIES WILL BE ENCOUNTERED DURING THE COURSE OF THE WORK AND TAKE ALL NECESSARY STEPS TO PROVIDE FOR UTILITY PROTECTION.
- REFERENCE BENCHMARKS EXISTS ON THIS PROPERTY AS SHOWN HEREON.
- 4. THE CONTRACTOR SHALL BE RESPONSIBLE FOR THE FINAL LAYOUT AND ALIGNMENT OF ALL BUILDINGS, DRIVEWAYS, PARKING AREAS, ROADS AND OTHER FACILITIES. CONTRACTOR SHALL CONTACT THE ENGINEER IMMEDIATELY UPON ANY APPARENT CONFLICTS, AND PRIOR TO CONSTRUCTING SAID IMPROVEMENTS.
- 5. CONTRACTOR SHALL CONTACT THE ENGINEER IMMEDIATELY REGARDING ANY APPARENT CONFLICTS IN THE PROPOSED IMPROVEMENTS ENCOUNTERED DURING THE COURSE OF CONSTRUCTION.

EARTHWORK NOTE:

1. NO REPRESENTATION IS MADE REGARDING A BALANCED SITE. THE CONTRACTOR SHALL DETERMINE IF ANY ADDITIONAL FILL IS REQUIRED AND PROVIDE SAME AT NO ADDITIONAL COST TO THE OWNER. LIKEWISE, ANY EXCESS MATERIAL SHALL BE HAULED FROM THE SITE AND PROPERLY DISPOSED OF AT NO ADDITIONAL COST.

LAND DISTURBANCE NOTE:

ALL LAND SHALL REMAIN IN ITS CURRENTLY MAINTAINED OR NATURAL, VEGETATED STATE WHERE APPLICABLE, UNTIL SUCH TIME ASPROPER PERMITTING AND APPROVALS FOR FUTURE SITE "DEVELOPMENT" ARE GRANTED BY ESCAMBIA COUNTY AND OTHERJURISDICTIONAL AGENCIES. PER ESCAMBIA COUNTY'S LAND DEVELOPMENT CODE, ONCE APPROVED, THE CONSTRUCTION PLANSPHASE ALLOWS THE CONSTRUCTION OF THE SUBDIVISION INFRASTRUCTURE TO PROCEED, BUT IT DOES NOT ALLOW DEVELOPMENT ONTHE INDIVIDUAL SUBDIVISION LOTS. REMOVAL OF PROTECTED TREES, LAND CLEARING ACTIVITIES, PLACEMENT OF FILL MATERIALS, TRENCHING, EXCAVATION, GRADING, ALTERATION OF LAND TOPOGRAPHY OR VEGETATIVE COVER OR ANY OTHER "LAND DISTURBANCEACTIVITIES" OUTSIDE APPROVED INFRASTRUCTURE AREAS WILL REQUIRE ADDITIONAL APPROVALS IN THE FUTURE. TREE REMOVAL ONRESIDENTIAL LOTS & OTHER NON-INFRASTRUCTURE AREAS PRIOR TO CONSTRUCTION OF DWELLING SHALL ONLY BE ALLOWED AFTER COUNTYISSUANCE OF A BUILDING PERMIT FOR THE DWELLING OR A SEPARATE TREE REMOVAL PERMIT. PLEASE CONTACT ESCAMBIA COUNTYFOR GUIDANCE PRIOR TO ANY FUTURE SITE DEVELOPMENT WORK ACTIVITIES.

UTILITY NOTES:

- THE LOCATION SHOWN FOR EXISTING UNDERGROUND UTILITIES IS APPROXIMATE. THE CONTRACTOR SHALL DETERMINE THE
 EXACT LOCATION OF ALL EXISTING UTILITIES BEFORE COMMENCING WORK IN EACH AREA. THE CONTRACTOR AGREES TO BE
 COMPLETELY RESPONSIBLE FOR ALL DAMAGES WHICH MIGHT OCCUR BY HIS/HER FAILURE TO EXACTLY LOCATE AND
 PRESERVE ALL UTILITIES.
- 2. UTILITY OWNERS SHALL BE NOTIFIED AT LEAST 48 HOURS PRIOR TO ANY CONSTRUCTION SO THAT THE UTILITY OWNER CAN SPOT VERIFY AND/OR EXPOSE THEIR UTILITIES.
- KNOWN UTILITIES OWNERS INCLUDE:

PH: (850) 619-6094

SANITARY SEWER AND WATER - ECUA MR. BLAINE BECK 9255 STURDEVANT ST. PENSACOLA, FL. 32514

NATURAL GAS - PENSACOLA ENERGY MRS. DIANE MOORE 1625 ATWOOD DRIVE PENSACOLA, FL. 32514

PH: (850) 474-5319

TELEPHONE - AT&T FLORIDA

MR. STEVE KENNINGTON 6689 MAGNOLIA STREET MILTON, FL. 32570 PH: (850) 812-4848

PH: (850) 595-3404

TRAFFIC DEPARTMENT - ESCAMBIA COUNTY PUBLIC WORKS MR. JOHNNY COX 3363 WEST PARK PLACE PENSACOLA, FL. 32505

- 3. AT&T FLORIDA WILL COMPLETE ALL WORK DURING THE HOURS OF 7:30 AM 4:30 PM, MONDAY THRU FRIDAY. NO NIGHT OR
- 4. ALL CABLE DAMAGE MUST BE REPORTED TO THE AT&T FLORIDA REPAIR SERVICE DEPARTMENT AT 611 FROM A LAND LINE OR 877-737-2478 IF USING A CELL PHONE.
- 5. CONTRACTOR IS TO USE CAUTION WHEN WORKING IN OR AROUND AREAS OF OVERHEAD TRANSMISSION LINES AND
- 6. UTILITIES ARE TO REMAIN AND BE PROTECTED DURING CONSTRUCTION. NECESSARY REPAIRS SHALL BE CONSIDERED INCIDENTAL TO OTHER PAY ITEMS AND SHALL BE TO THE SATISFACTION OF THE UTILITY OWNERS.
- 7. WORK PROPOSED NEXT TO THE R/W WITH EXISTING SWALES MAY REQUIRE ADDITIONAL PROVISIONS TO REPAIR/RESTORE EXISTING DRAINAGE SWALES AS NEEDED TO ENSURE ADEQUATE DRAINAGE. R/W SHOULDER STABILIZATION SHOULD BE IN
- ACCORDANCE WITH FDOT STANDARD SPECIFICATIONS FOR ROAD AND BRIDGE CONSTRUCTION LATEST EDITION.

 8. ALL PROPOSED UNDERGROUND UTILITIES WITHIN R/W'S OR UTILITY CONDUIT FOR ROAD CROSSINGS SHALL BE INSTALLED PRIOR TO PAVING. NO STREETS OR ROADS UNDER THE TWO (2) YEAR WARRANTY WILL BE ALLOWED TO BE OPEN-CUT, OR JACK-AND-BORED. TO ACCOMPLISH THIS REQUIREMENT, COMMON TRENCHING IS REQUIRED WHENEVER POSSIBLE. IF COMMON TRENCHING IS NOT A FEASIBLE OPTION, THE DEVELOPER SHALL INSTALL CONDUIT FOR THE UTILITY NOT PARTICIPATING IN THE COMMON TRENCHING FOR ALL ROAD CROSSINGS AND THE UTILITY COMPANY WILL BE REQUIRED TO
- USE THE CONDUIT. THIS SHALL REQUIRE PLANNING BETWEEN THE DEVELOPER AND THE UTILITY.

 9. ROUGH GRADE OF RIGHT-OF-WAY MUST BE ESTABLISHED PRIOR TO COMMON TRENCH UTILITY INSTALLATION TO ENSURE UTILITIES ARE INSTALLED AT PROPER DEPTHS. THIS NOTE SHOULD ALSO INDICATE A MINIMUM 30° OF COVER IS REQUIRED OVER ALL UTILITIES. THIS DIMENSION SHALL BE MEASURED FROM PROPOSED GRADE IF ROAD IS IN FILL AND MEASURED FROM TOP OF CURB IF ROAD IS IN CUT.
- 10. THE CONTRACTOR SHALL NOTIFY THE ENGINEER OF RECORD AT LEAST TWO WEEKS PRIOR TO PLACEMENT OF BASE MATERIAL TO ASSIST IN THE COORDINATION OF ALL OTHER UNDERGROUND UTILITIES.
- 11. ELECTRIC/PHONE/CABLE/GAS STRUCTURES INSTALLED WITHIN DRAINAGE ACCESS EASEMENTS SHALL BE LOCATED ALONG THE BOUNDARY OF THE EASEMENT TO MAXIMIZE CLEAR ACCESS FOR MAINTENANCE EQUIPMENT.

EROSION NOTES:

- 1. EROSION PROTECTION: SOIL EROSION SEDIMENTATION MUST BE CONTROLLED AND RETAINED ON SITE DURING CONSTRUCTION. THEREFORE, EROSION PROTECTION, SUCH AS STAKED BALED HAY AND SILT FENCE BARRIERS, MUST BE INSTALLED PRIOR TO START OF CONSTRUCTION.
- 2. SILT FENCE BARRIER SHALL BE INSTALLED AS SHOWN ON PLANS, AND IN ALL AREAS SUBJECT TO SOIL EROSION SEDIMENTATION.
- 3. POND SLOPES SHALL BE SODDED.
- 4. GRADES AT CURBS ARE AT FLOWLINE.
- 5. EROSION CONTROL MATTING SHALL BE BONTERRA CF9 OR EQUAL APPROVED BY THE ENGINEER. INLET FILTER SYSTEMS SHALL BE SILT-SAVER, INC. OR EQUAL APPROVED BY THE ENGINEER.
- 6. CONTRACTOR SHALL RETAIN ALL SOIL EROSION SEDIMENTATION ON-SITE. (BUT NOT IN THE WETLANDS)
- 7. ALL DISTURBED AREAS NOT SPECIFICALLY SHOWN TO BE SODDED SHALL BE GRASSED AND MULCHED. THE GRASS SEED SHALL BE 20 PARTS BERMUDA AND 80 PARTS PENSACOLA BAHIA. APPLICATION SHALL BE 100 POUNDS PER ACRE. IF CONSTRUCTION OCCURS DURING THE MONTHS OF OCTOBER THROUGH JANUARY, SEEDING SHALL BE 50 PARTS WINTER RYE AND 50 PARTS PENSACOLA BAHIA AT 100 POUNDS PER ACRE. SEEDED AREAS SHALL BE FERTILIZED WITH 8-8-8 NPK DRY FERTILIZER AT THE RATE OF 800 POUNDS PER ACRE.
- 8. ALL AREAS TO BE GRASSED AND MULCHED SHALL HAVE A MINIMUM OF ONE INCH OF TOPSOIL DISTRIBUTED PRIOR TO SEEDING.
- 9. FUNCTIONAL EROSION AND SILTATION CONTROLS SHALL BE INSTALLED AS NEEDED THROUGHOUT THE CLEARED AREAS AND AS SHOWN ON THE CONSTRUCTION PLANS IMMEDIATELY SUBSEQUENT TO ESTABLISHED ROUGH GRADE.
- 10. ALL EROSION CONTROL STRUCTURES SHALL BE IN PLACE BEFORE DEMOLITION BEGINS.
- 11. CONSTRUCT FILTER FENCES, HAY BALES AND TREE BARRICADES.
- 12. STRIP THE TOP SOIL AND STOCK PILE FOR USE IN LANDSCAPED AREAS.
- 13. STABILIZE CONSTRUCTION DRIVEWAYS WITH GRAVEL AS REQUIRED TO PREVENT SILT FROM LEAVING THE SITE.
- 14. INSTALL UTILITIES AND DRAINAGE PIPES PROTECTING INLETS w/STAKED HAY BALES OR FILTER FENCE TO PREVENT EROSION FORM ENTERING THE DRAINAGE SYSTEMS. CONSTRUCT STORMWATER MANAGEMENT CONTROL STRUCTURES. (FILTRATION, RATE CONTROL, ETC.)
- 15. CONSTRUCT BUILDINGS, PARKING AND OTHER IMPROVEMENTS AS SHOWN ON THE PLANS; MAINTAIN SEDIMENTATION, EROSION AND TREE PROTECTION MEASURES.
- 16. FINAL GRADE THE SITE AND LANDSCAPE AS PER PLANS AND SPECIFICATIONS, STABILIZING ALL DISTURBED AREAS.
- 17. USE RAIL FENCE AROUND PROTECTED TREES.
- 18. NO HEAVY EQUIPMENT IN NATURAL AREAS, ALL PLANTING TO BE DONE BY HAND.
- 19. ALL DISTURBED AREAS SHALL BE SATISFACTORILY STABILIZED. UNLESS OTHERWISE SPECIFIED, SOD SHALL BE PROVIDED IN THE FOLLOWING AREAS:
- A) ALL SLOPES 3:1 AND STEEPER.
- B) ENTIRE AREA BETWEEN SIDEWALKS AND BACK OF ROAD CURB.

 (1) INTERIOR SLOPES OF PONDS AND SWALES AND IN A THREE-FOOT WALLS.
- C) INTERIOR SLOPES OF PONDS AND SWALES, AND IN A THREE-FOOT WIDE STRIP ALONG THE TOP-OF BANK OF ALL PONDS AND SWALES.D) IN A TWO-FEET WIDE STRIP ALONG ALL BUILDINGS, STRUCTURES, ROADS WHERE NO SIDEWALKS RUN PARALLEL, AND OUTER EDGES OF ALL SIDEWALKS. OTHER AREAS MAY BE SEEDED AND MULCH,
- UNLESS OTHERWISE SPECIFIED. CONTRACTOR SHALL MAINTAIN GRASSED AREAS UNTIL PLANTS HAVE TAKEN ROOT AND THE AREA IS SATISFACTORILY STABILIZED.

 E) CONSTRUCTION ENTRANCE TO BE CONSTRUCTED OF 6 INCHES (MIN.) #57 STONE TO PREVENT TRACKING ONTO STREETS.
- 20. THE DEVELOPER/CONTRACTOR SHALL INSTALL PRIOR TO THE START OF CONSTRUCTION AND MAINTAIN DURING CONSTRUCTION ALL SEDIMENT CONTROL MEASURES AS REQUIRED TO RETAIN ALL SEDIMENTS ON THE SITE. IMPROPER SEDIMENT CONTROL MEASURES MAY RESULT IN CODE ENFORCEMENT VIOLATION.
- 21. RETENTION/DETENTION AREAS SHALL BE SUBSTANTIALLY COMPLETE PRIOR TO ANY CONSTRUCTION ACTIVITIES THAT MAY INCREASE STORMWATER RUNOFF RATES. THE CONTRACTOR SHALL CONTROL STORMWATER DURING ALL PHASES OF CONSTRUCTION AND TAKE ADEQUATE MEASURES TO PREVENT THE EXCAVATED POND FROM BLINDING DUE TO SEDIMENTS
- ENSURE CONTINUED GROWTH AFTER WINTER MONTHS. SEED IN ACCORDANCE WITH FDOT SECTION 570 AND STANDARD INDEX 105

 23. DEVELOPER/CONTRACTOR/HOMEOWNERS ASSOCIATION SHALL RESHAPE PER PLAN SPECIFICATIONS, CLEAN OUT ACCUMULATED SILT, AND STABILIZE RETENTION/DETENTION POND(S) AT THE END OF CONSTRUCTION WHEN ALL DISTURBED AREAS HAVE BEEN STABILIZED AND AT THE END OF THE 2-YEAR WARRANTY PERIOD.

22. ALL DISTURBED AREAS WHICH ARE NOT SODDED OR PAVED SHALL BE STABILIZED WITH SEEDING, FERTILIZER AND MULCH AND/OR HYDROSEED. SEEDED AREAS SHALL INCLUDE A BAHIA MIX TO

24. ON SITES > 1 ACRE, IF > 1 CONTIGUOUS ACRE IS CLEARED, A GROUND COVER SUFFICIENT TO PREVENT EROSION SHOULD BE PLANTED OR OTHERWISE STABILIZED WITHIN 10 WORKING DAYS ON THAT PORTION OF THE SITE UPON WHICH FURTHER ACTIVE CONSTRUCTION WILL NOT BE UNDERTAKEN WITHIN 90 DAYS.

26. A HEALTHY GROWTH OF GRASS WITHIN DISTURBED RIGHT-OF-WAY AREAS IS REQUIRED PRIOR TO COUNTY APPROVAL. IF TIME CONSTRAINTS EXIST DURING THE FINAL PLAT APPROVAL AND

25. TO COMPLY WITH NPDES REQUIREMENTS, ALL EROSION CONTROL MEASURES SHALL BE INSPECTED AFTER EACH 1/2" RAINFALL EVENT OR AT LEAST WEEKLY. THE CONTRACTOR SHALL DOCUMENT SUCH INSPECTIONS AND EROSION CONTROL MAINTENANCE EFFORTS; INSPECTION RECORDS SHALL BE PROVIDED TO THE NPDES PERMIT APPLICANT FOR PROPER REPORTING TO FDEP/NWFWMD.

ACCEPTANCE PROCESS, A MINIMUM OF TWO STRIPS OF SOD (MINIMUM 2' WIDE) BEHIND THE BACK OF CURB WITH ALL OTHER DISTURBED AREAS SEEDED/MULCHED/FERTILIZED WILL BE ACCEPTABLE.

27. SAG FILTERS IN CURB THROATS ARE NOT AN ALLOWABLE SEDIMENT CONTROL METHOD.

ELECTRIC - GULF POWER

MR. ALLEN THOMPSON

5120 DOGWOOD DRIVE

MILTON, FL. 32570

PH: (850) 549-1225

CABLE - COX CABLE

2421 EXECUTIVE PLAZA

PENSACOLA, FL. 32504

SUNSHINE STATE ONE-CALL

7200 LAKE ELLENOR DRIVE, SUITE

PH: (850) 857-4564

ORLANDO, FL. 32809

PH: (800) 432-4770

MR. TROY YOUNG

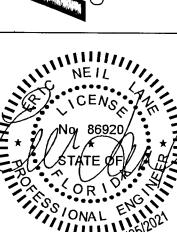
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ERIC NEIL LANE, P.E. COA# 32689 FL. PE No. 86920

Plans for Ridge Phase 1

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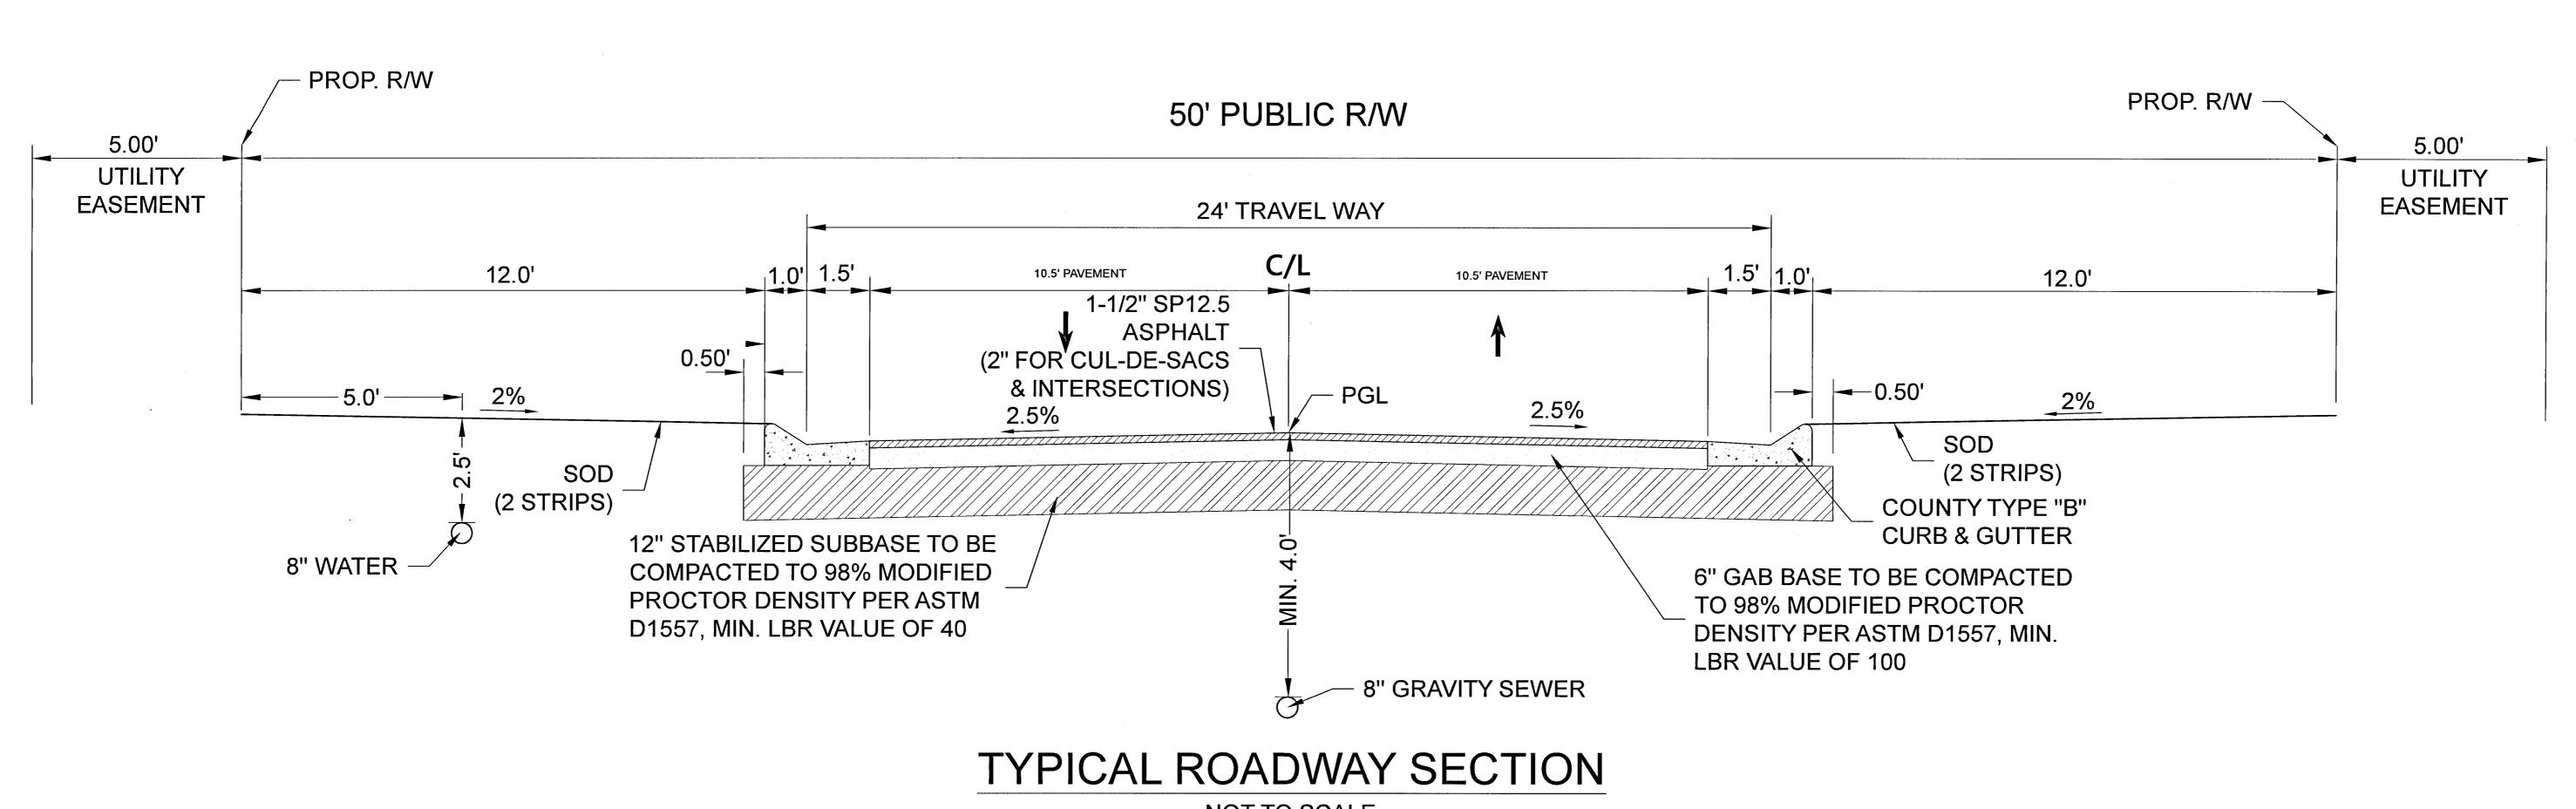
General Notes

Job No. 20-123P

Date: 2/25/2021

Drawn By: CAB

Checked By: ENL



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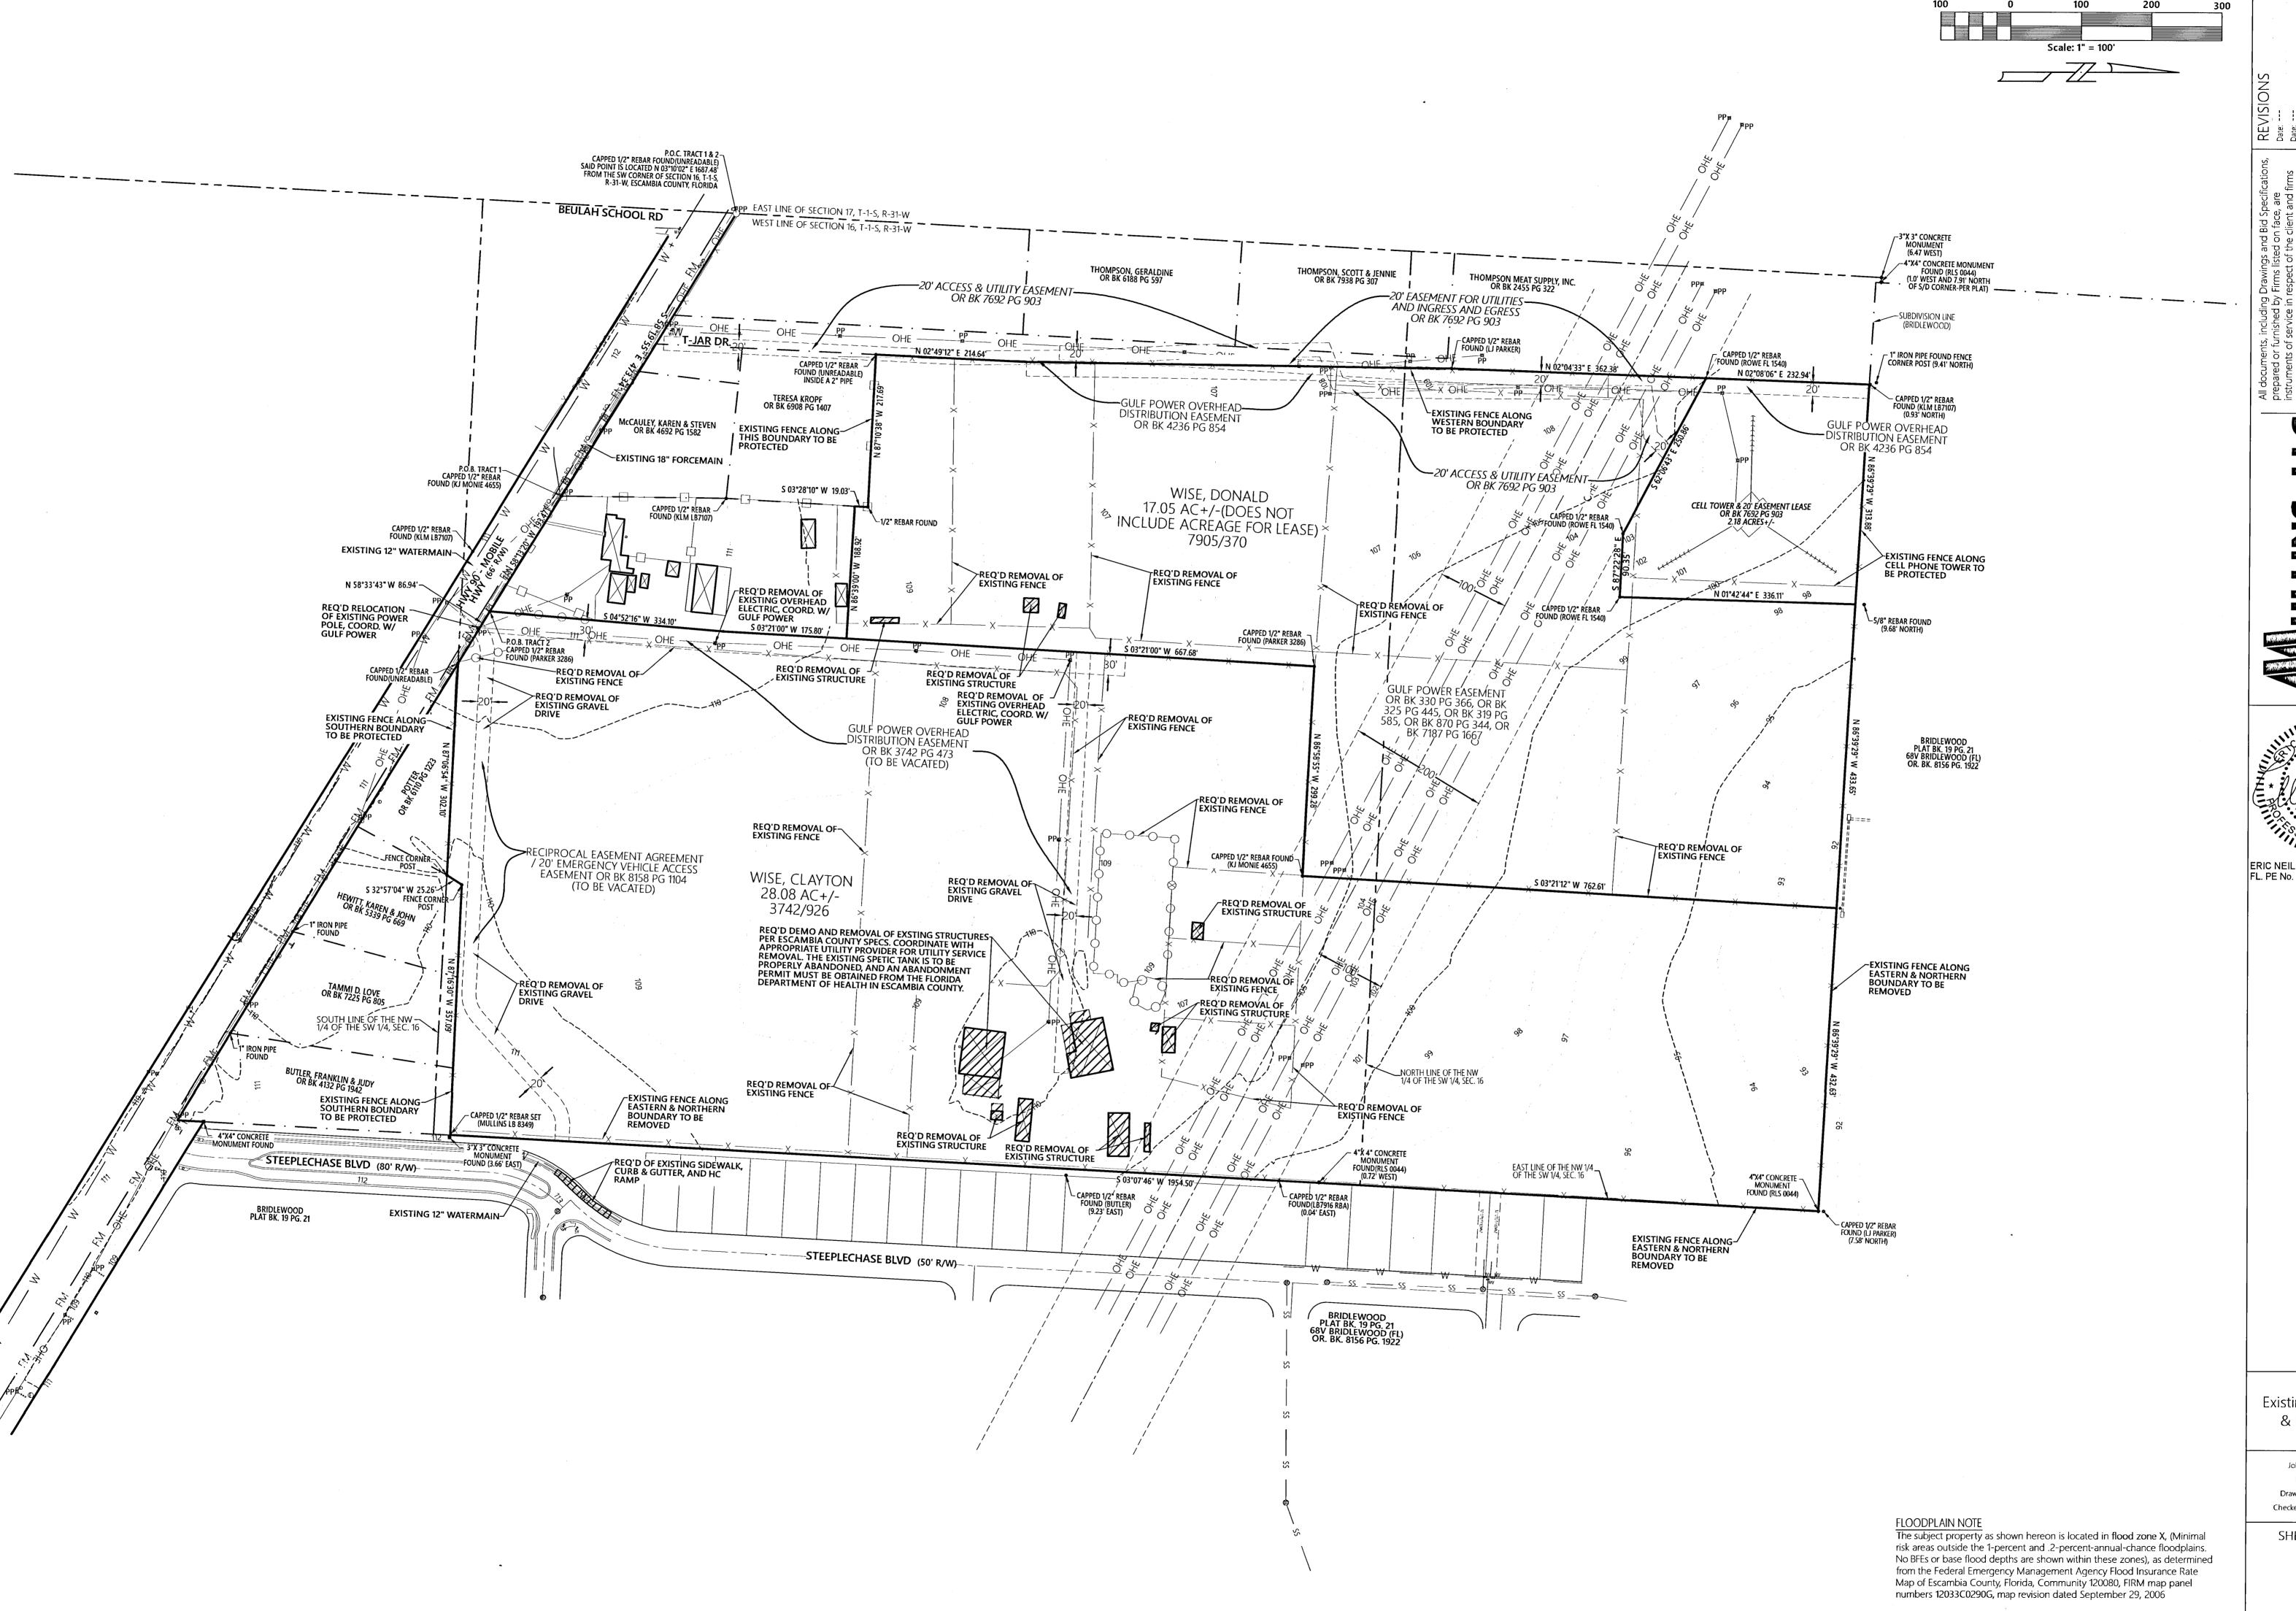
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FL. PE No. 86920

Construction Plans for Saddle Ridge Phase 1

Escambia County, FL

Typical Roadway Section

Job No. 20-123P
Date: 2/25/2021
Drawn By: CAB
Checked By: ENL



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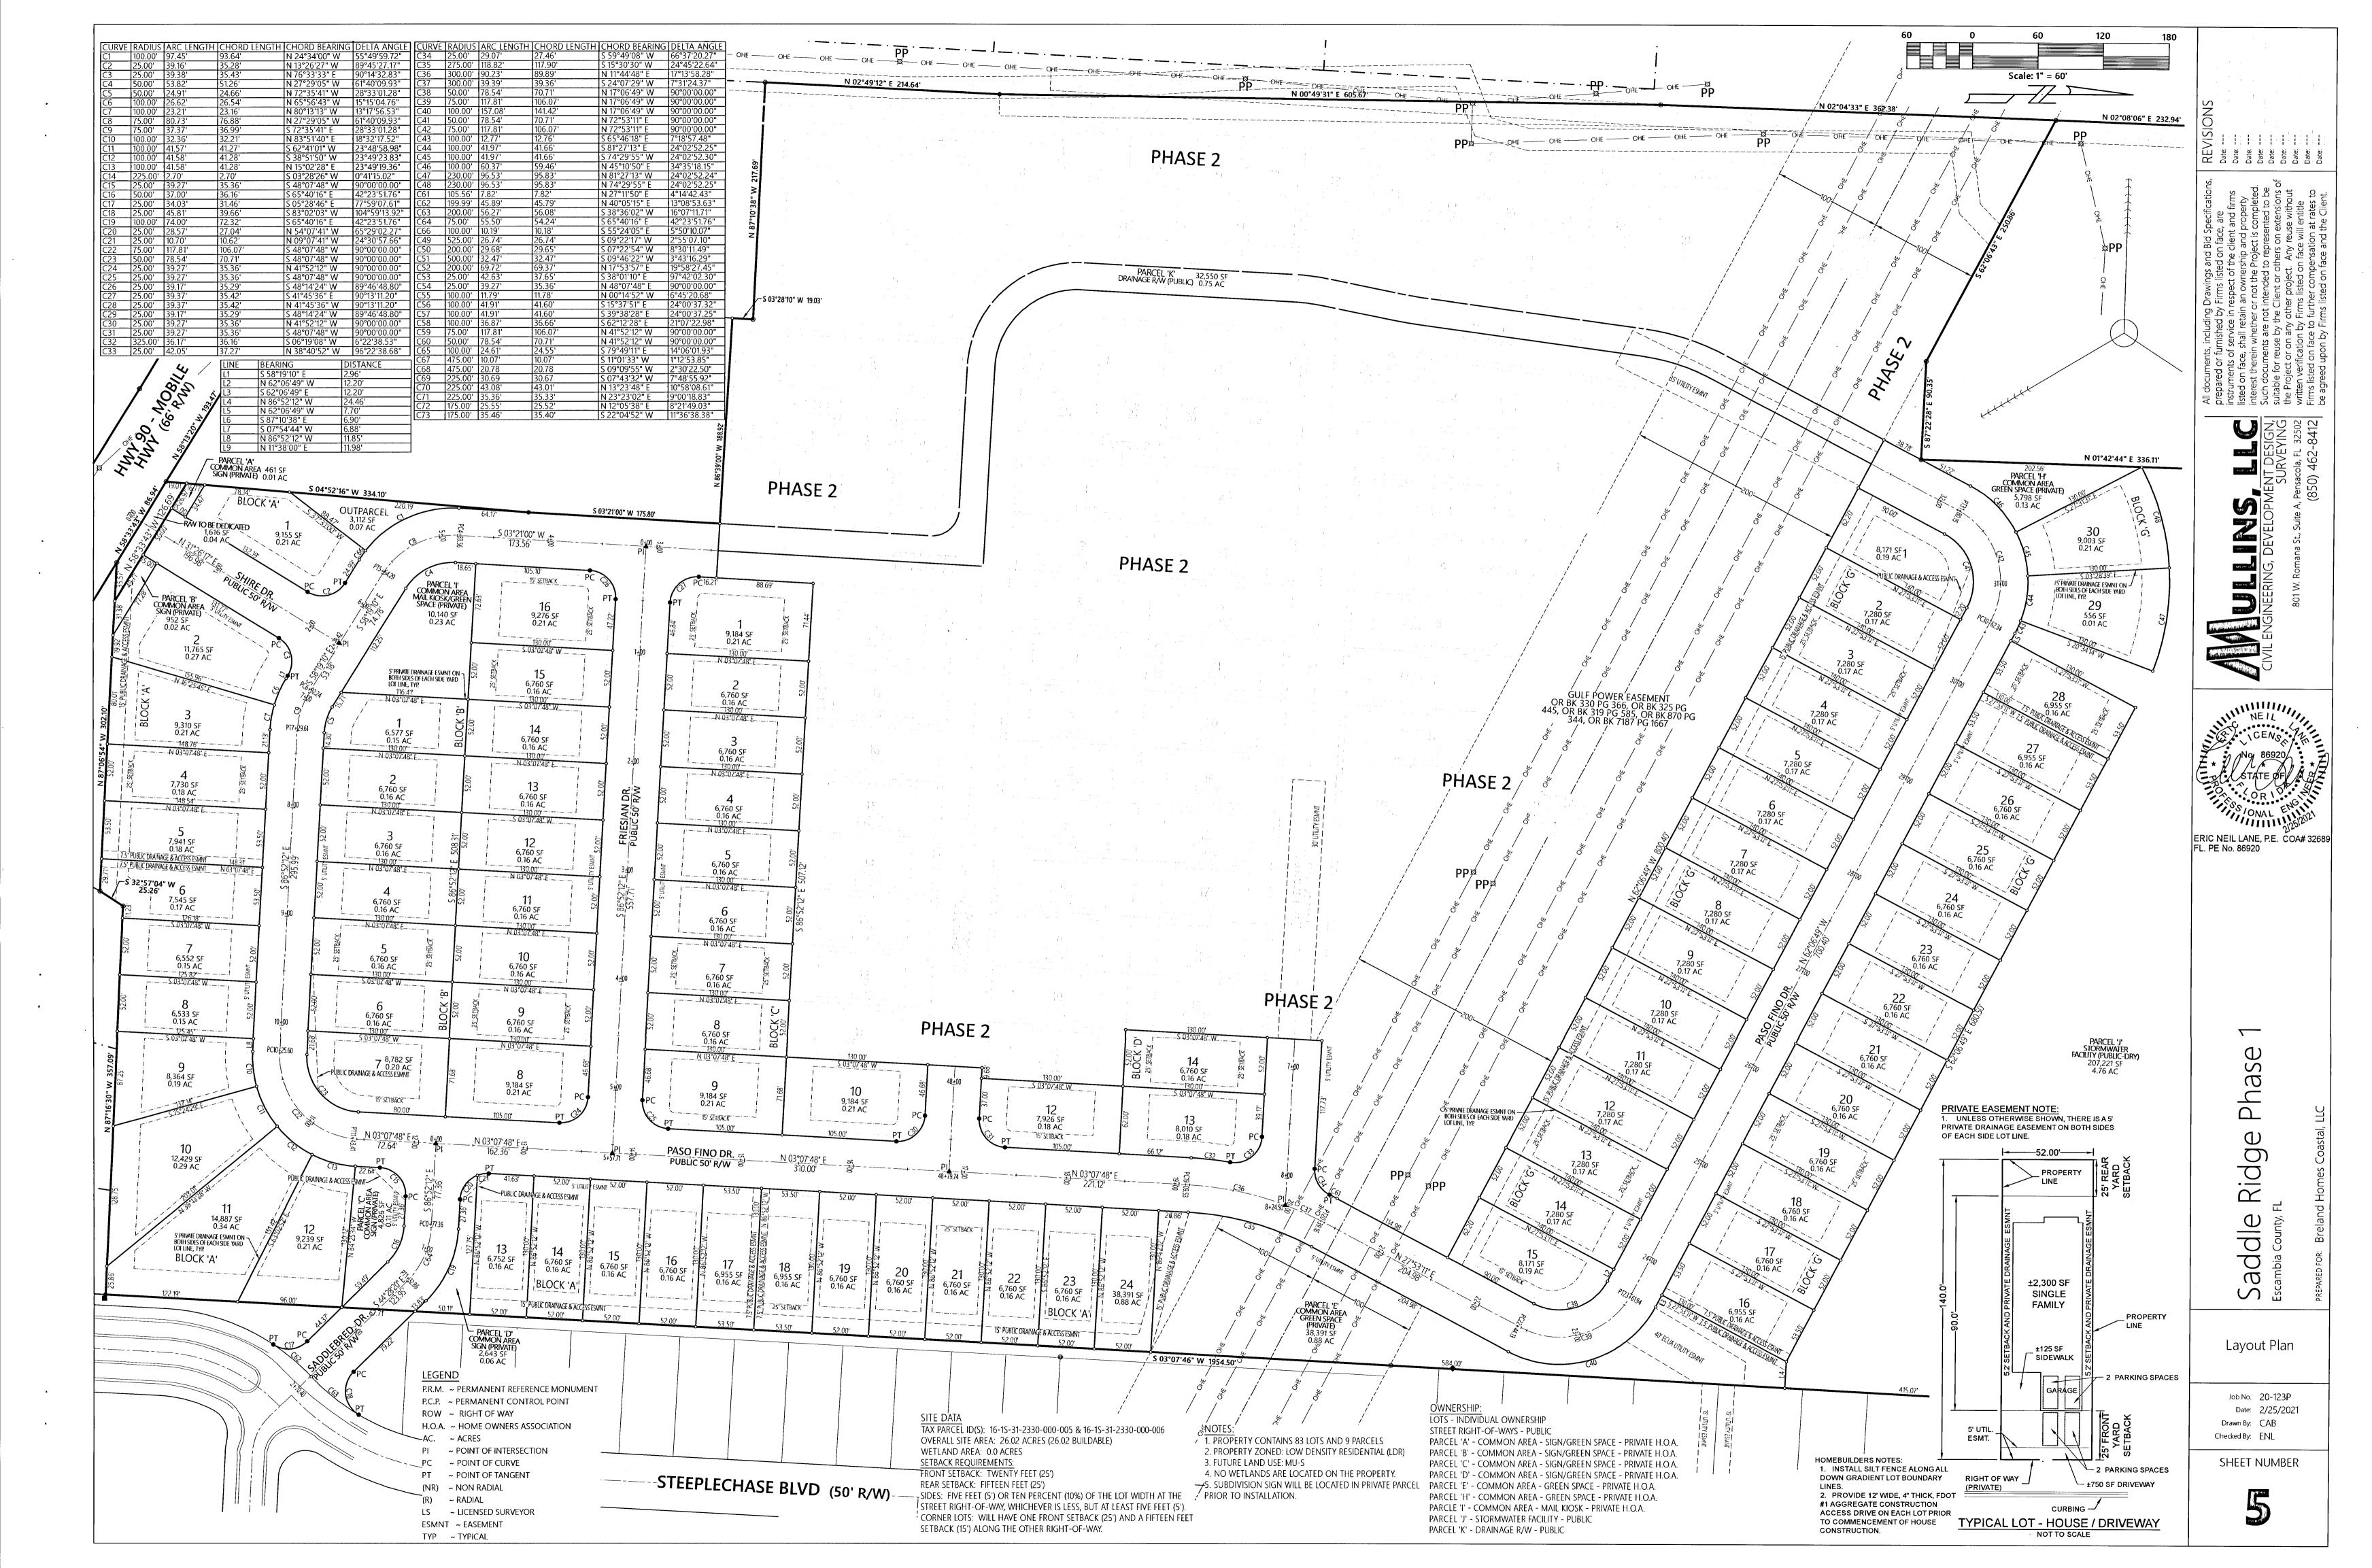
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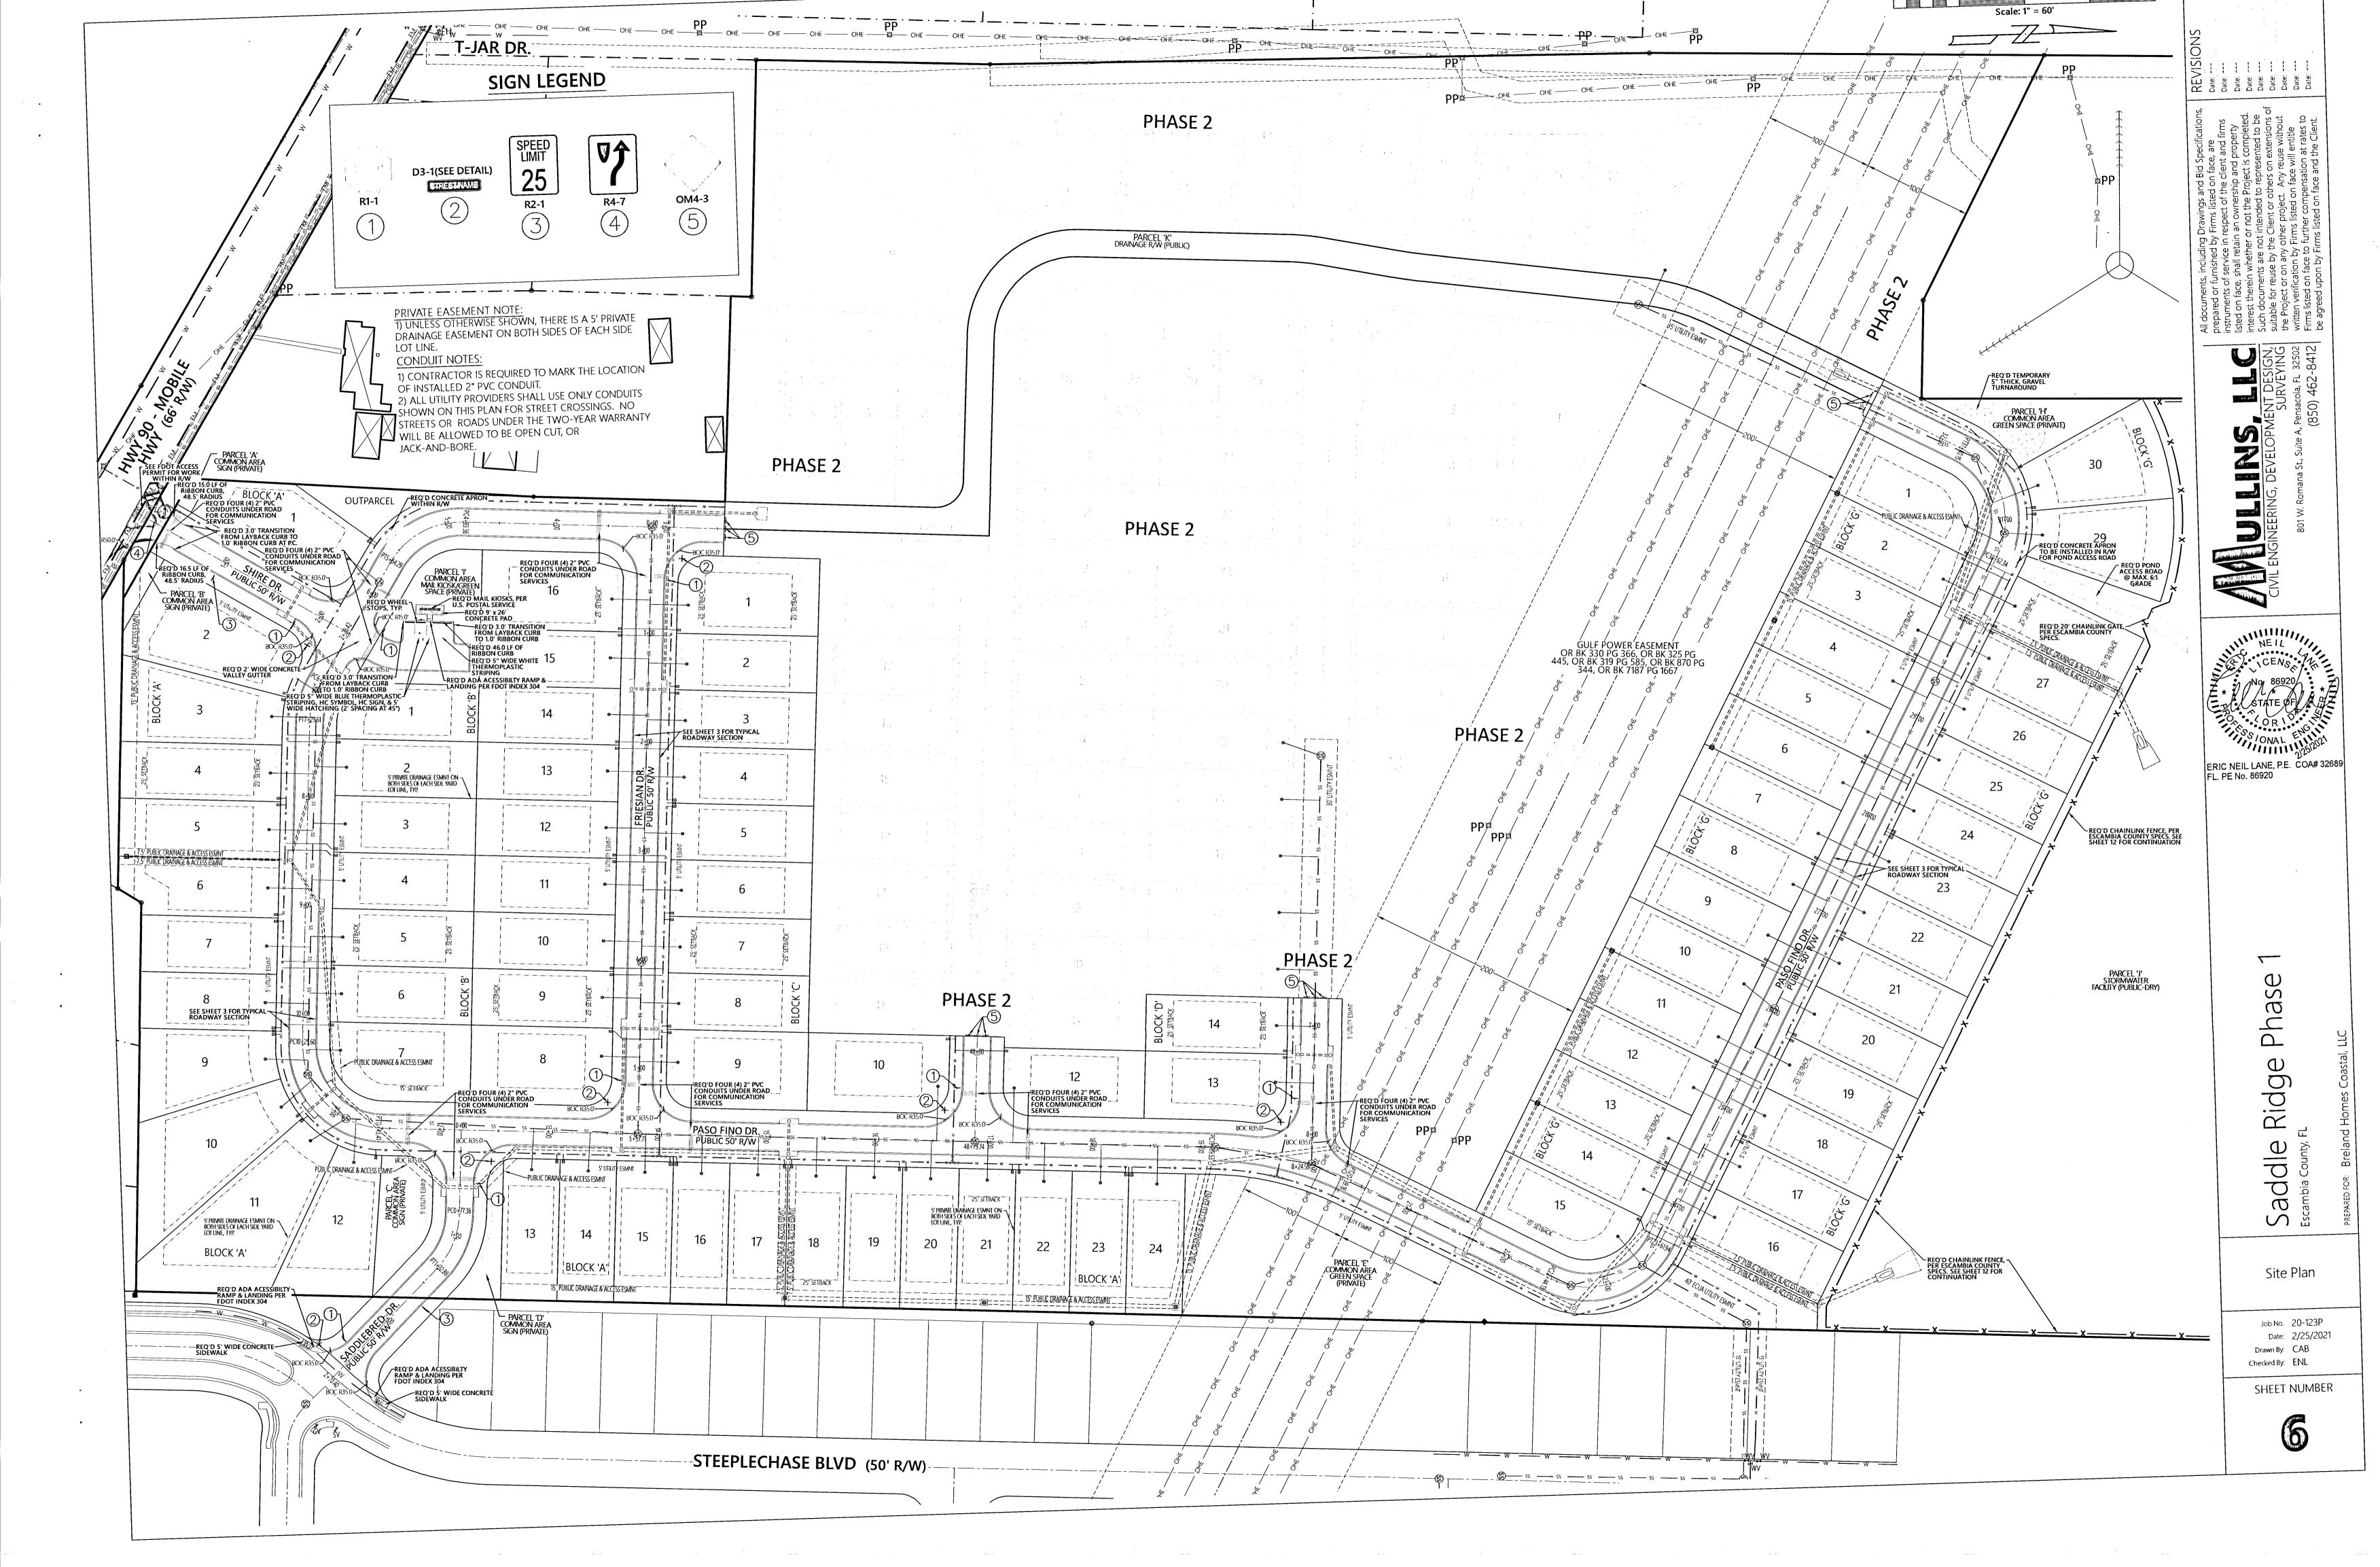
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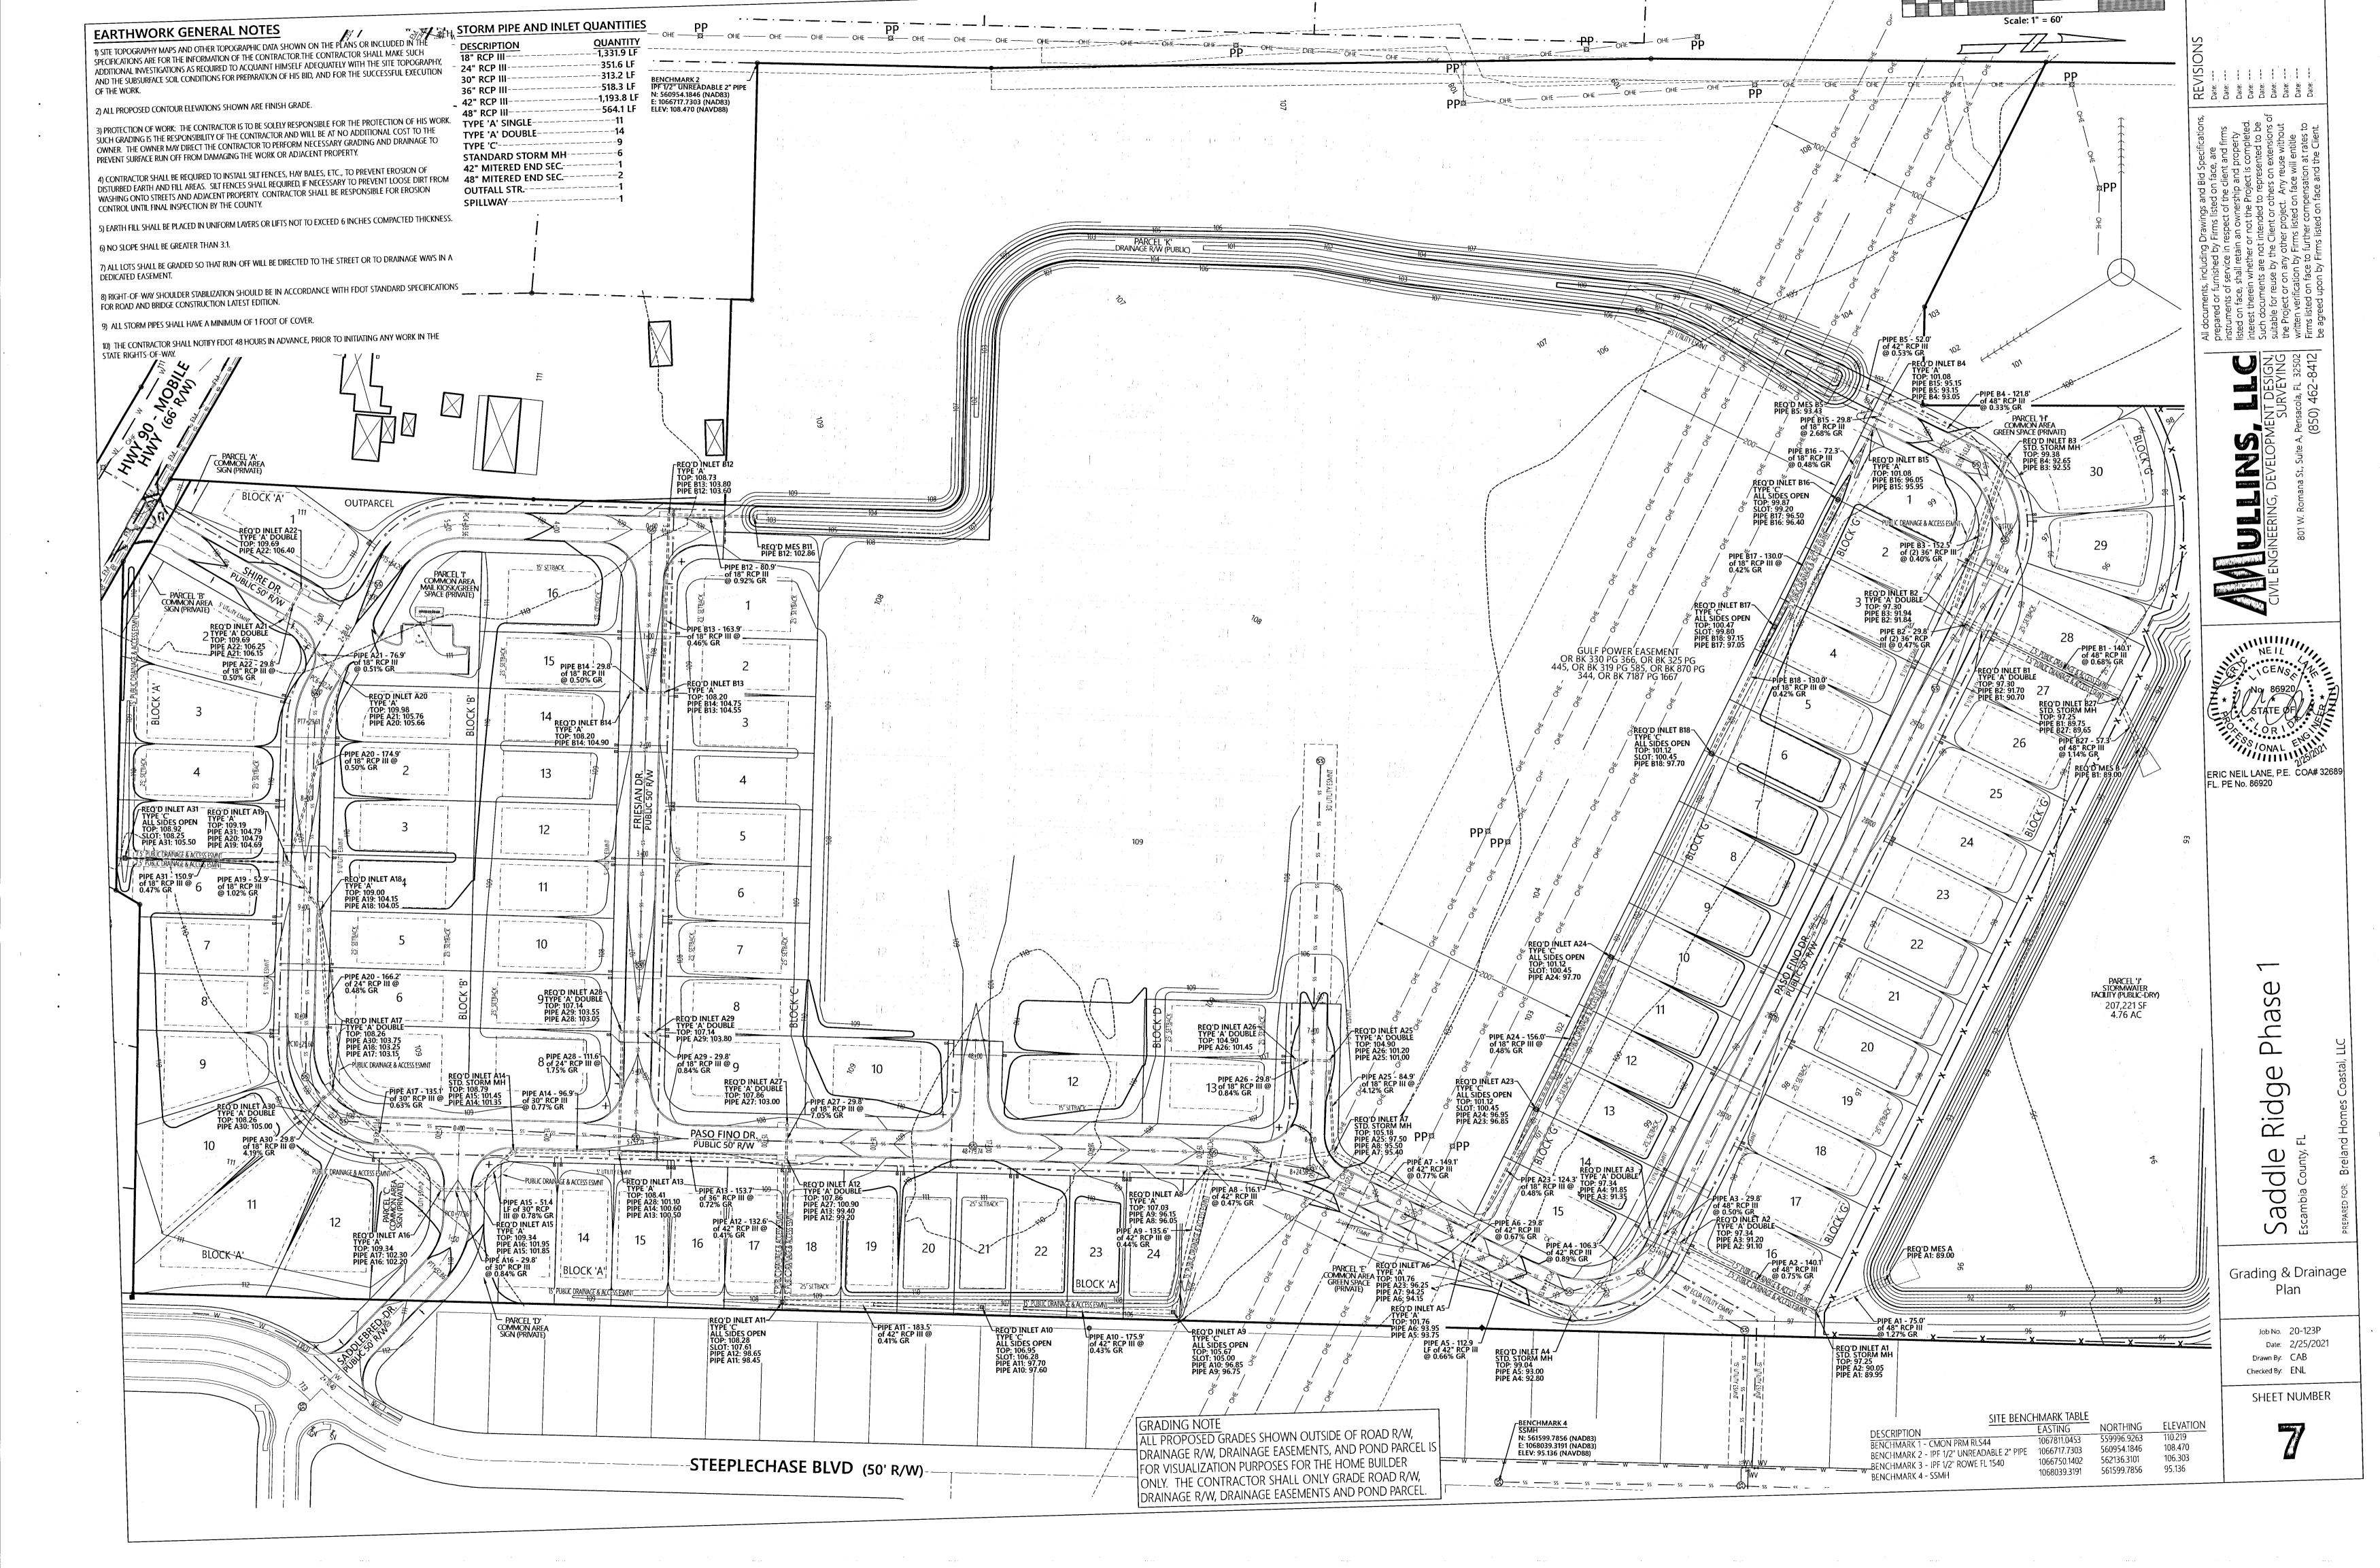
Existing Conditions & Demo Plan

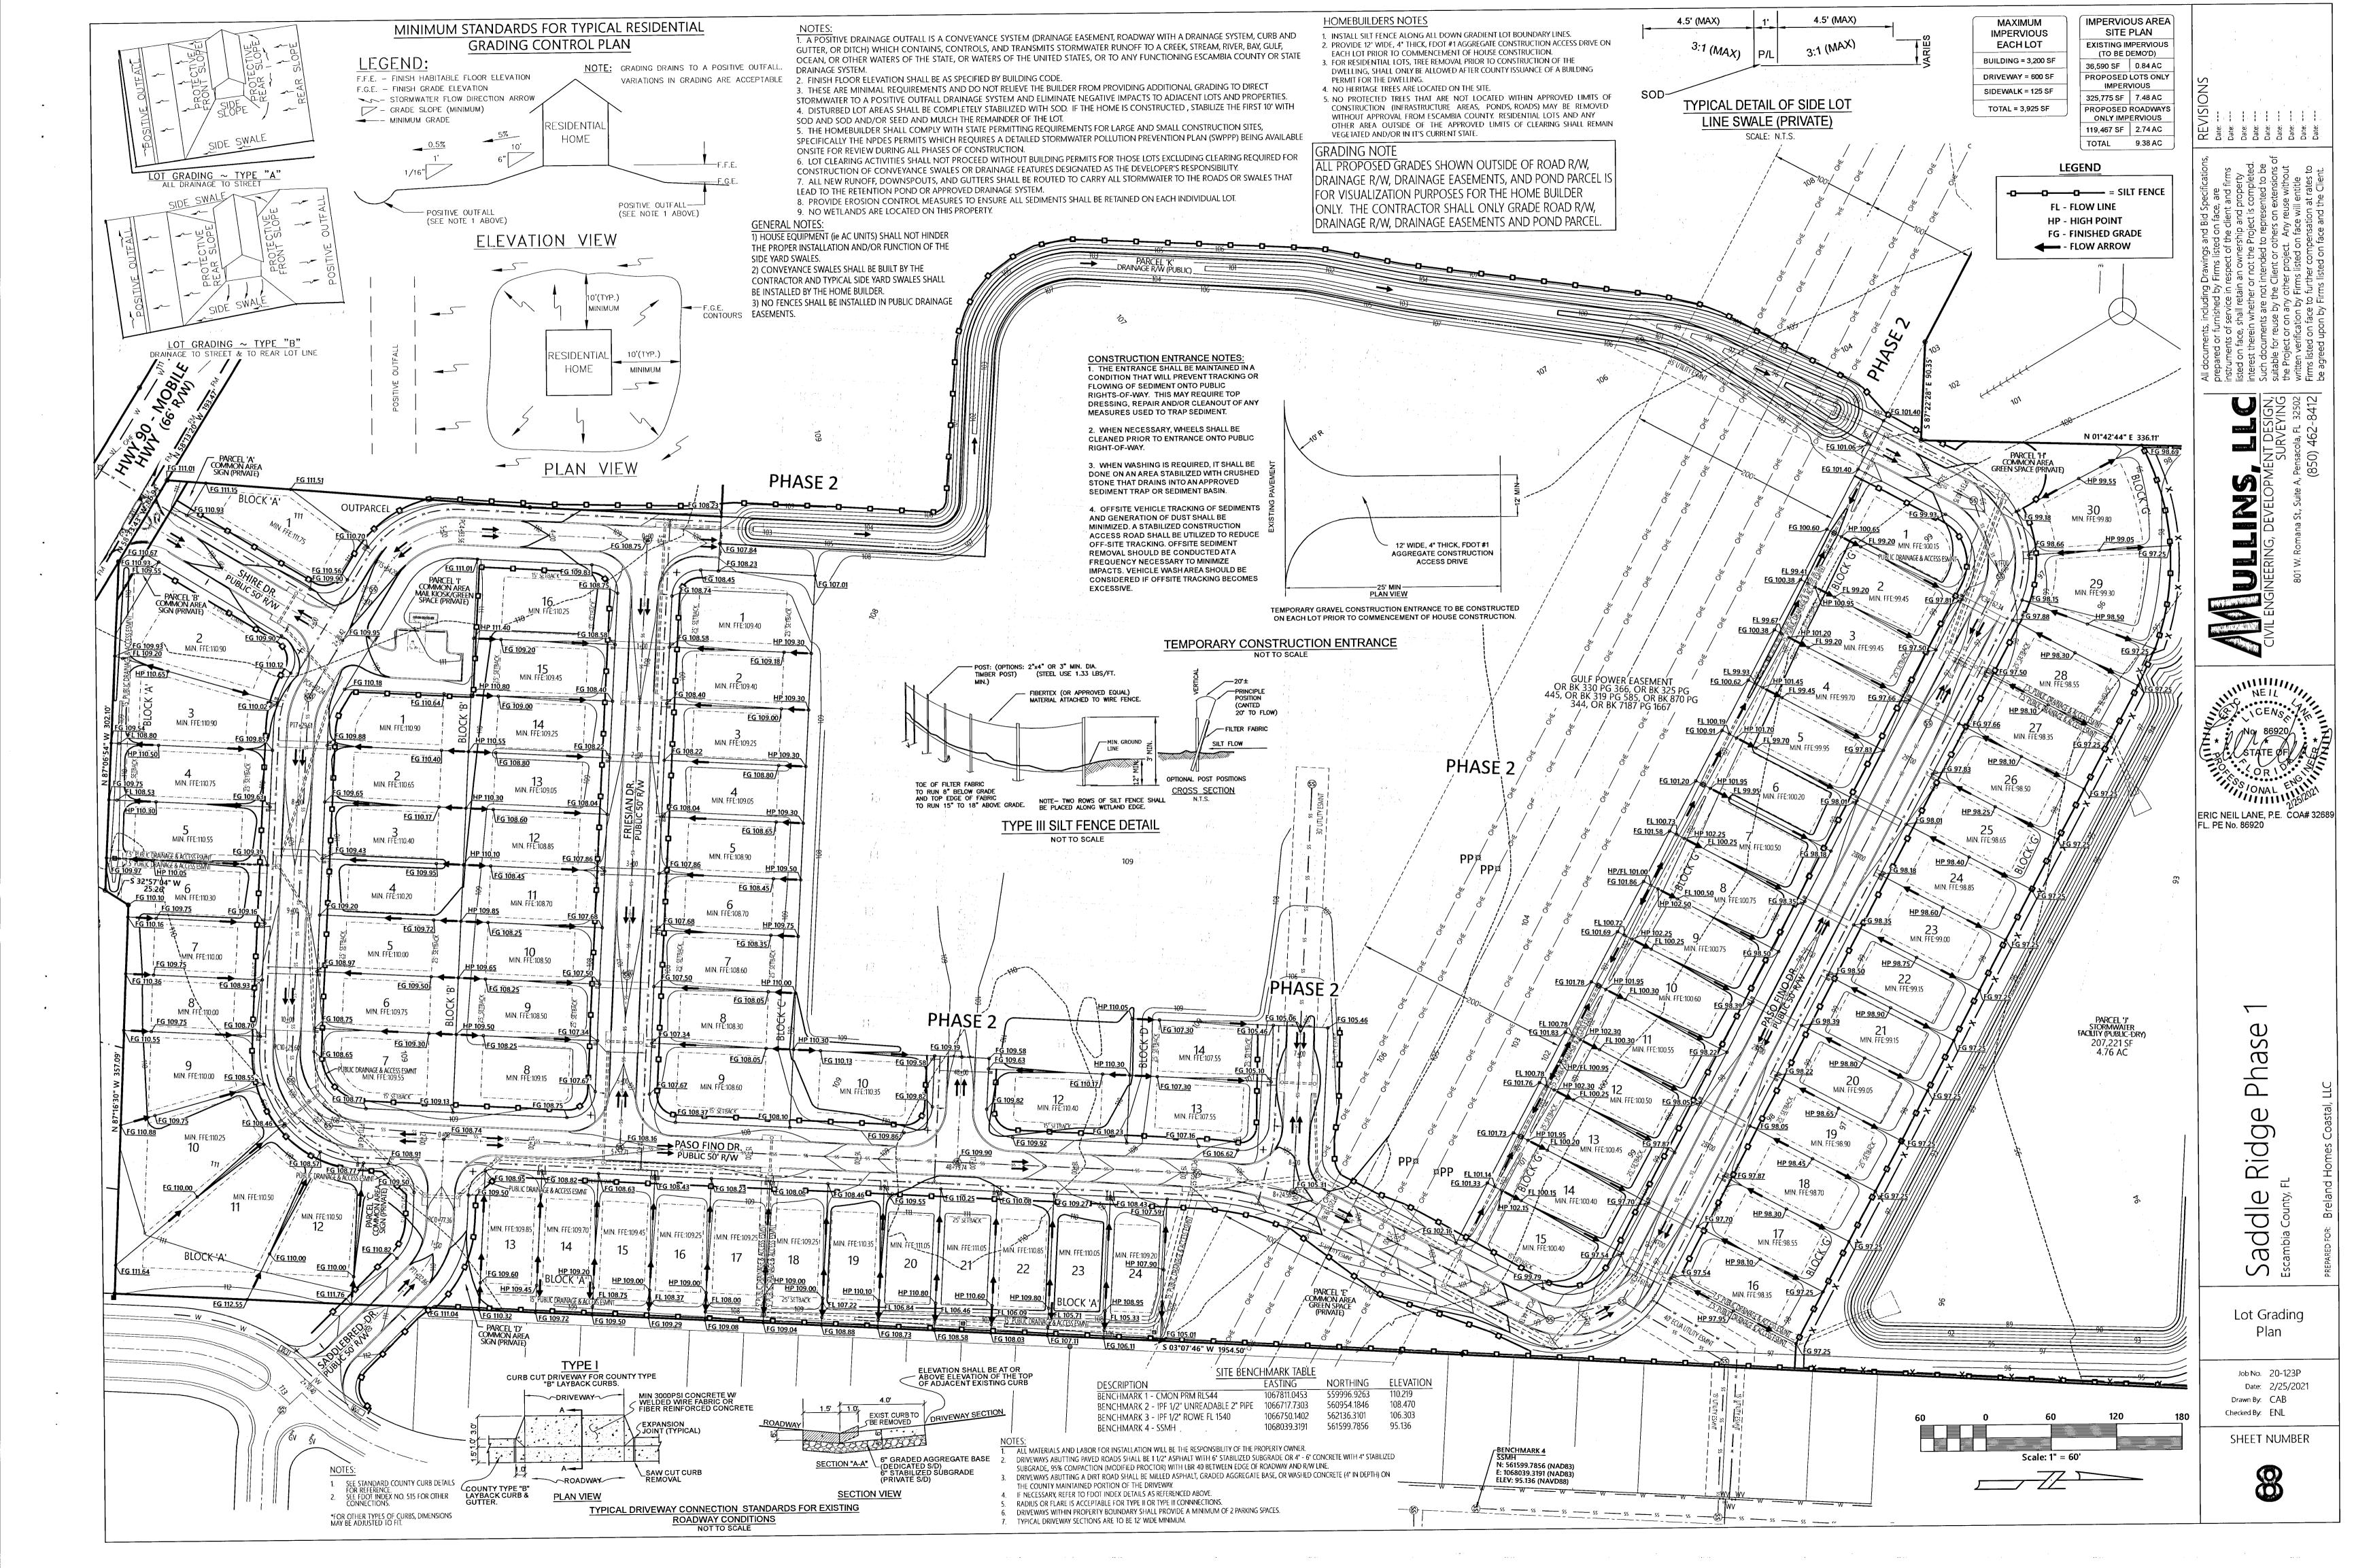
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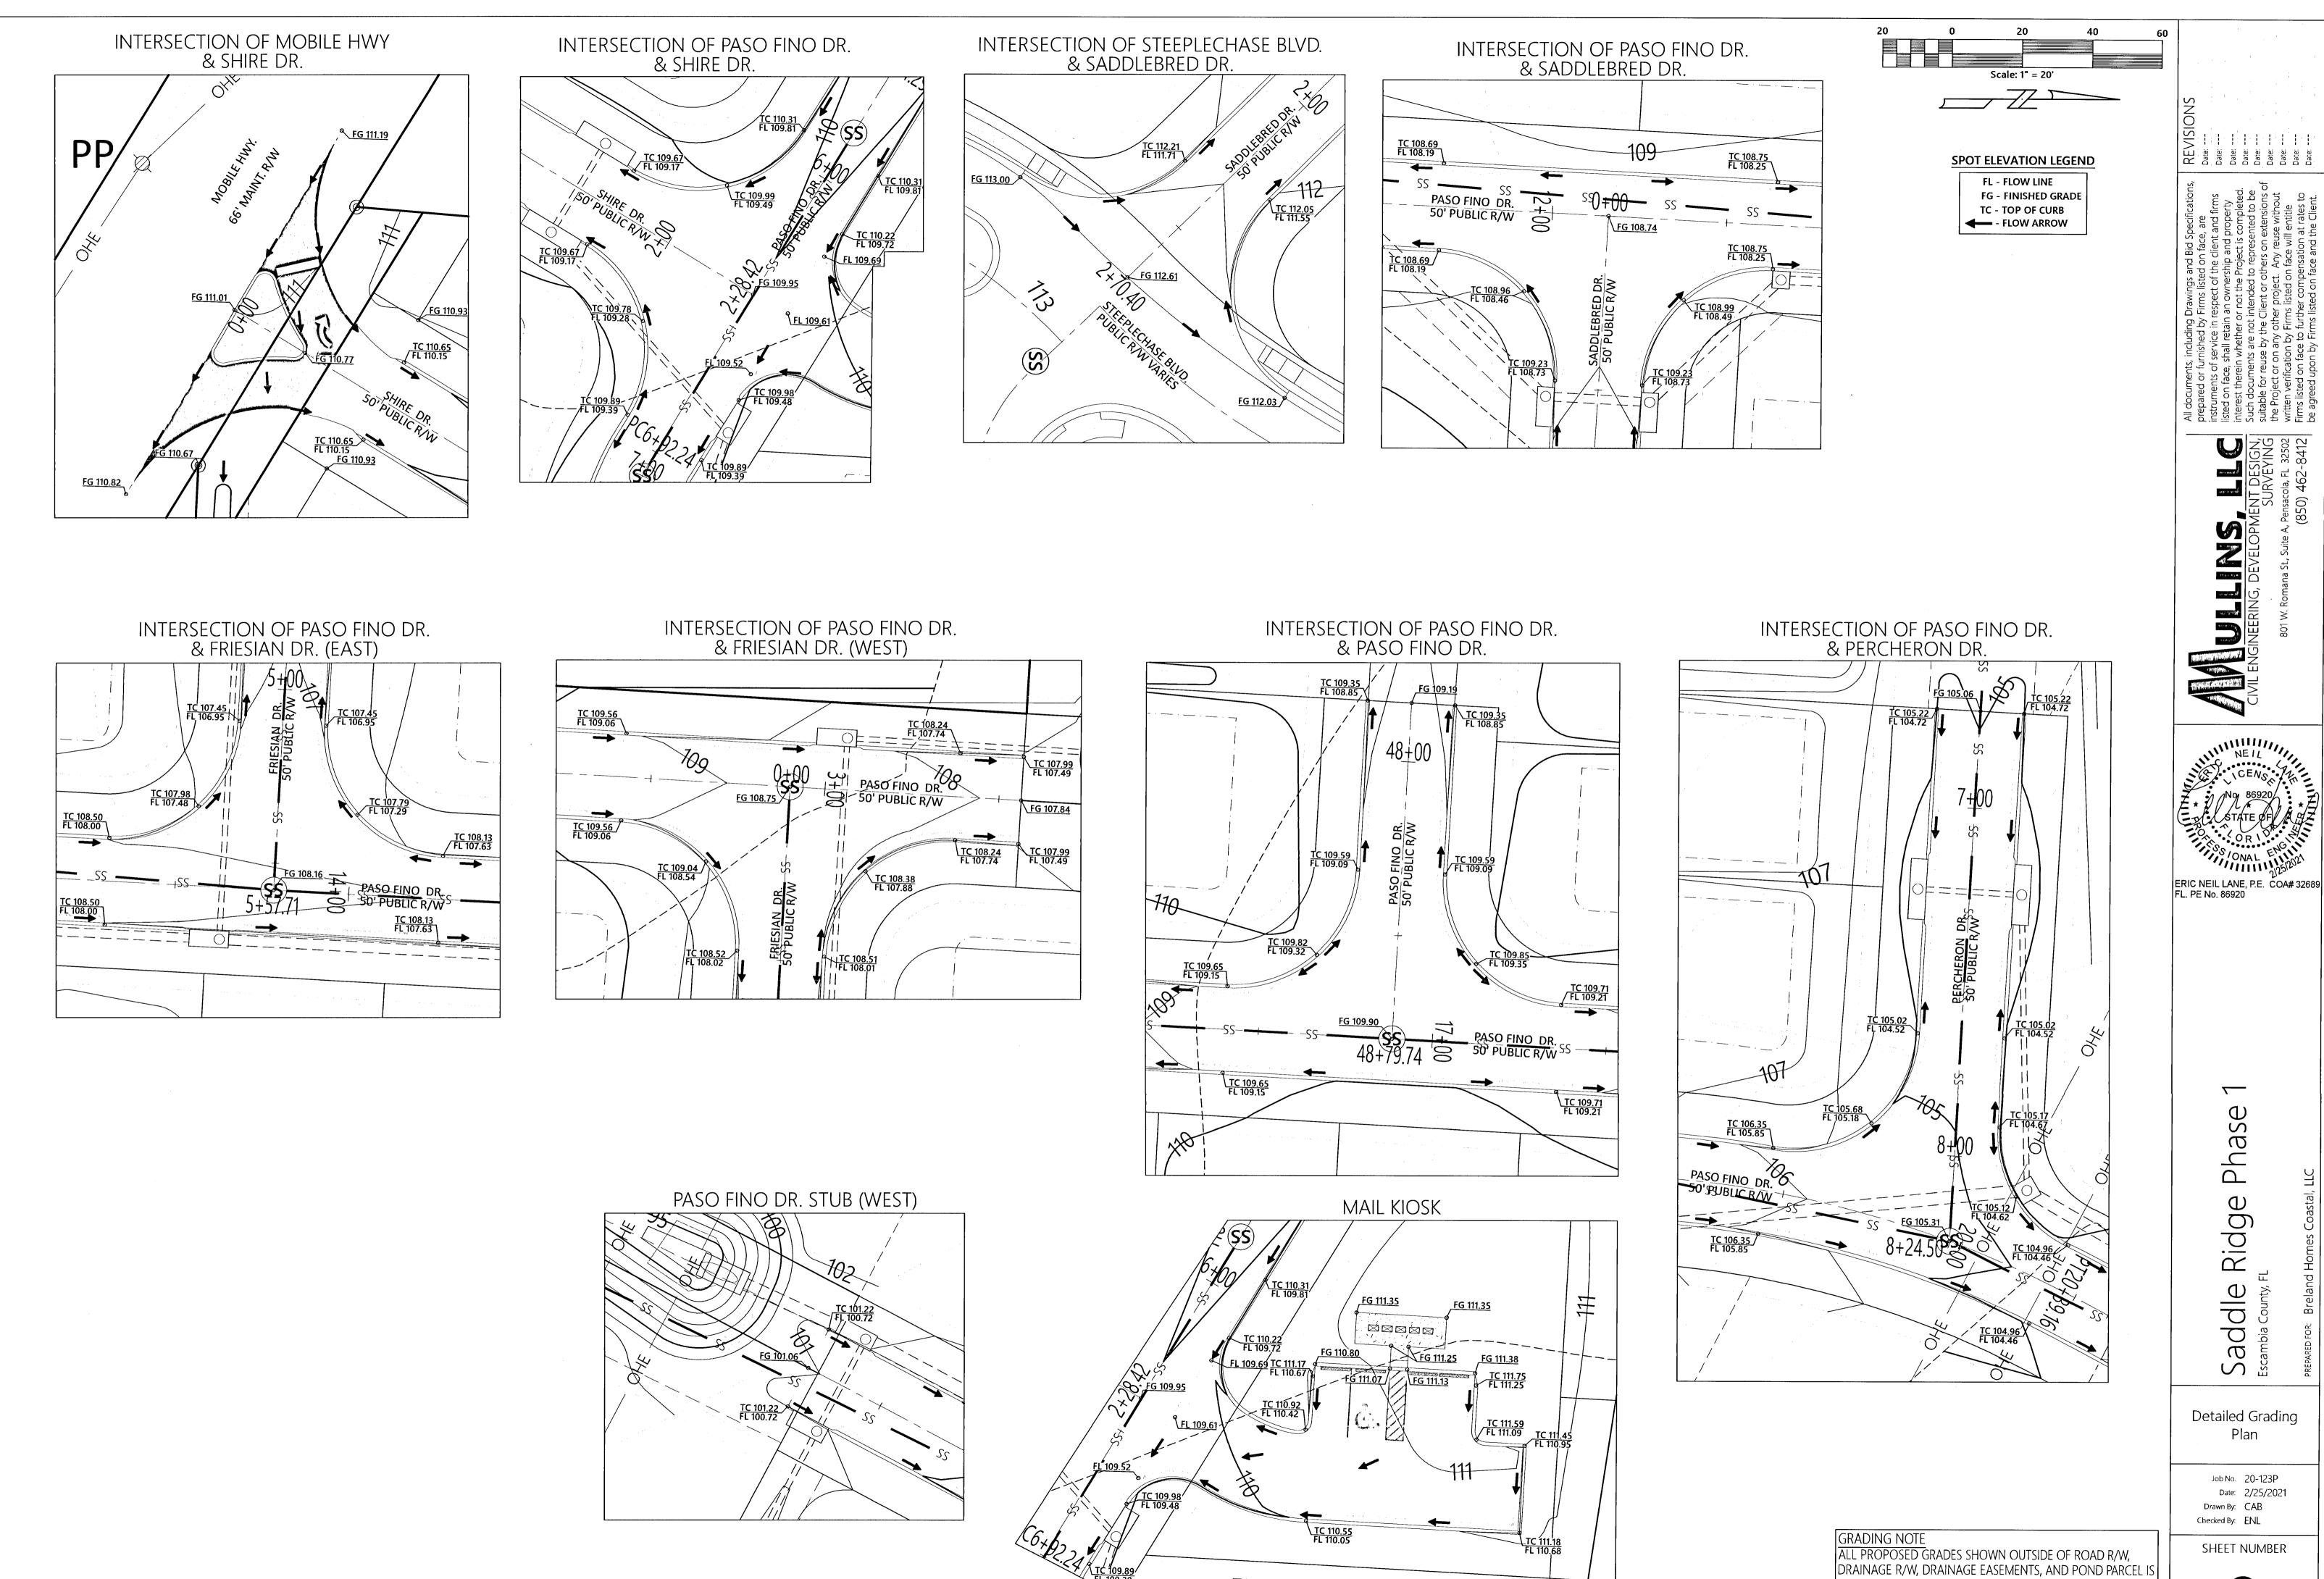






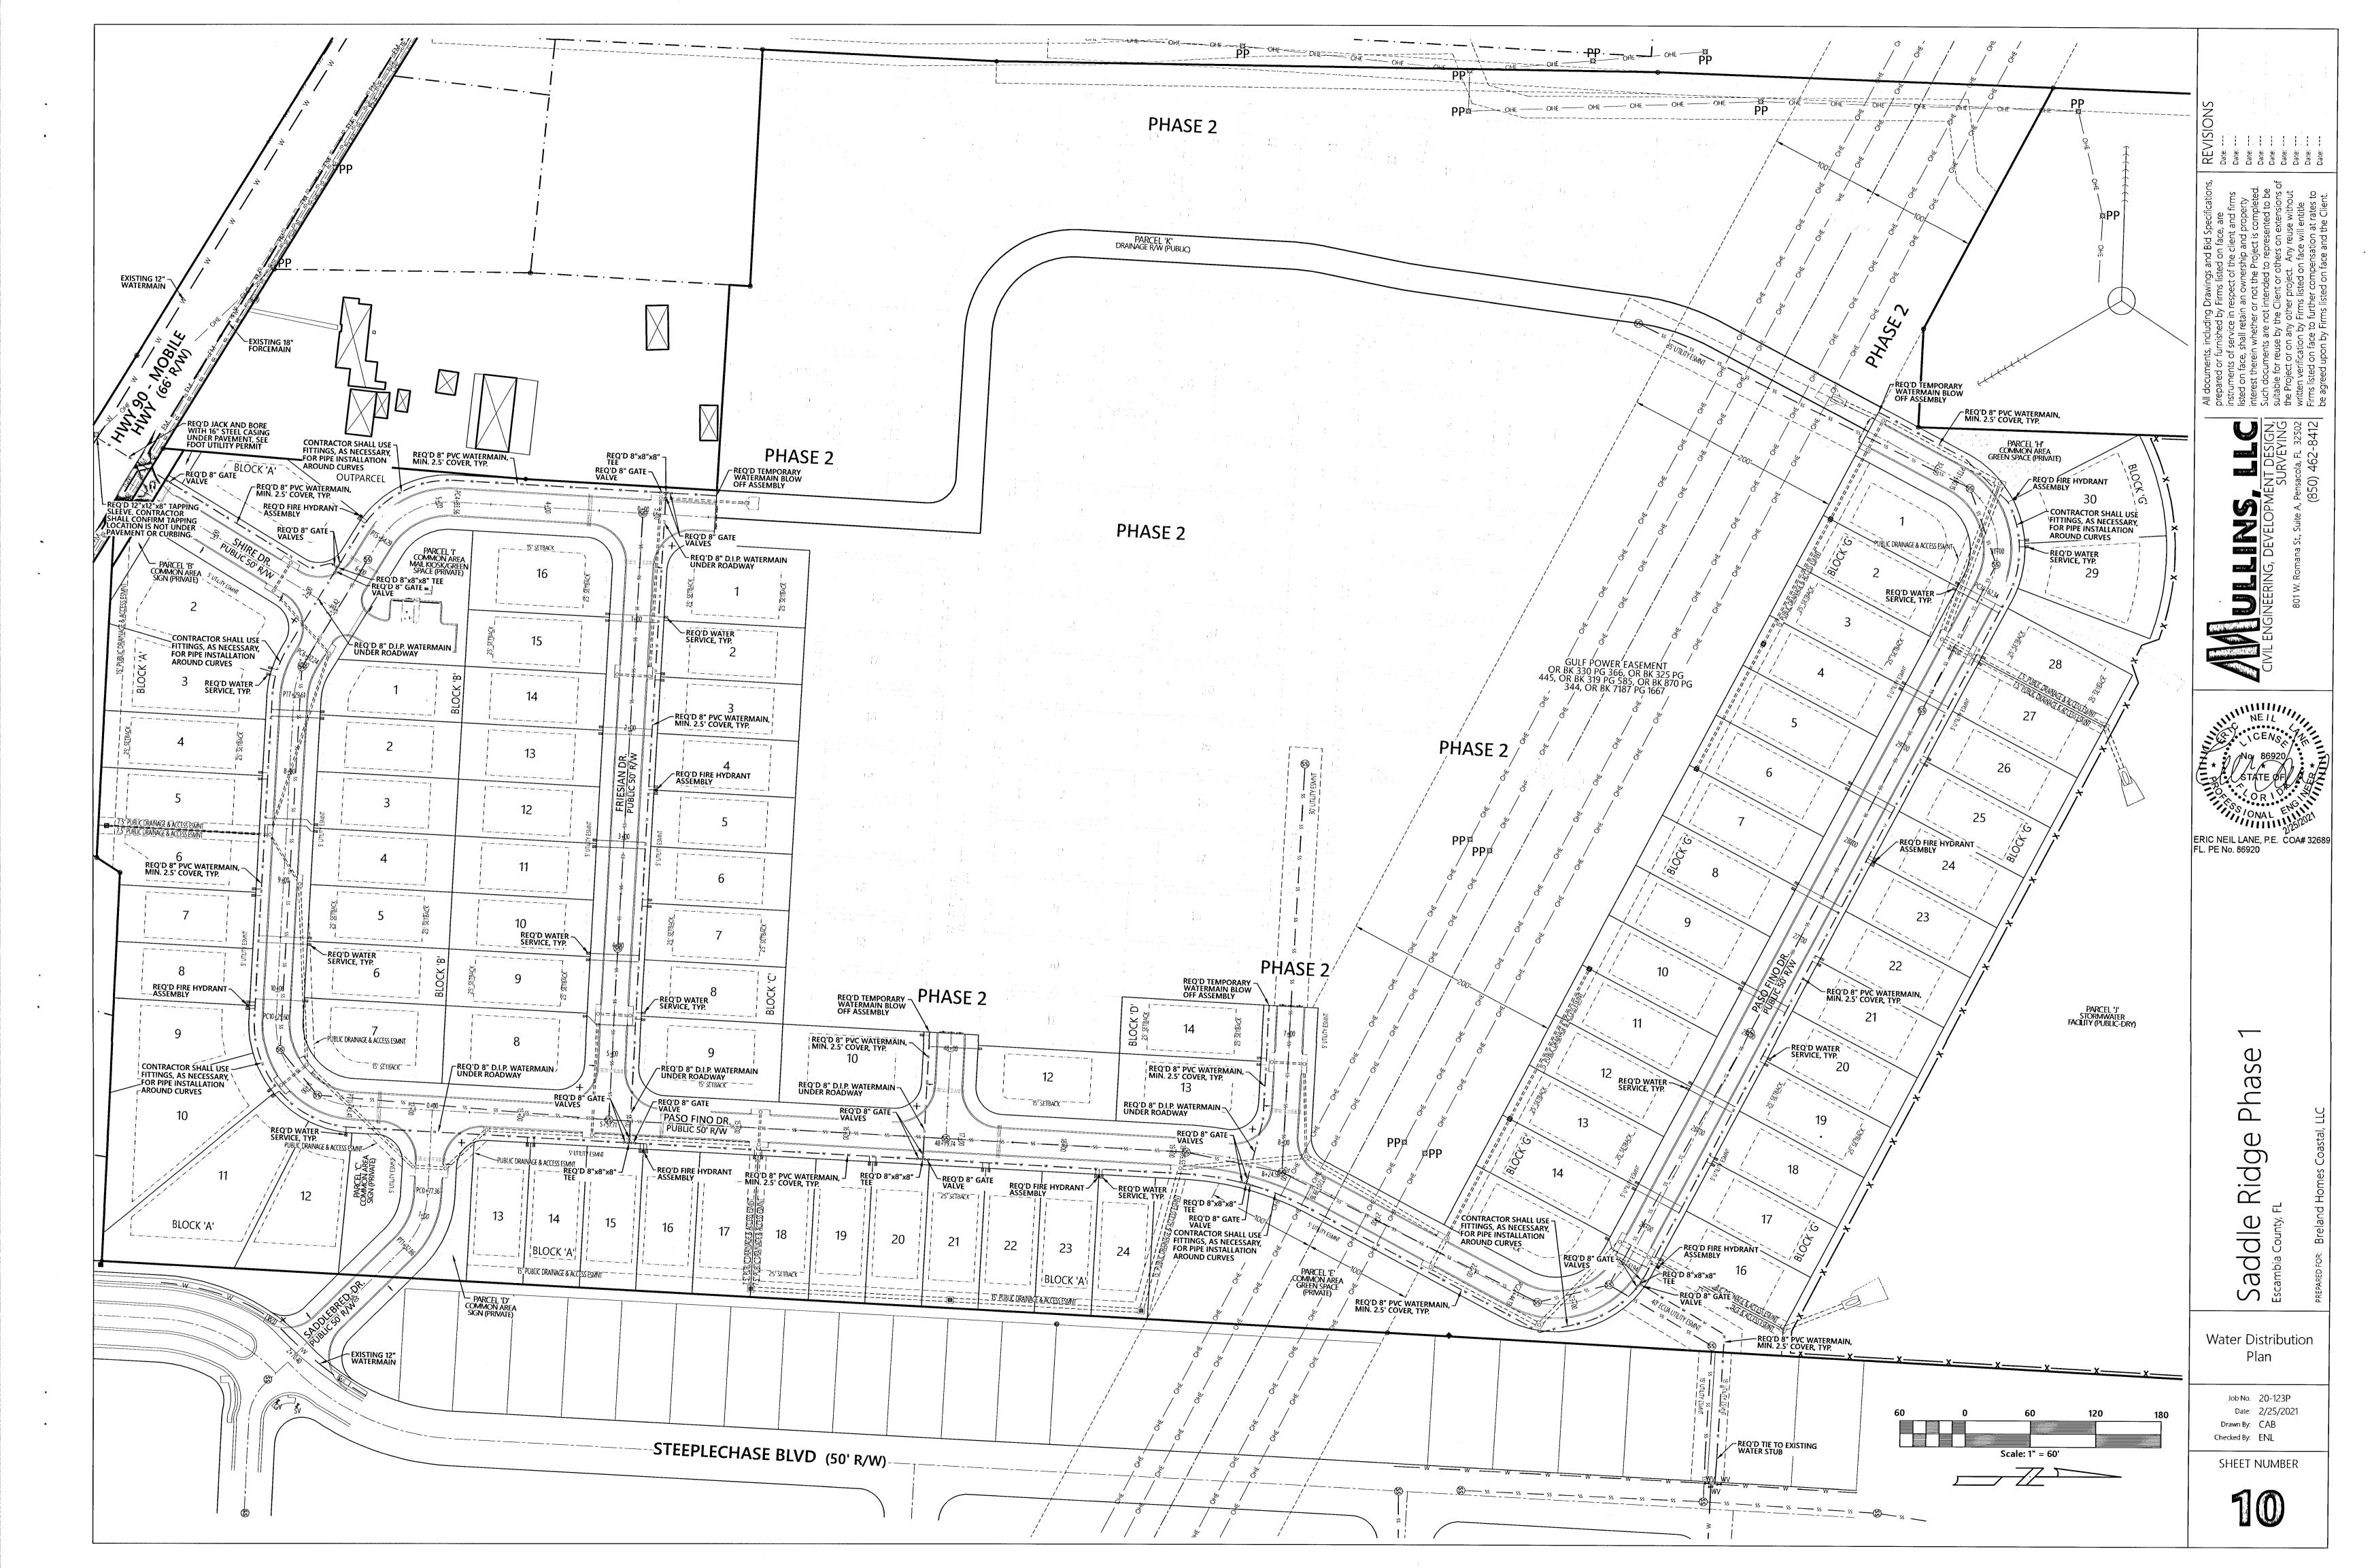


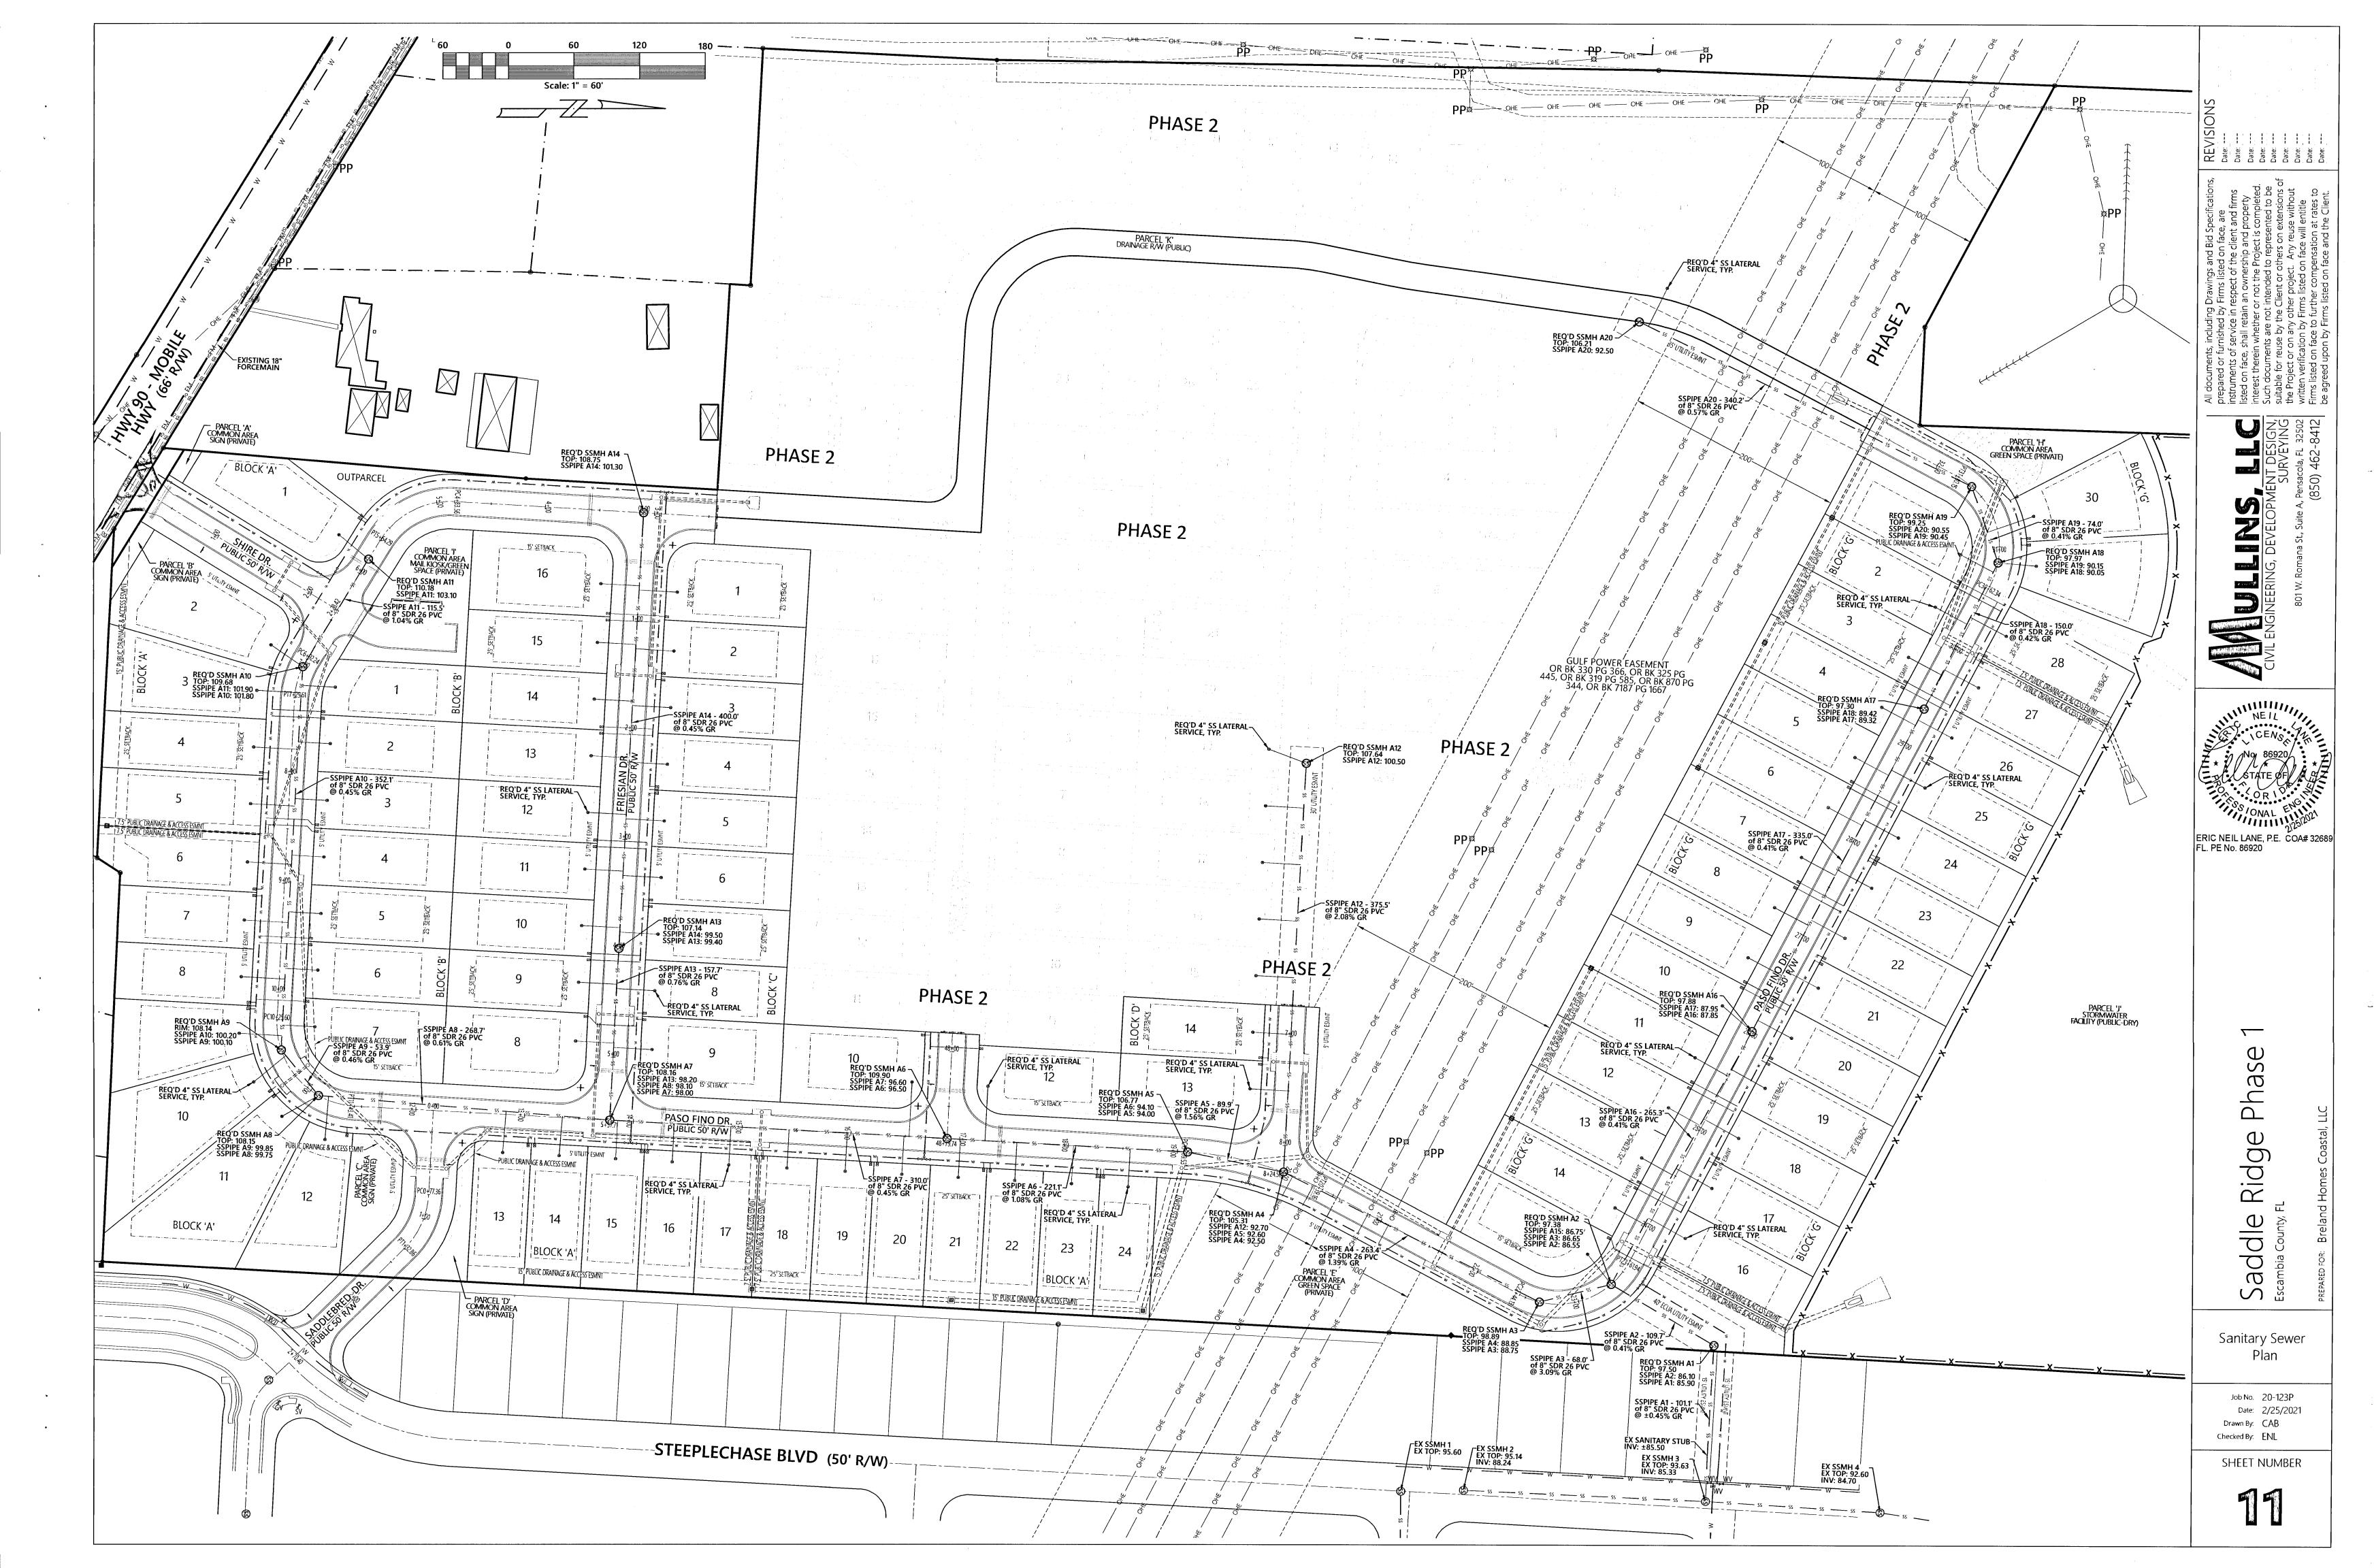


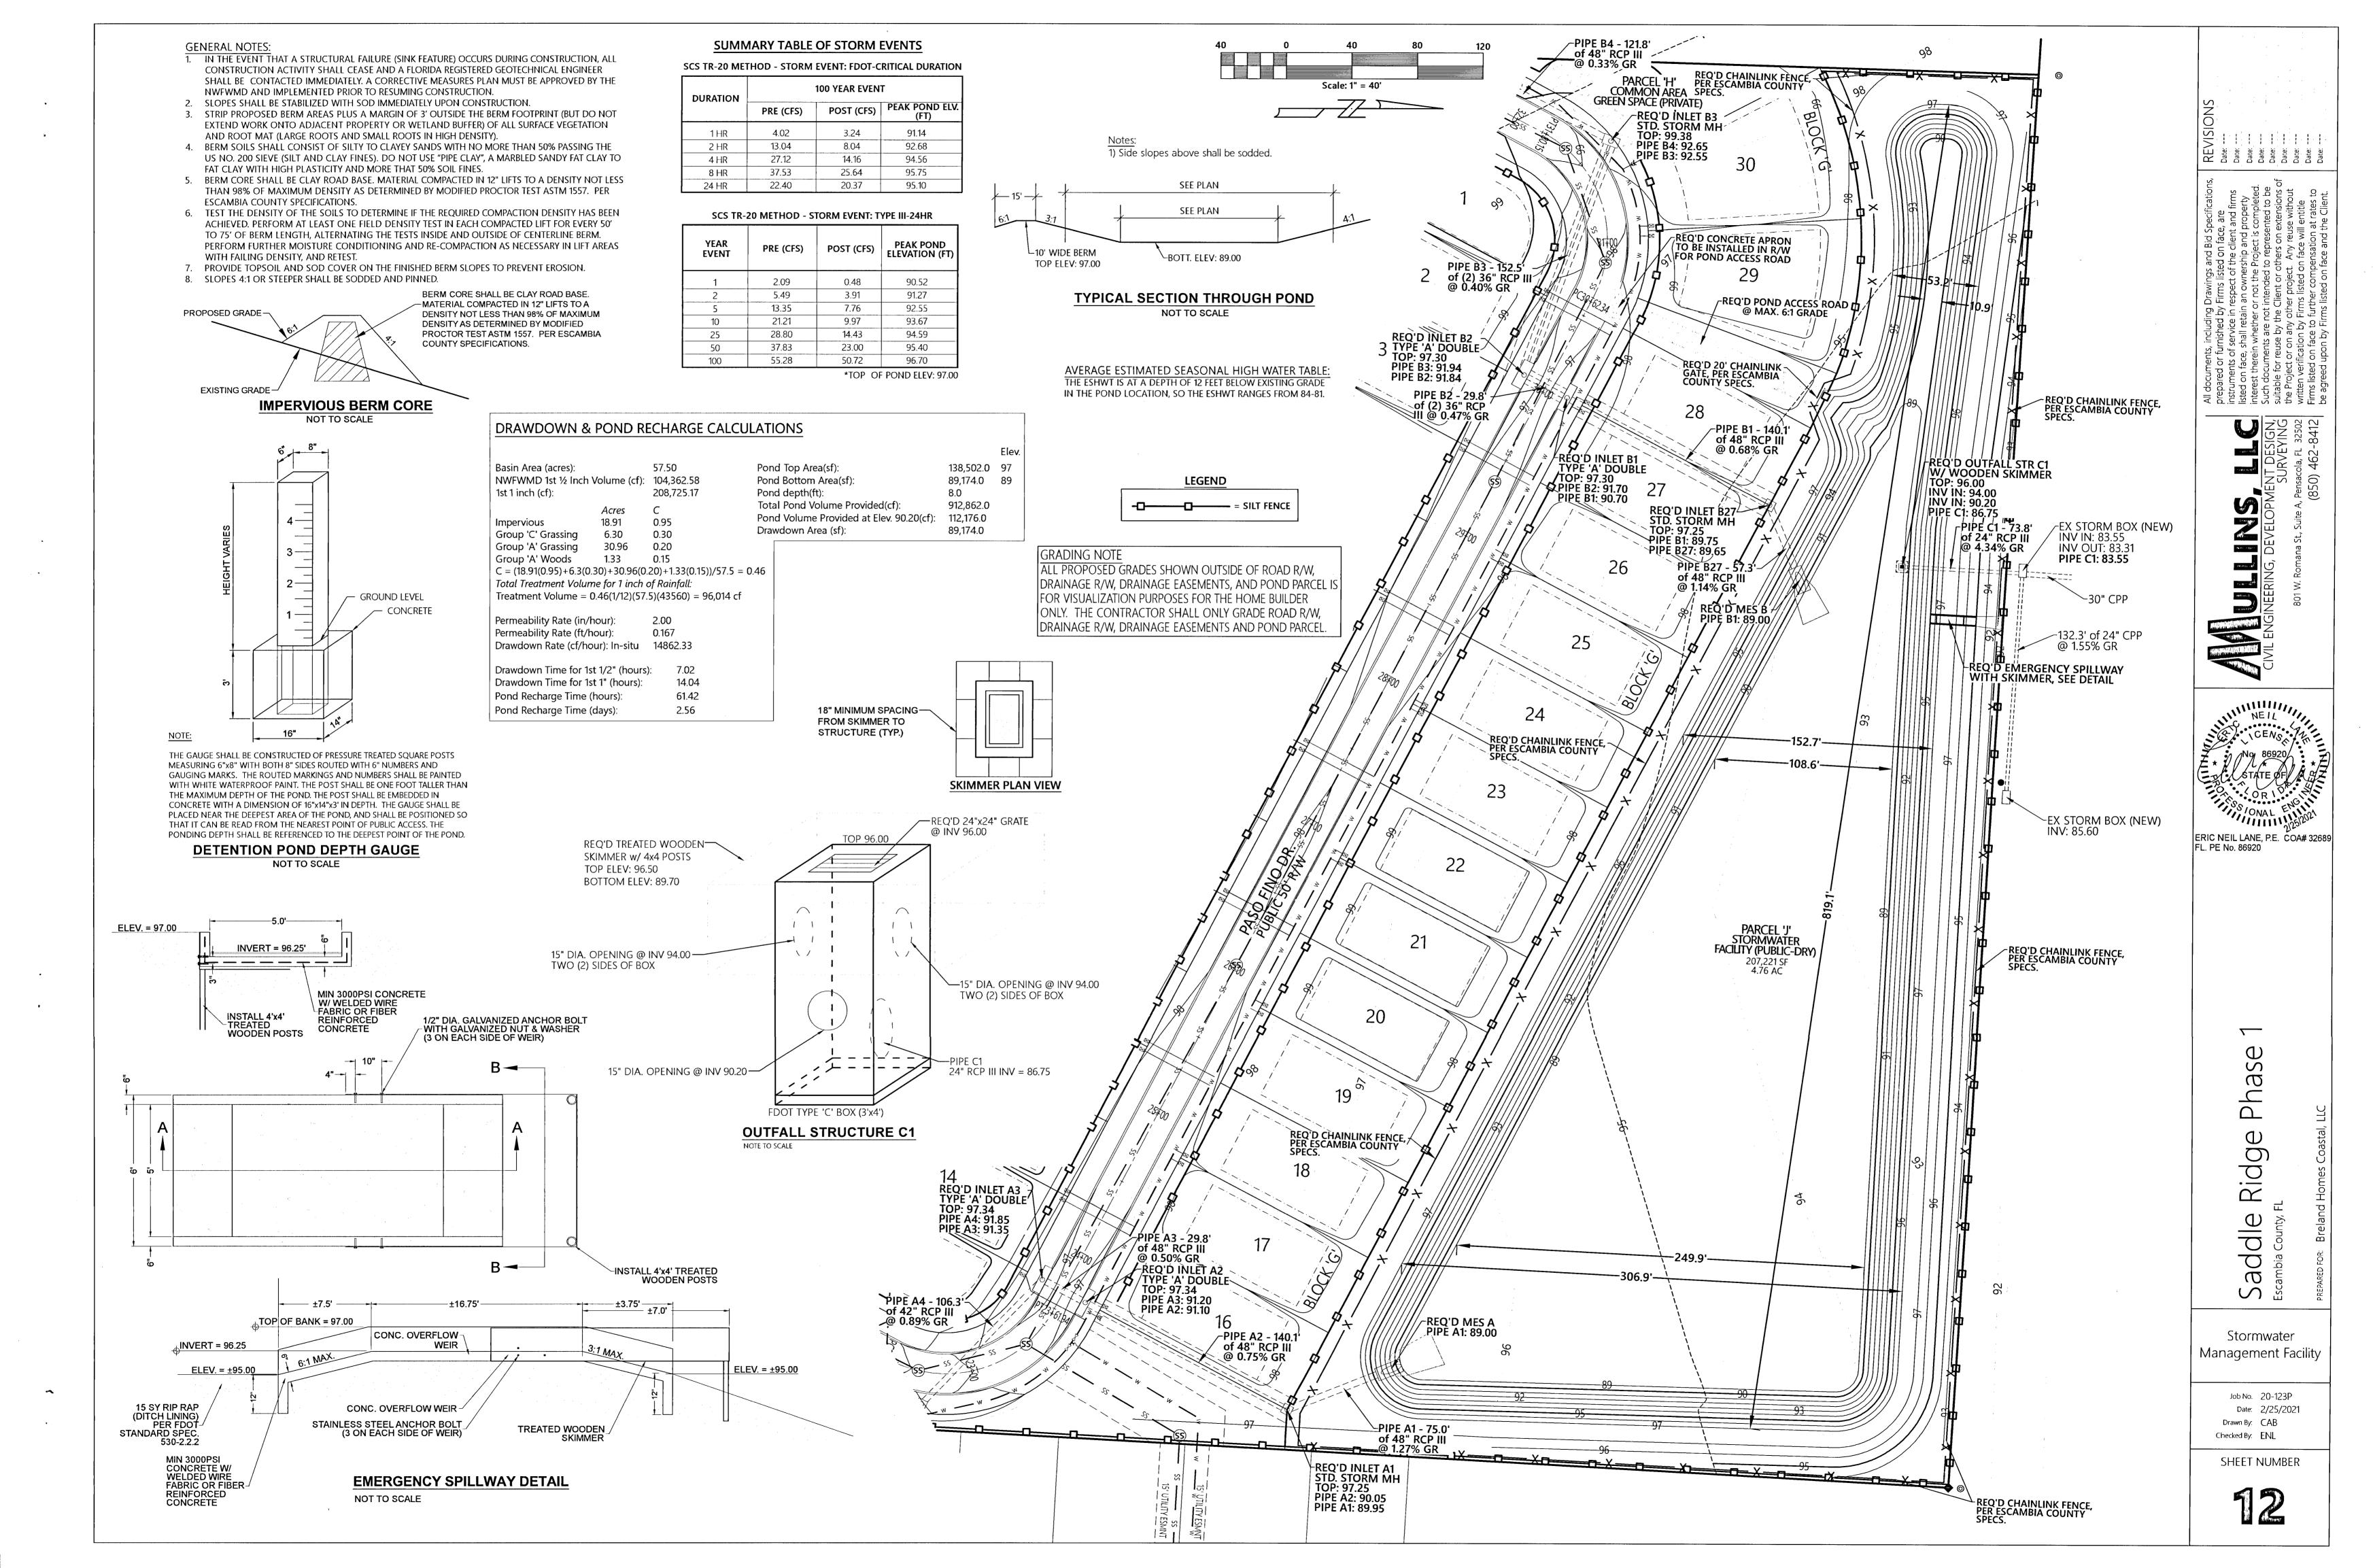


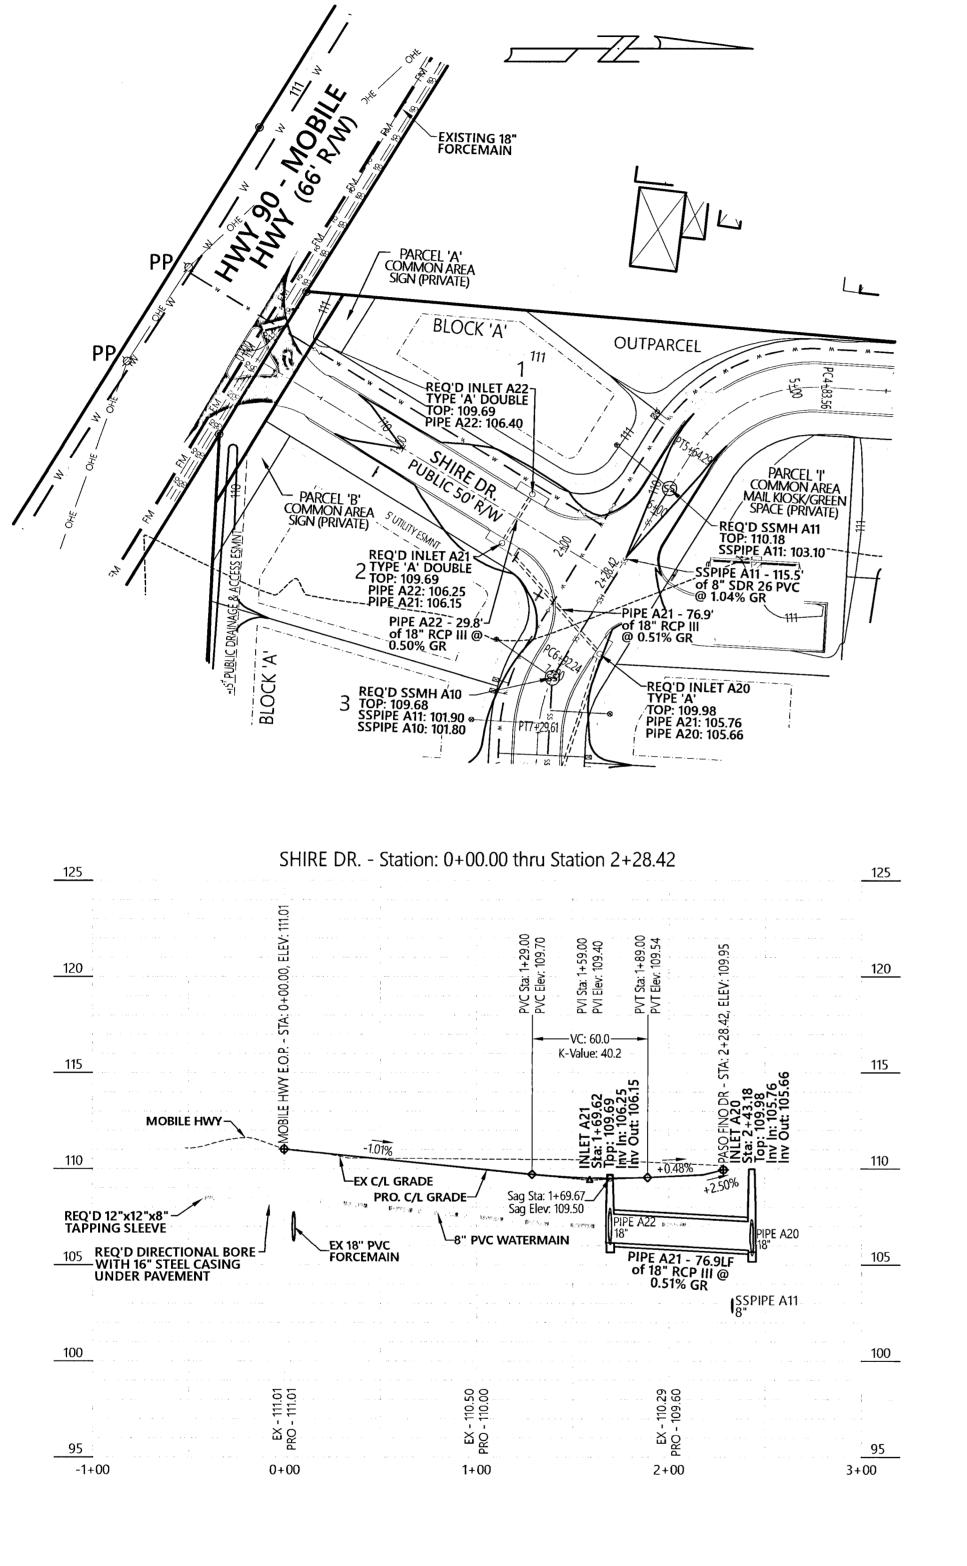
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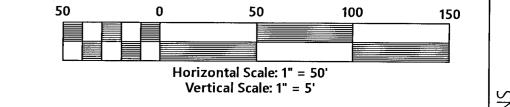
FOR VISUALIZATION PURPOSES FOR THE HOME BUILDER ONLY. THE CONTRACTOR SHALL ONLY GRADE ROAD R/W, DRAINAGE R/W, DRAINAGE EASEMENTS AND POND PARCEL.









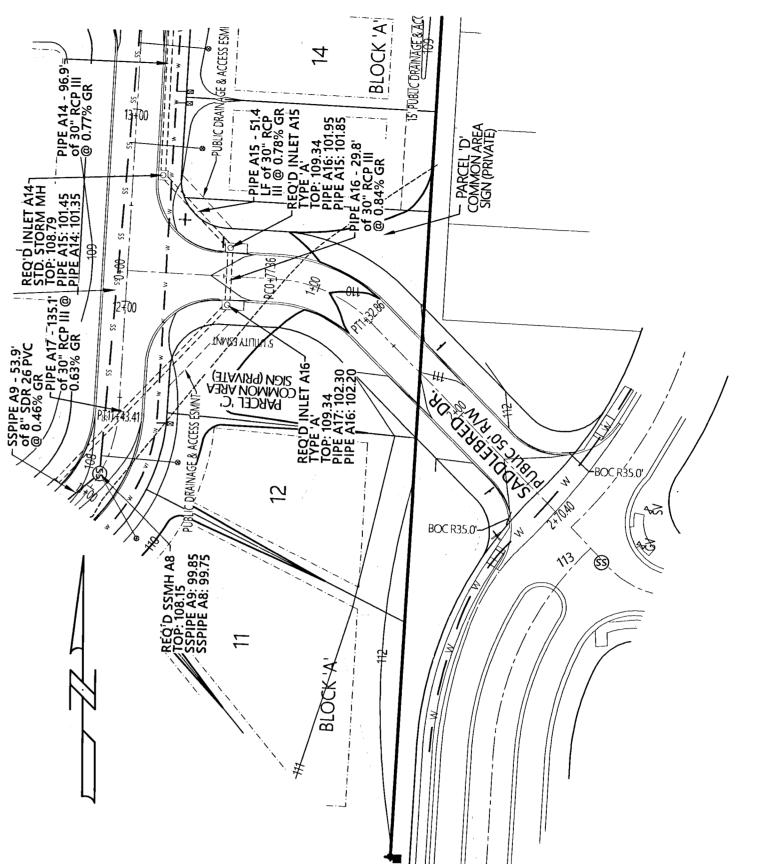


SADDLEBRED DR. - Station: 0+00.00 thru Station 2+70.40 <u>95</u> -1+00

GRADING NOTE

ALL PROPOSED GRADES SHOWN OUTSIDE OF ROAD R/W, DRAINAGE R/W, DRAINAGE EASEMENTS, AND POND PARCEL IS

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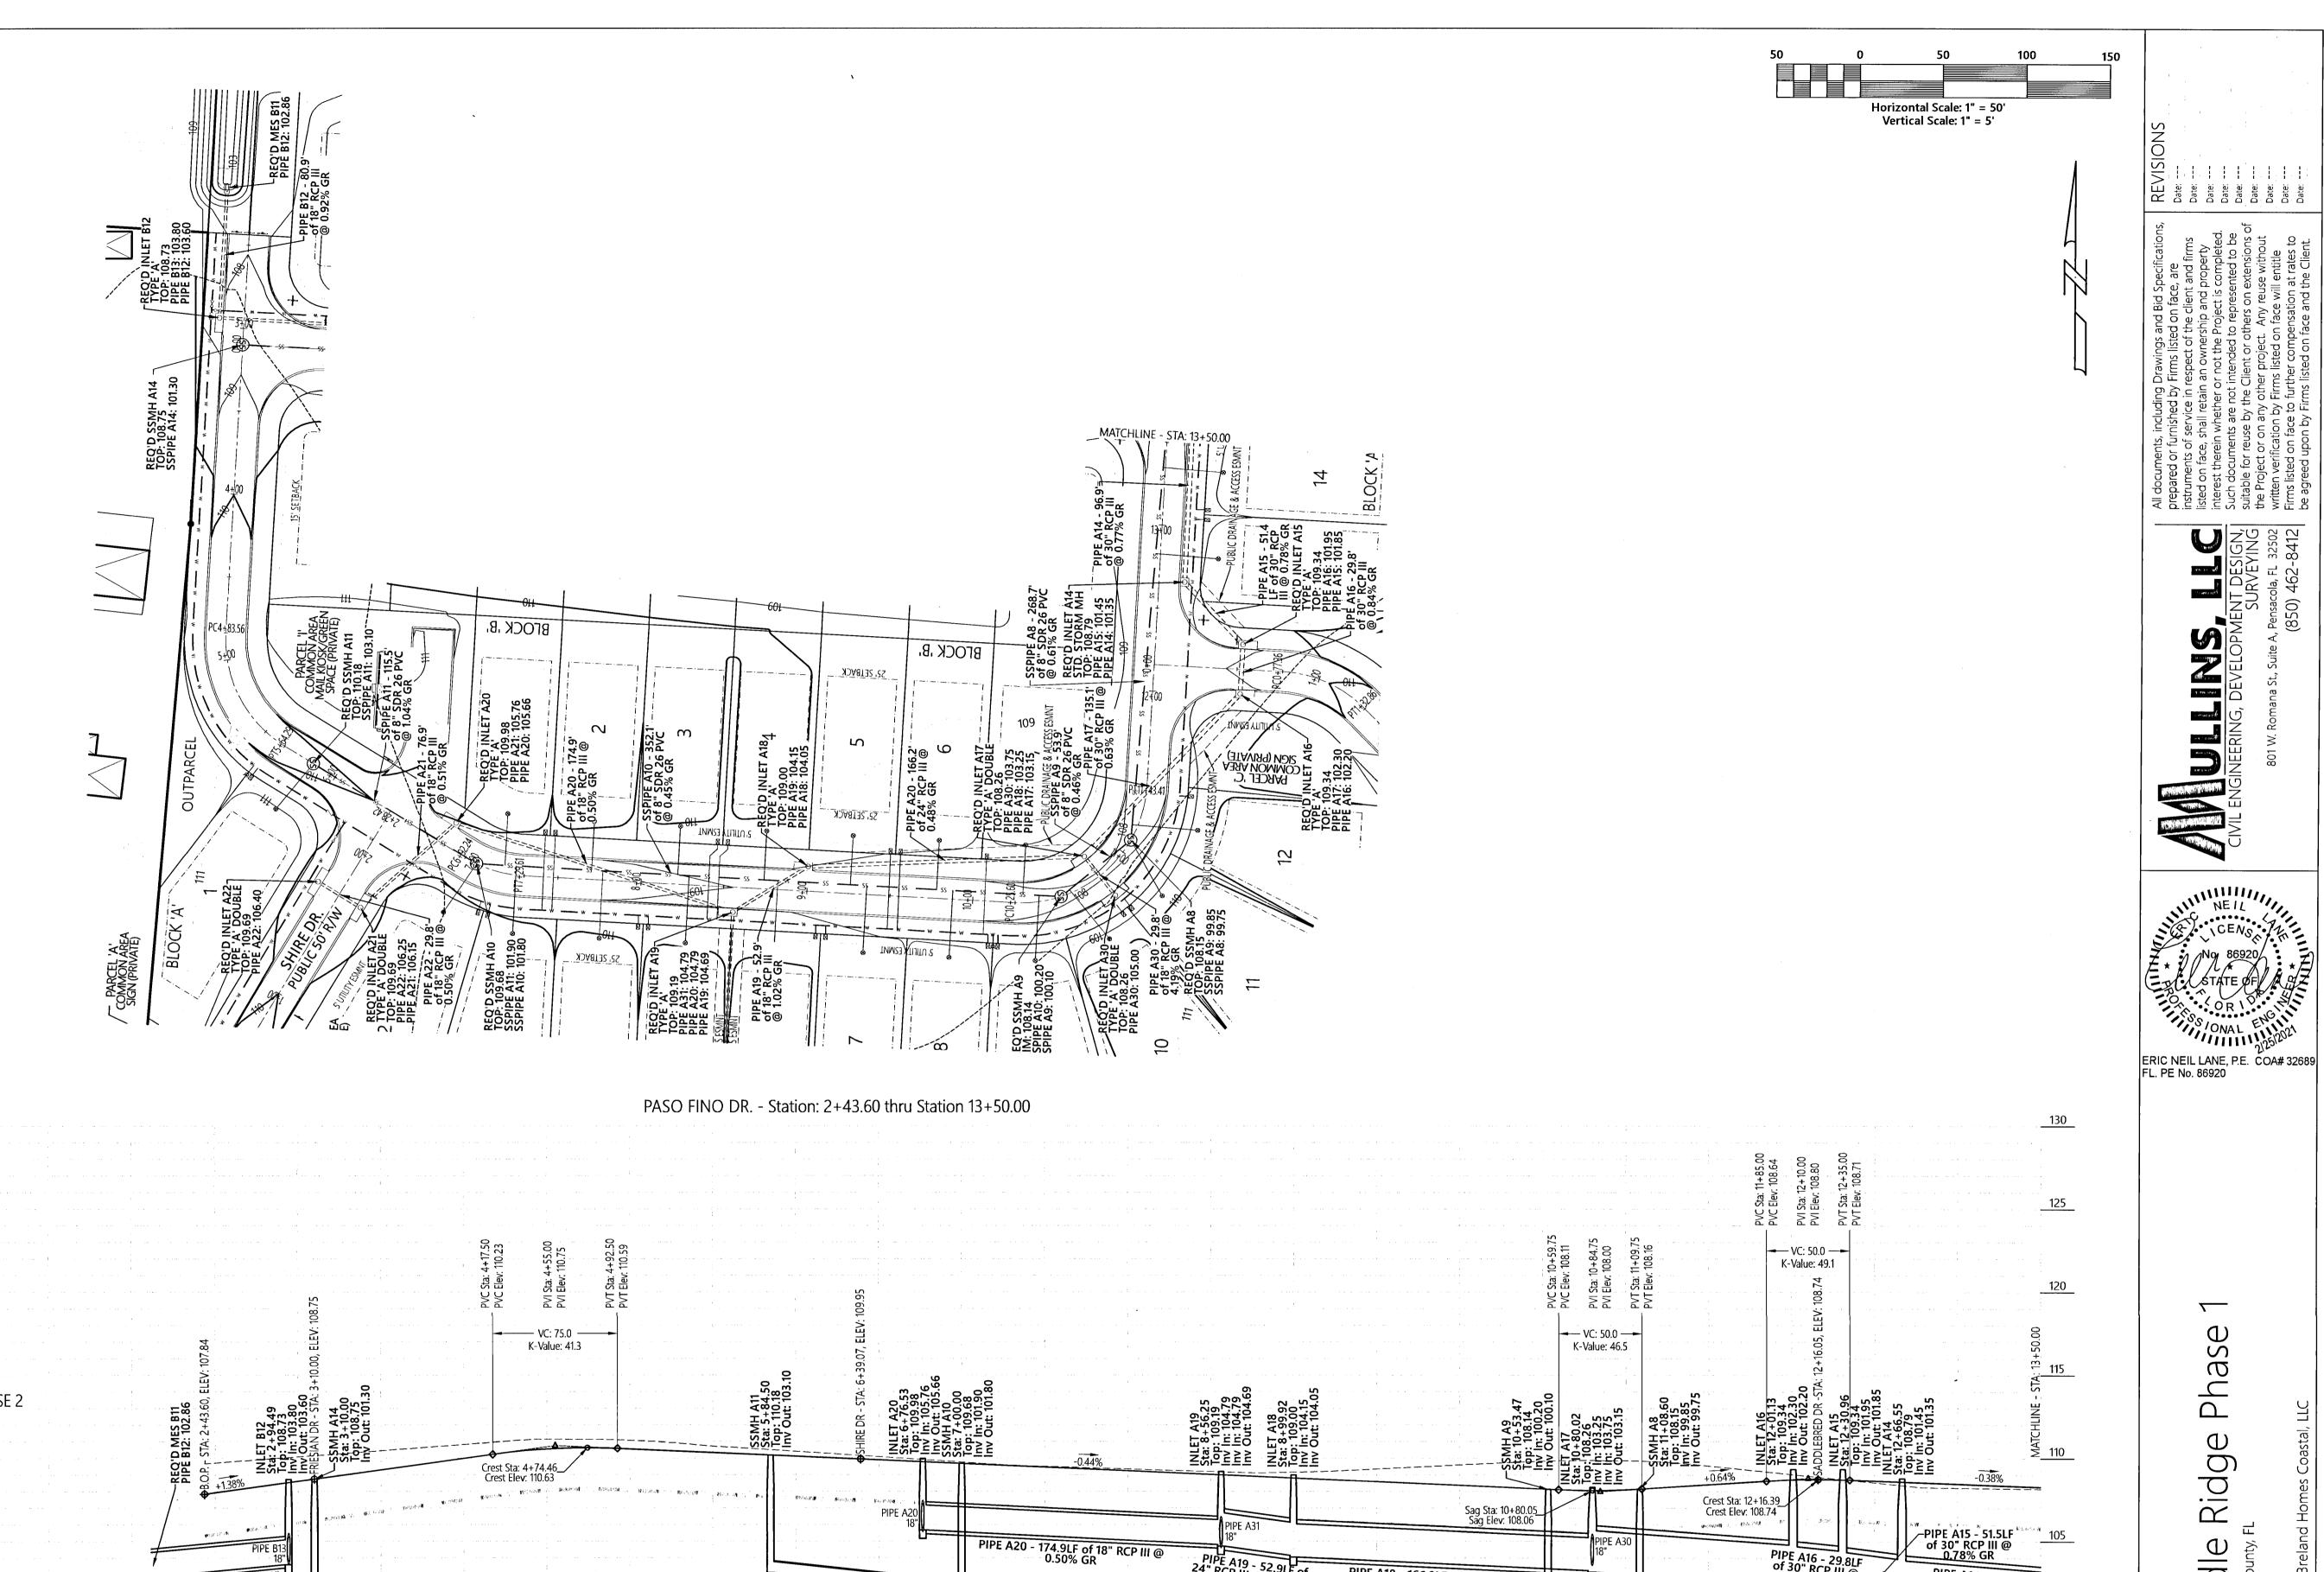
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Saddlebred Dr. Plan & Profile

Job No. 20-123P Date: 2/25/2021 Drawn By: CAB Checked By: ENL



PIPE A18 - 166.2LF of 24" RCP III @ 0.48% GR

11+00

Phase Ridge Saddle Escambia County, F

> Paso Fino Dr. Plan & Profile

Job No. 20-123P Date: 2/25/2021 Drawn By: CAB Checked By: ENL

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EX - 108.22 PRO - 108.46

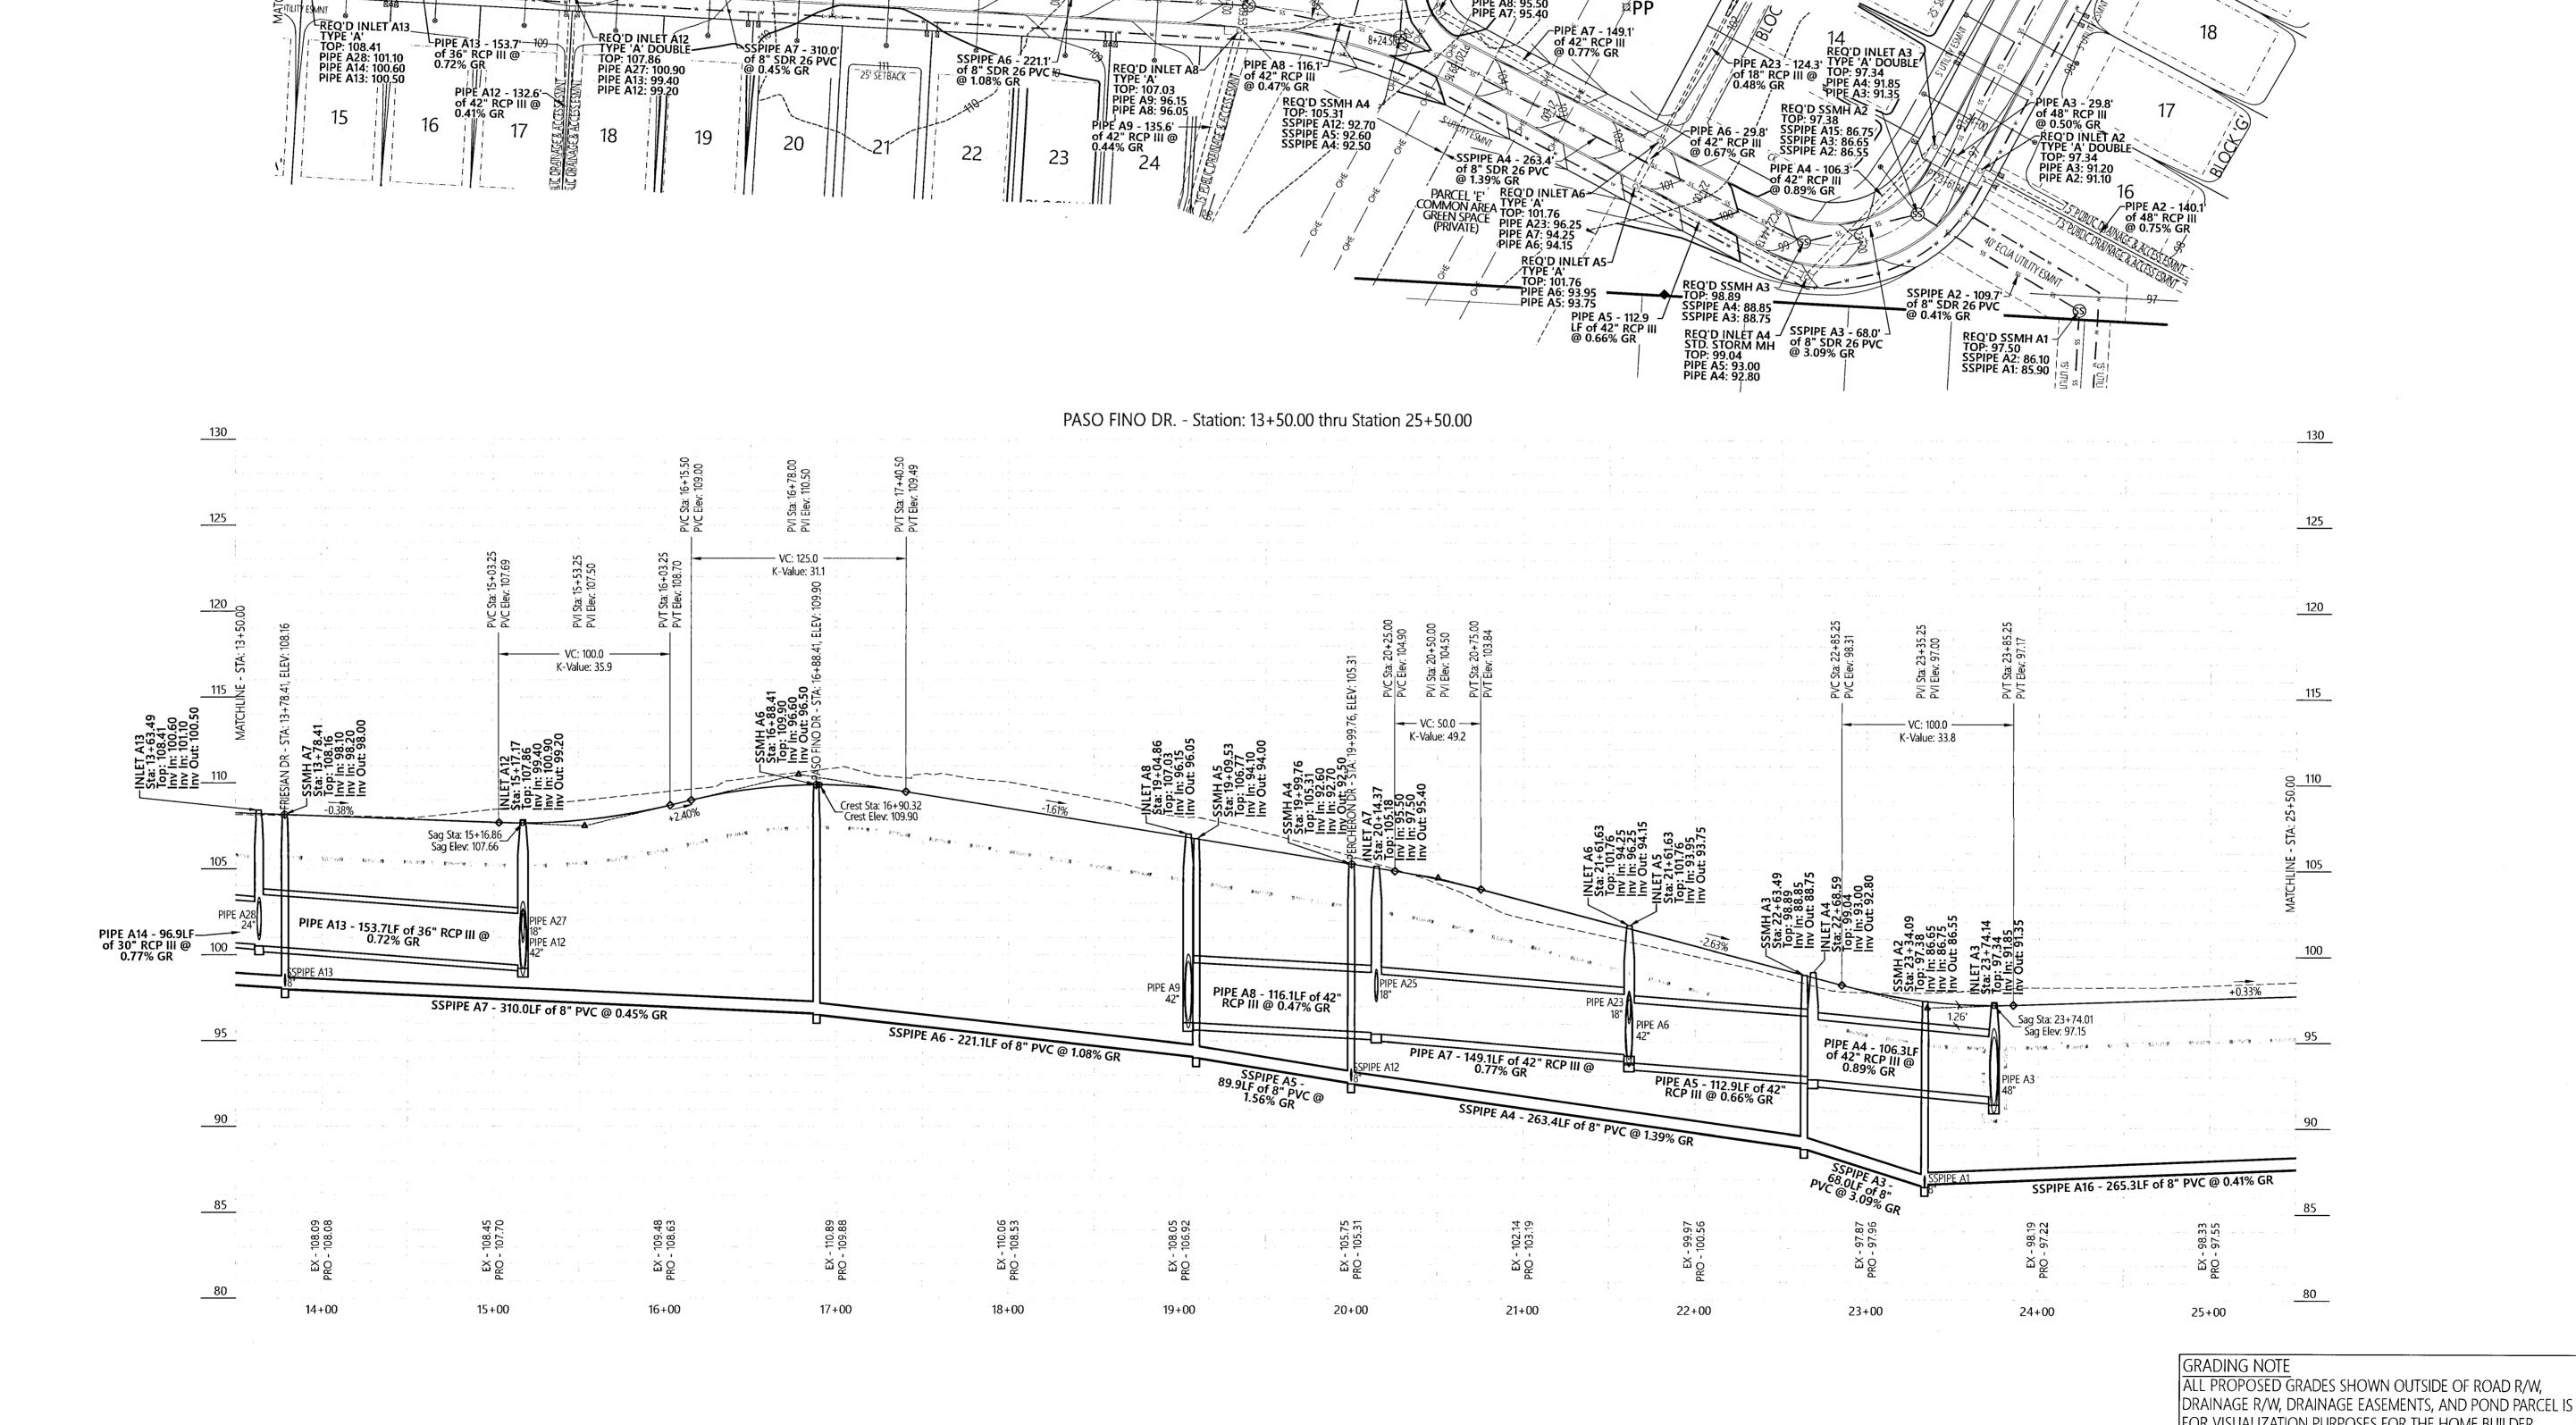
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DRAINAGE R/W, DRAINAGE EASEMENTS AND POND PARCEL.

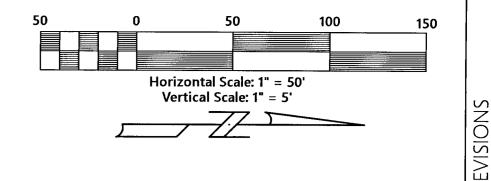
SSPIPE A8 - 268.7LF of 8" PVC @ 0.61% GR

12+00

GRADING NOTE



REQ'D SSMH A7 REQ'D INLET A27-TOP: 108.16 TYPE 'A' DOUBLE SSPIPE A13: 98.20 TOP: 107.86 SSPIPE A8: 98.10 PIPE A27: 103.00 SSPIPE A7: 98.00



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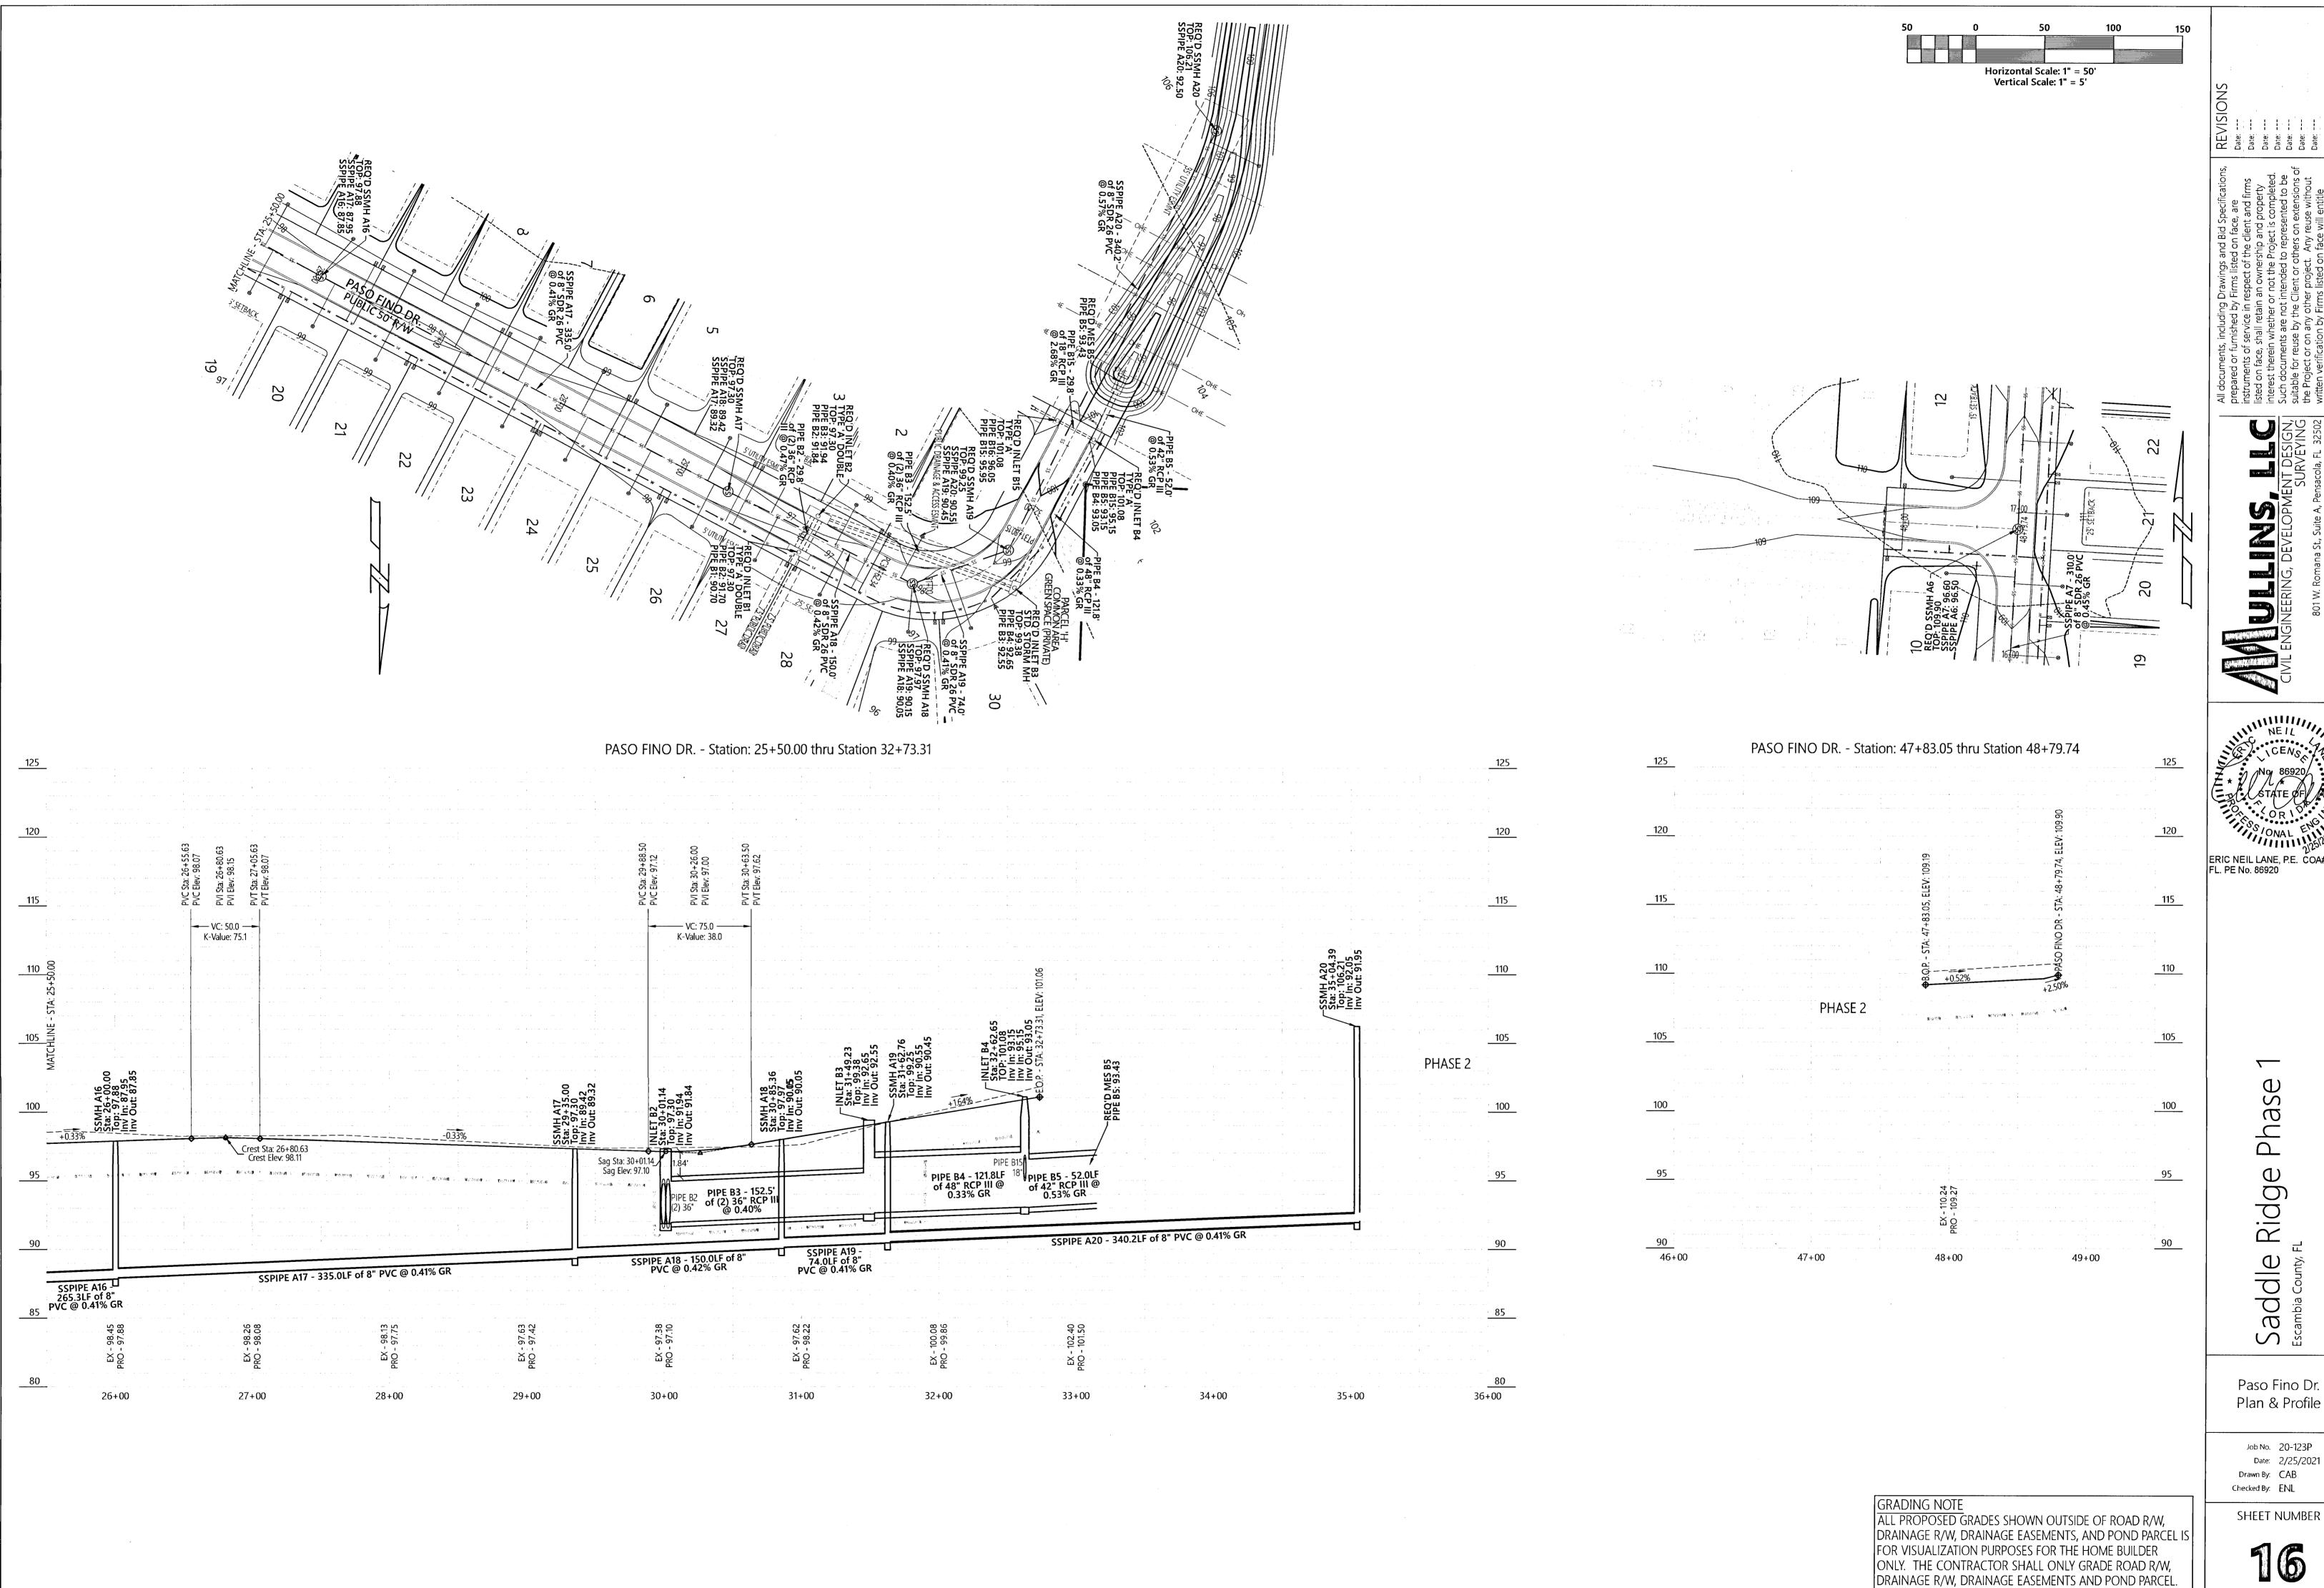
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ONLY. THE CONTRACTOR SHALL ONLY GRADE ROAD R/W, DRAINAGE R/W, DRAINAGE EASEMENTS AND POND PARCEL.



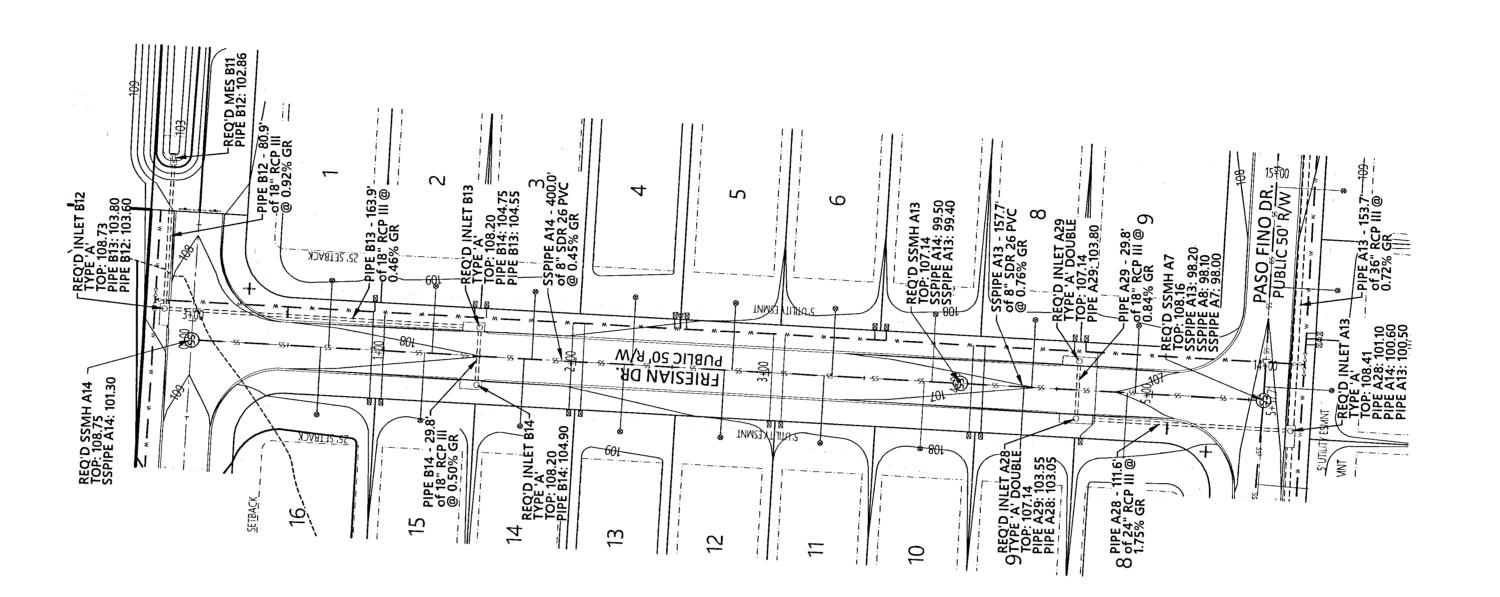
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Paso Fino Dr.

Plan & Profile

Job No. 20-123P Date: 2/25/2021 Drawn By: CAB

FRIESIAN DR. - Station: 0+00.00 thru Station 5+57.71 PVC Sta: 4+49.50
PVC Elev: 106.96
PVI Sta: 4+82.00
PVI Elev: 106.85
PVT Sta: 5+14.50
PVT Elev: 107.37 115 __110 Sag Sta: 4+61.04 Sag Elev: 106.94 105 PIPE B13 - 163.9LF of 18" RCP III @ 0.46% GR _100_ SSPIPE A14 - 400.0LF of 8" PVC @ 0.45% GR 100 <u>90</u> -1+00 0+00 1+00 2+00



Horizontal Scale: 1" = 50' Vertical Scale: 1" = 5'

ERIC NEIL LANE, P.E. COA# 32689 FL. PE No. 86920

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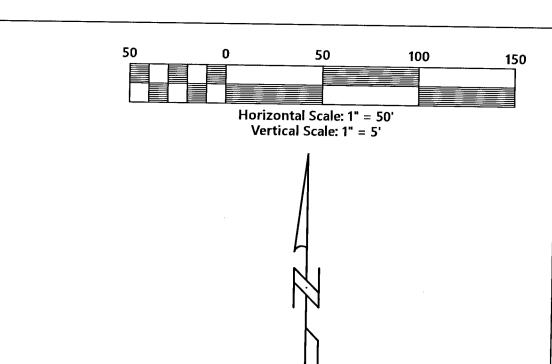
GRADING NOTE

ALL PROPOSED GRADES SHOWN OUTSIDE OF ROAD R/W,

FOR VISUALIZATION PURPOSES FOR THE HOME BUILDER ONLY. THE CONTRACTOR SHALL ONLY GRADE ROAD R/W,

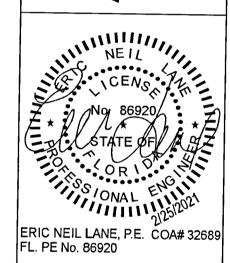
DRAINAGE R/W, DRAINAGE EASEMENTS AND POND PARCEL.

DRAINAGE R/W, DRAINAGE EASEMENTS, AND POND PARCEL IS



30' UTILITY ESMUT

PERCHERON DR. - Station: 6+72.03 thru Station 8+24.50 VC: 60.0 — K-Value: 35.7 PHASE 2 90 EX - 107.10 PRO - 104.78 EX - 106.34 PRO - 105.03 9+00 7+00 8+00



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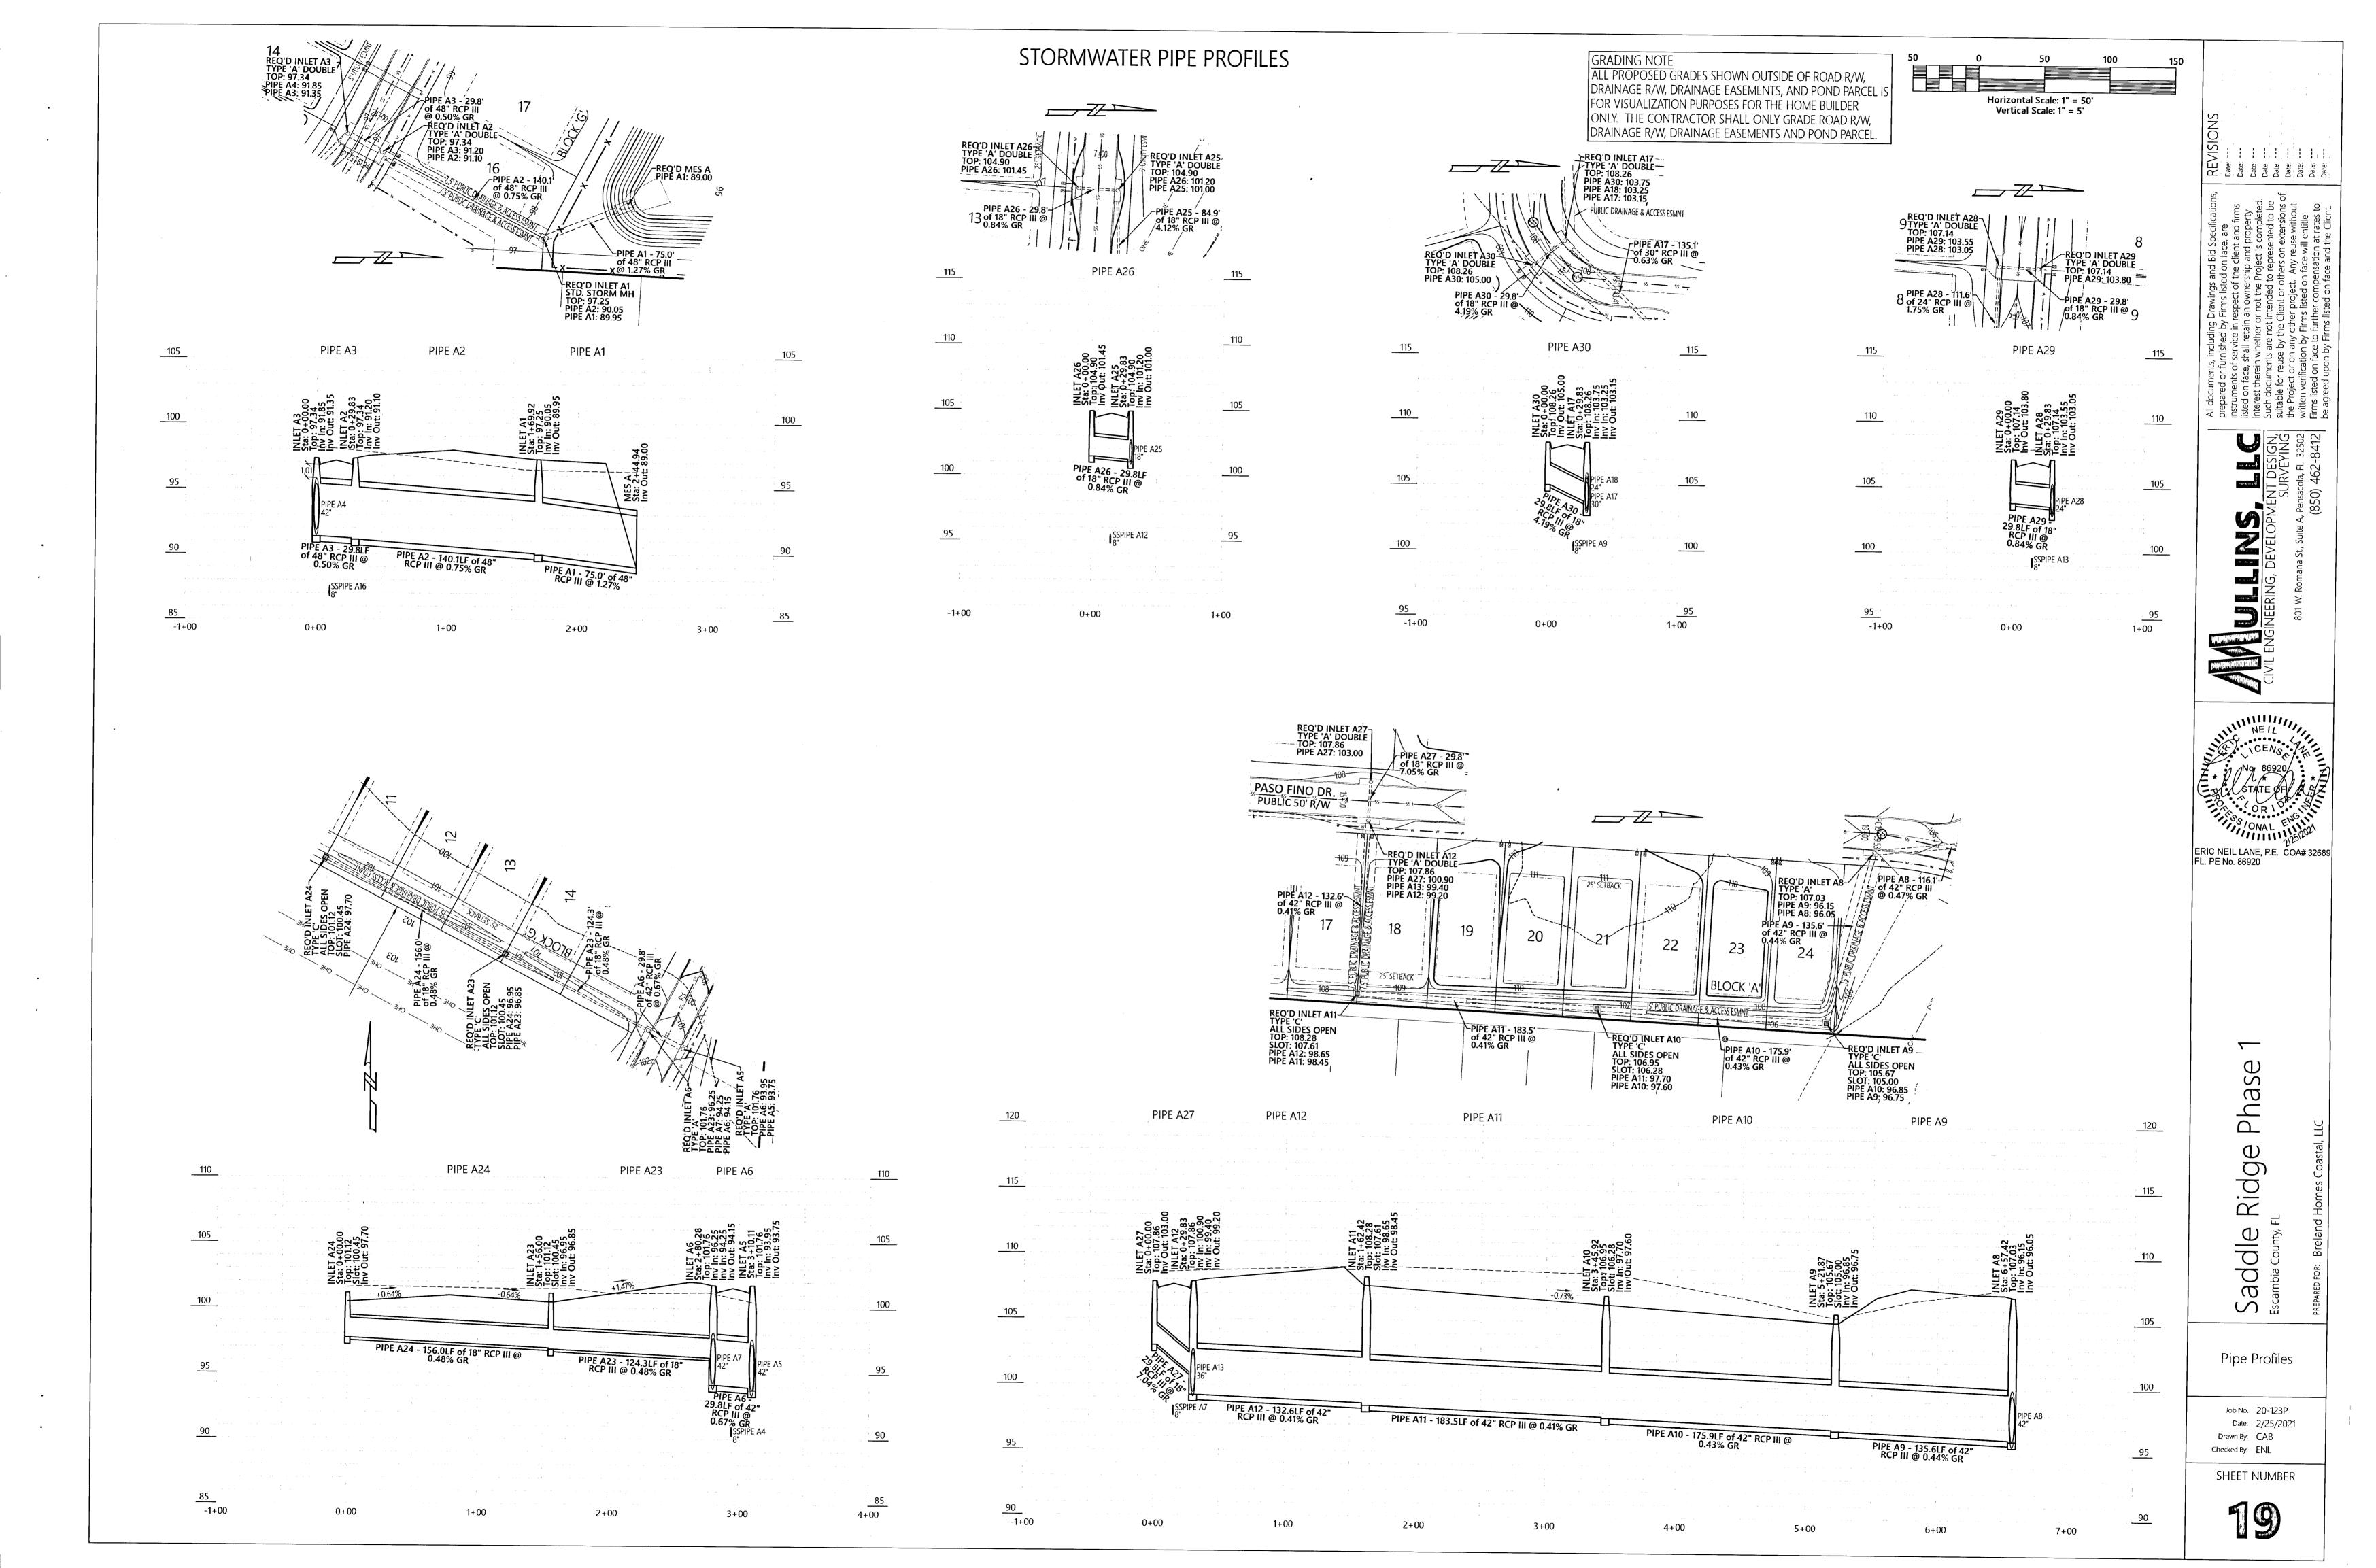
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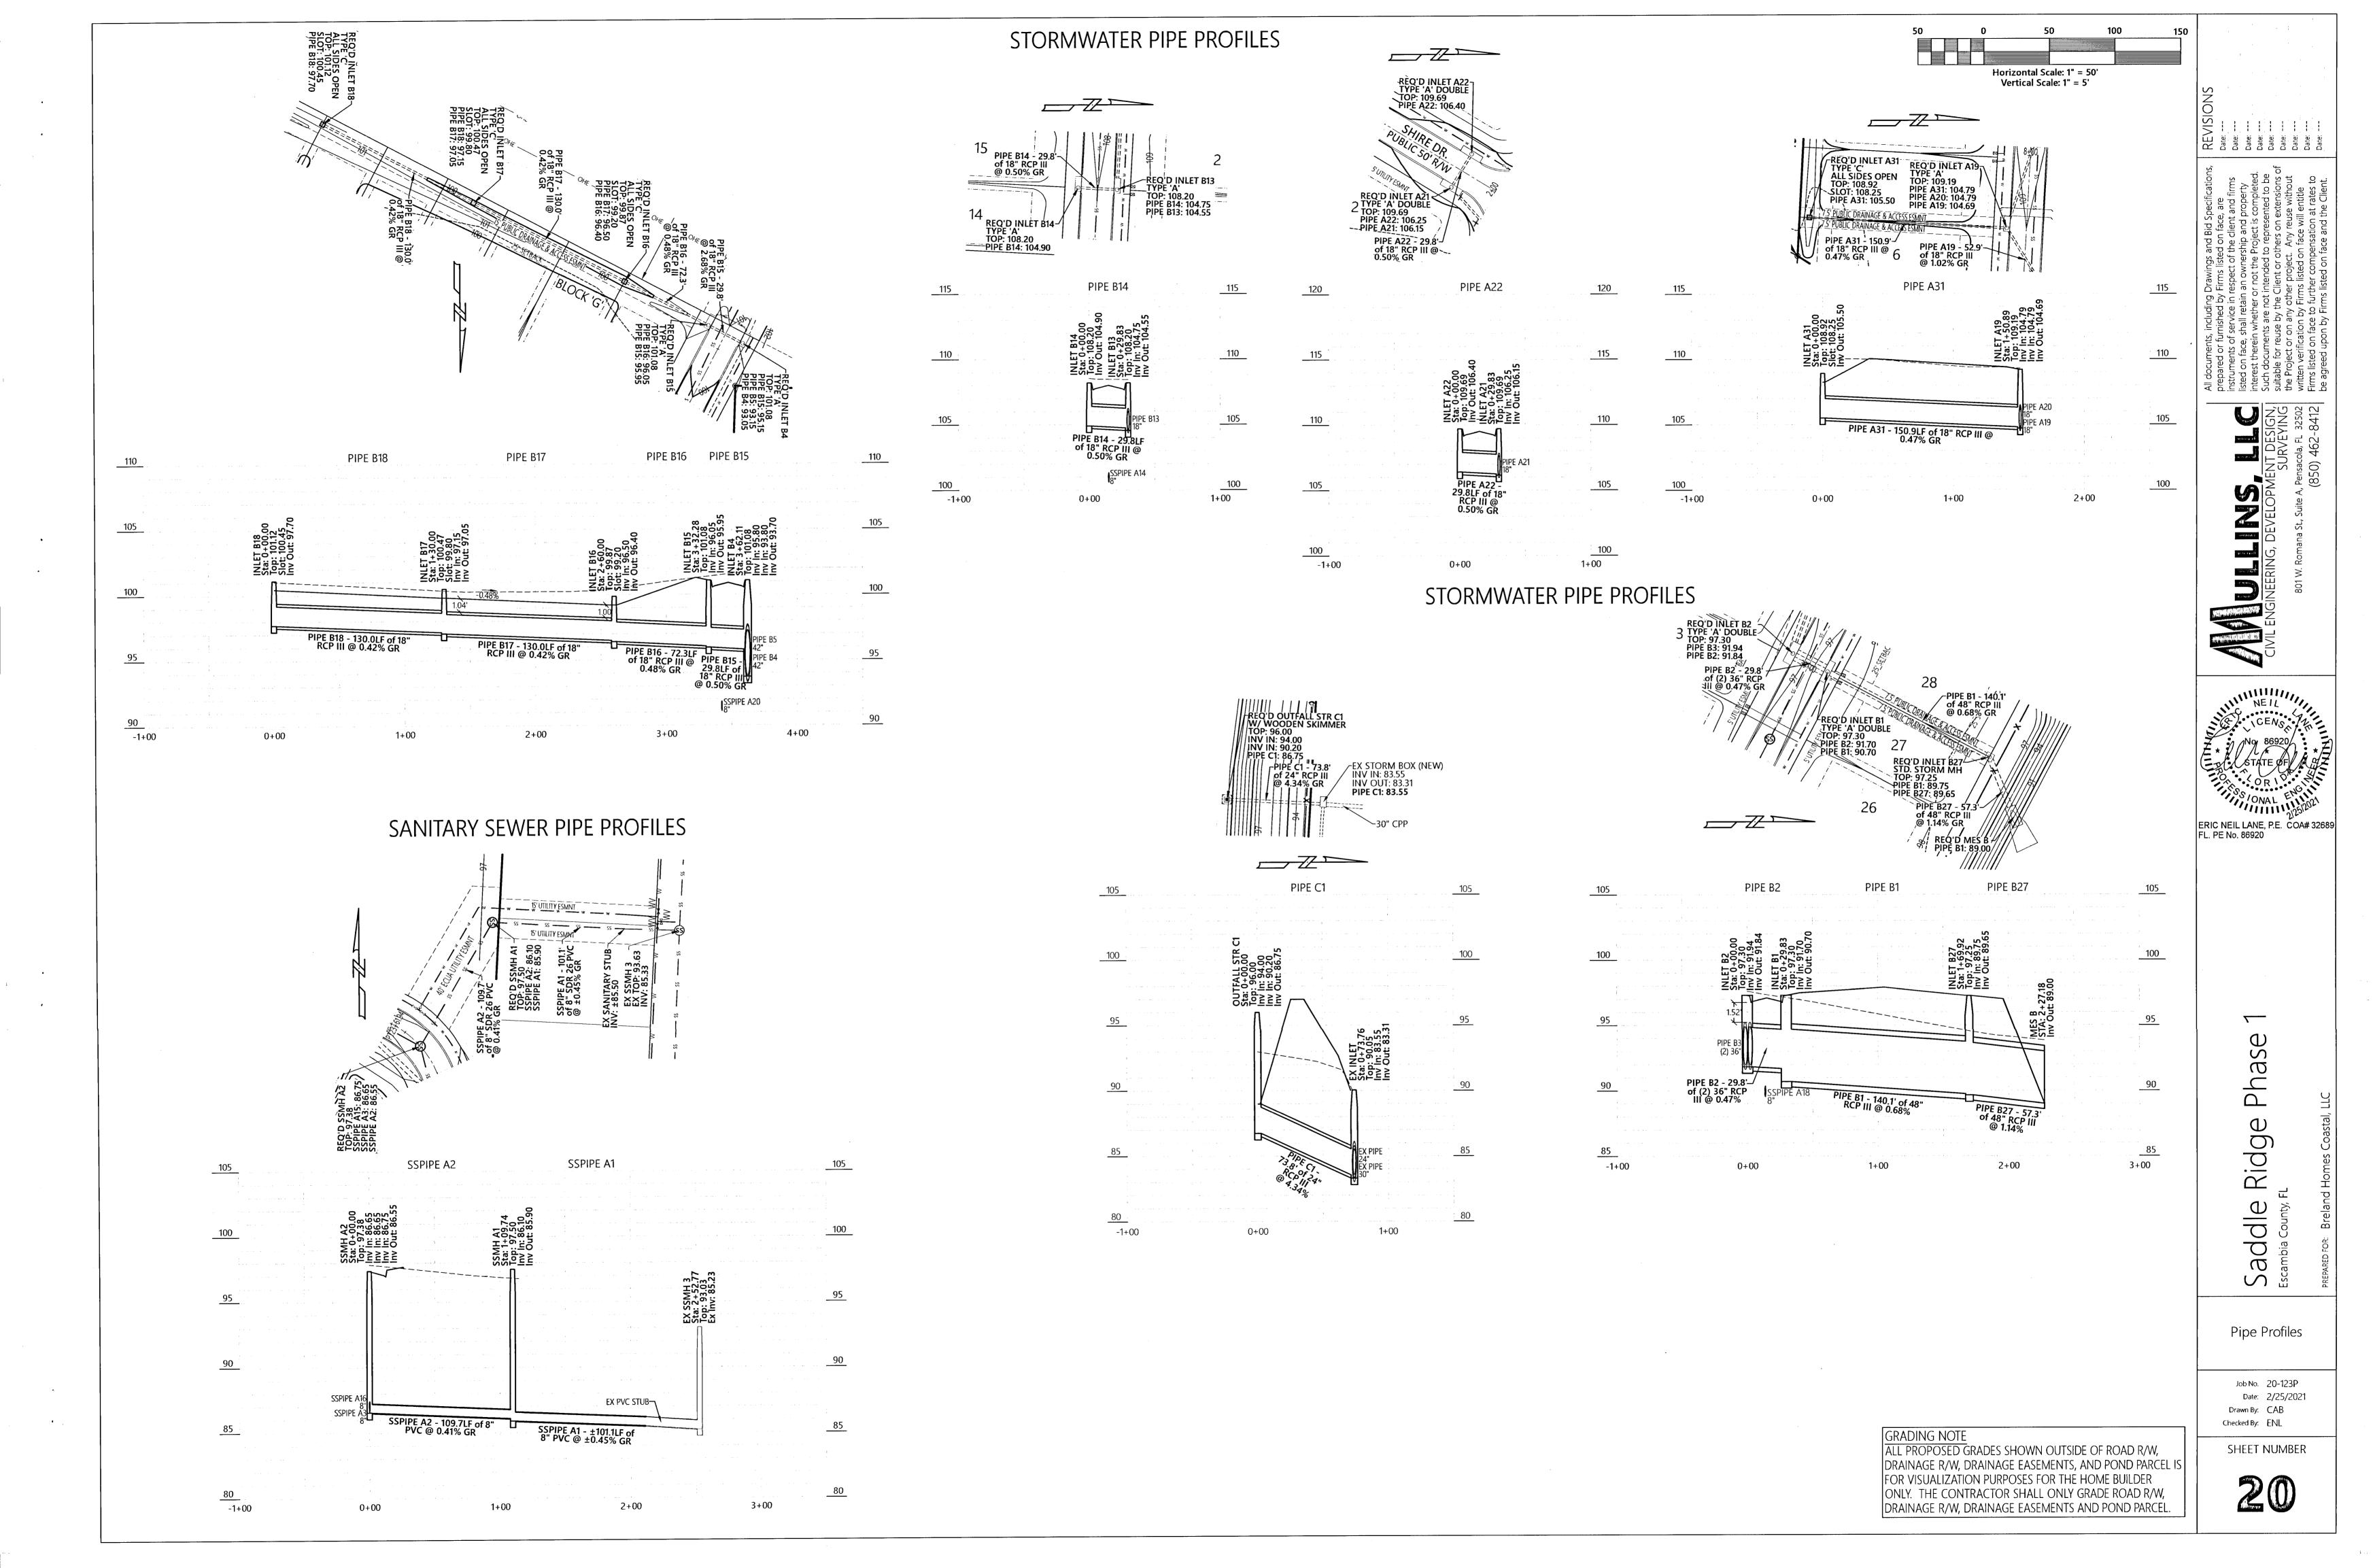
Percheron Dr. Plan & Profile

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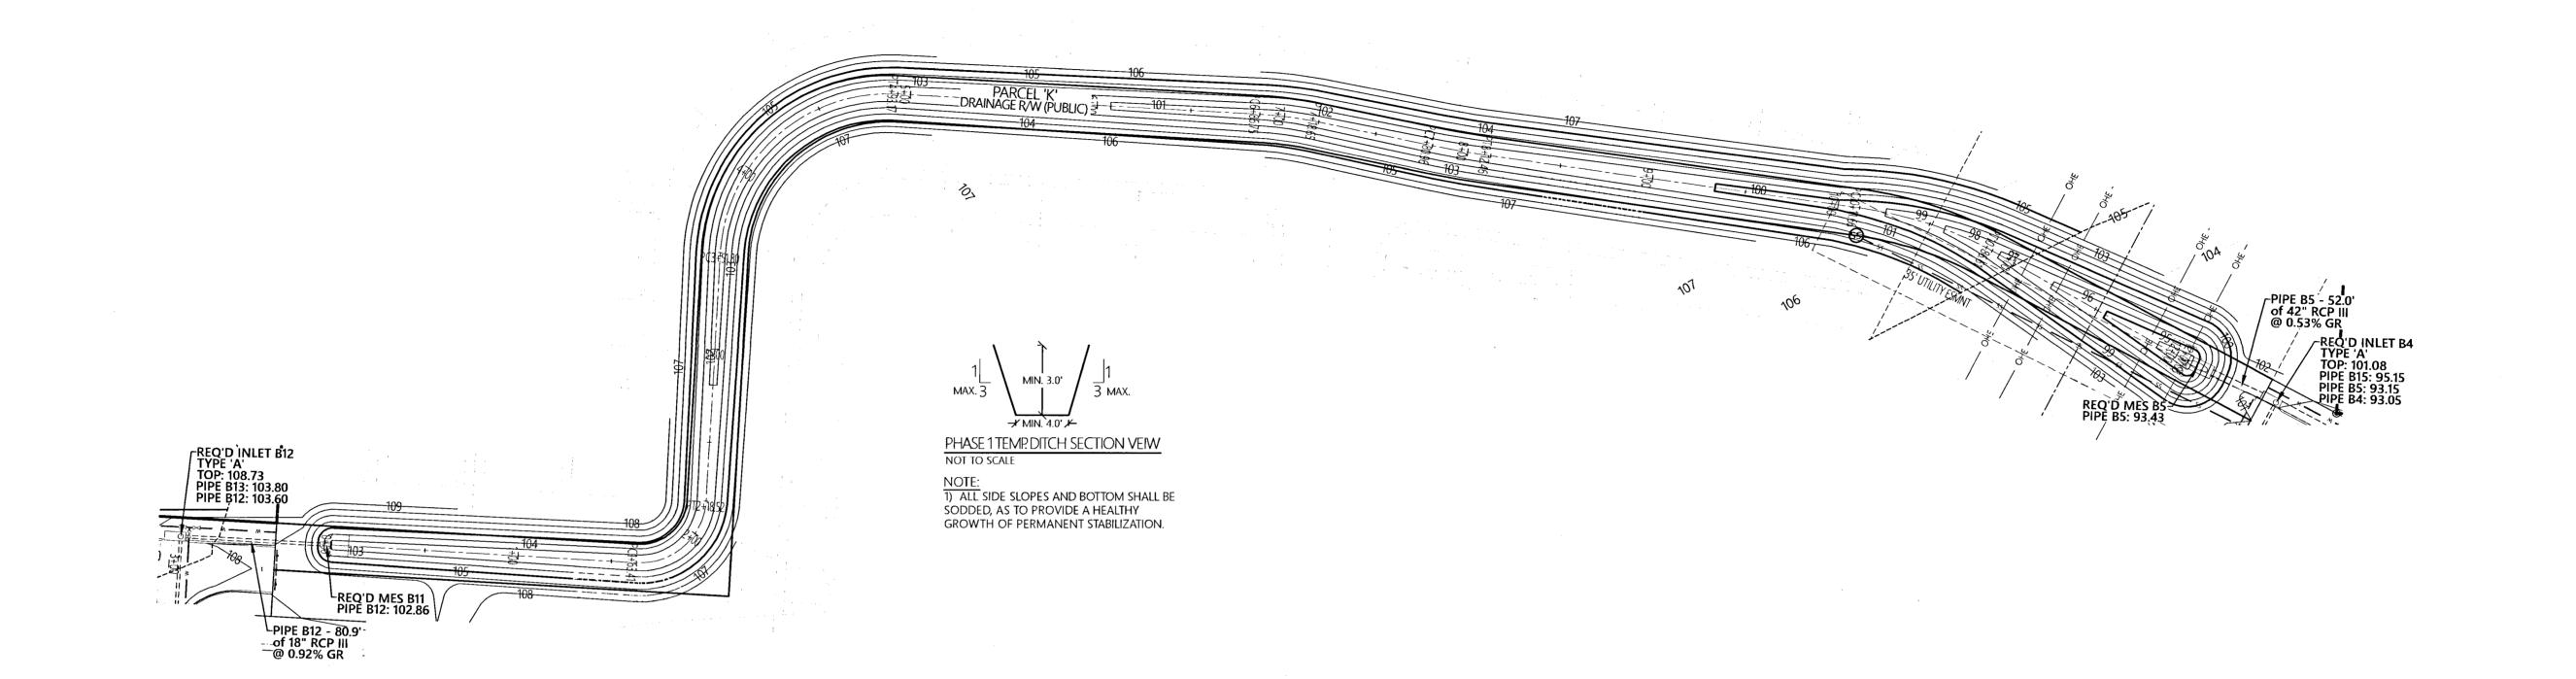
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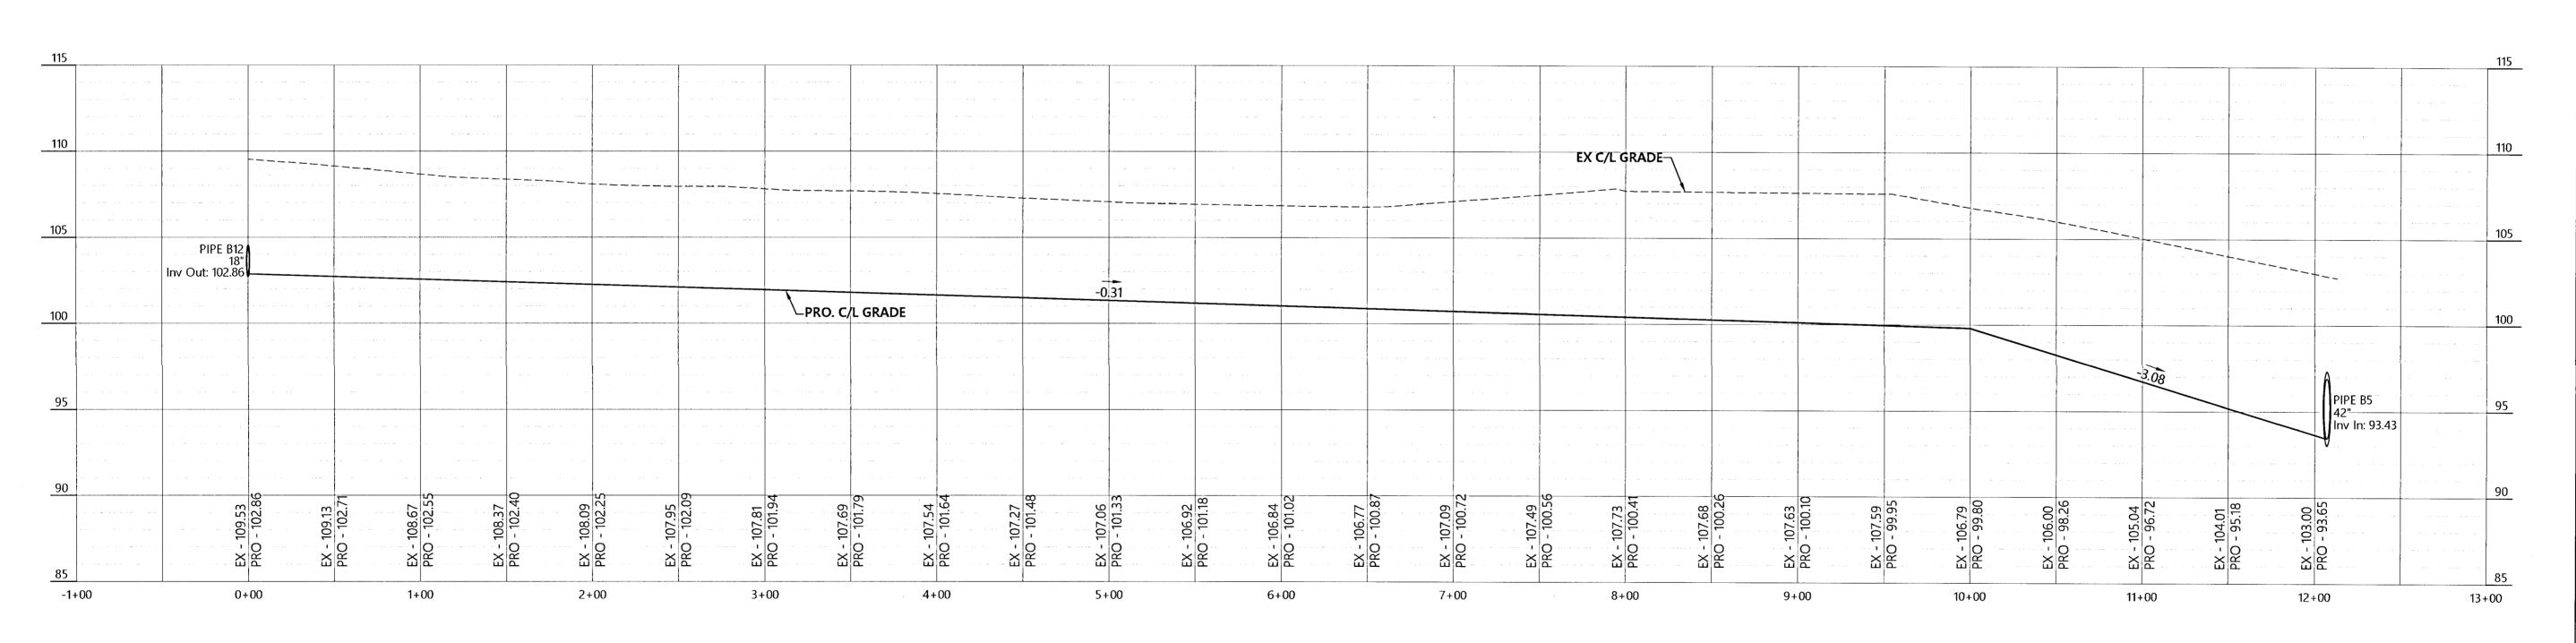
GRADING NOTE
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DRAINAGE R/W, DRAINAGE EASEMENTS AND POND PARCEL.





PHASE 1 TEMPORARY DITCH PROFILE





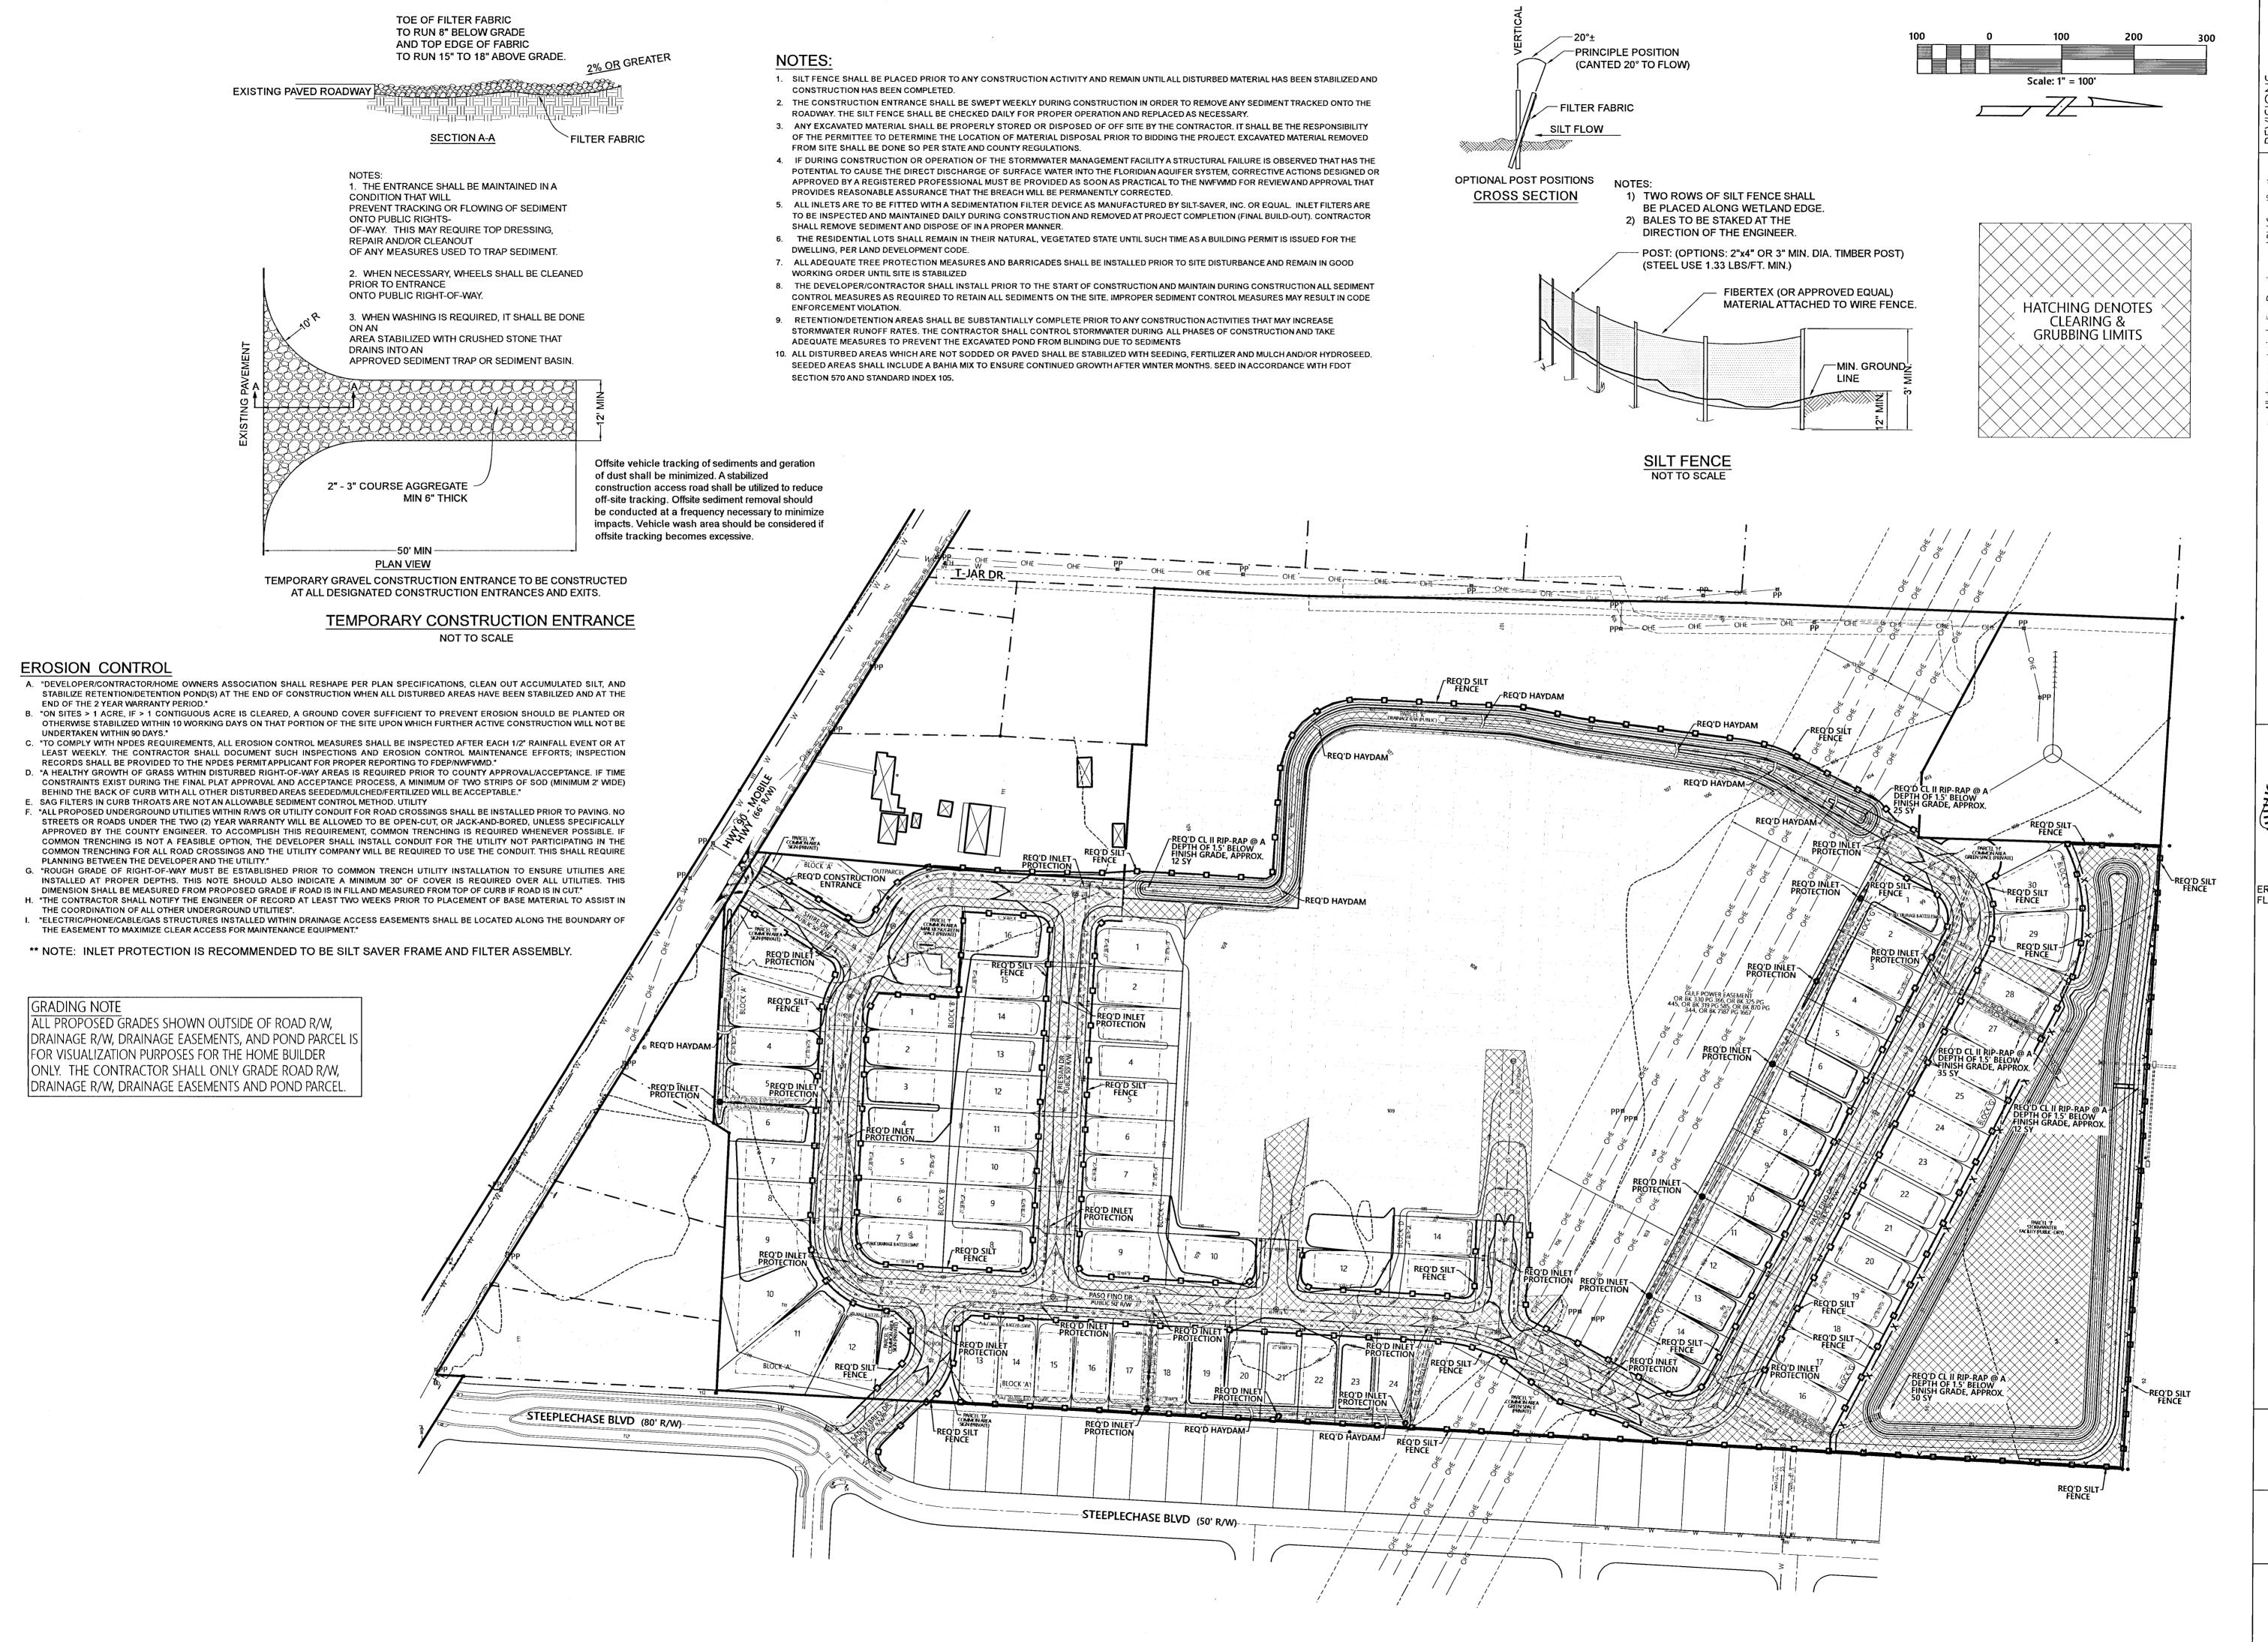
GRADING NOTE
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2/25/2021 ERIC NEIL LANE, P.E. COA# 32689 FL. PE No. 86920

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Instruments of service instruments of service instead on face, shall retainterest therein whether suitable for reuse by the Project or on any owitten verification by Firms listed on face to f

CIVIL ENGINEERING, DEVELOPMENT I SUR 801 W. Romana St., Suite A, Pensacola

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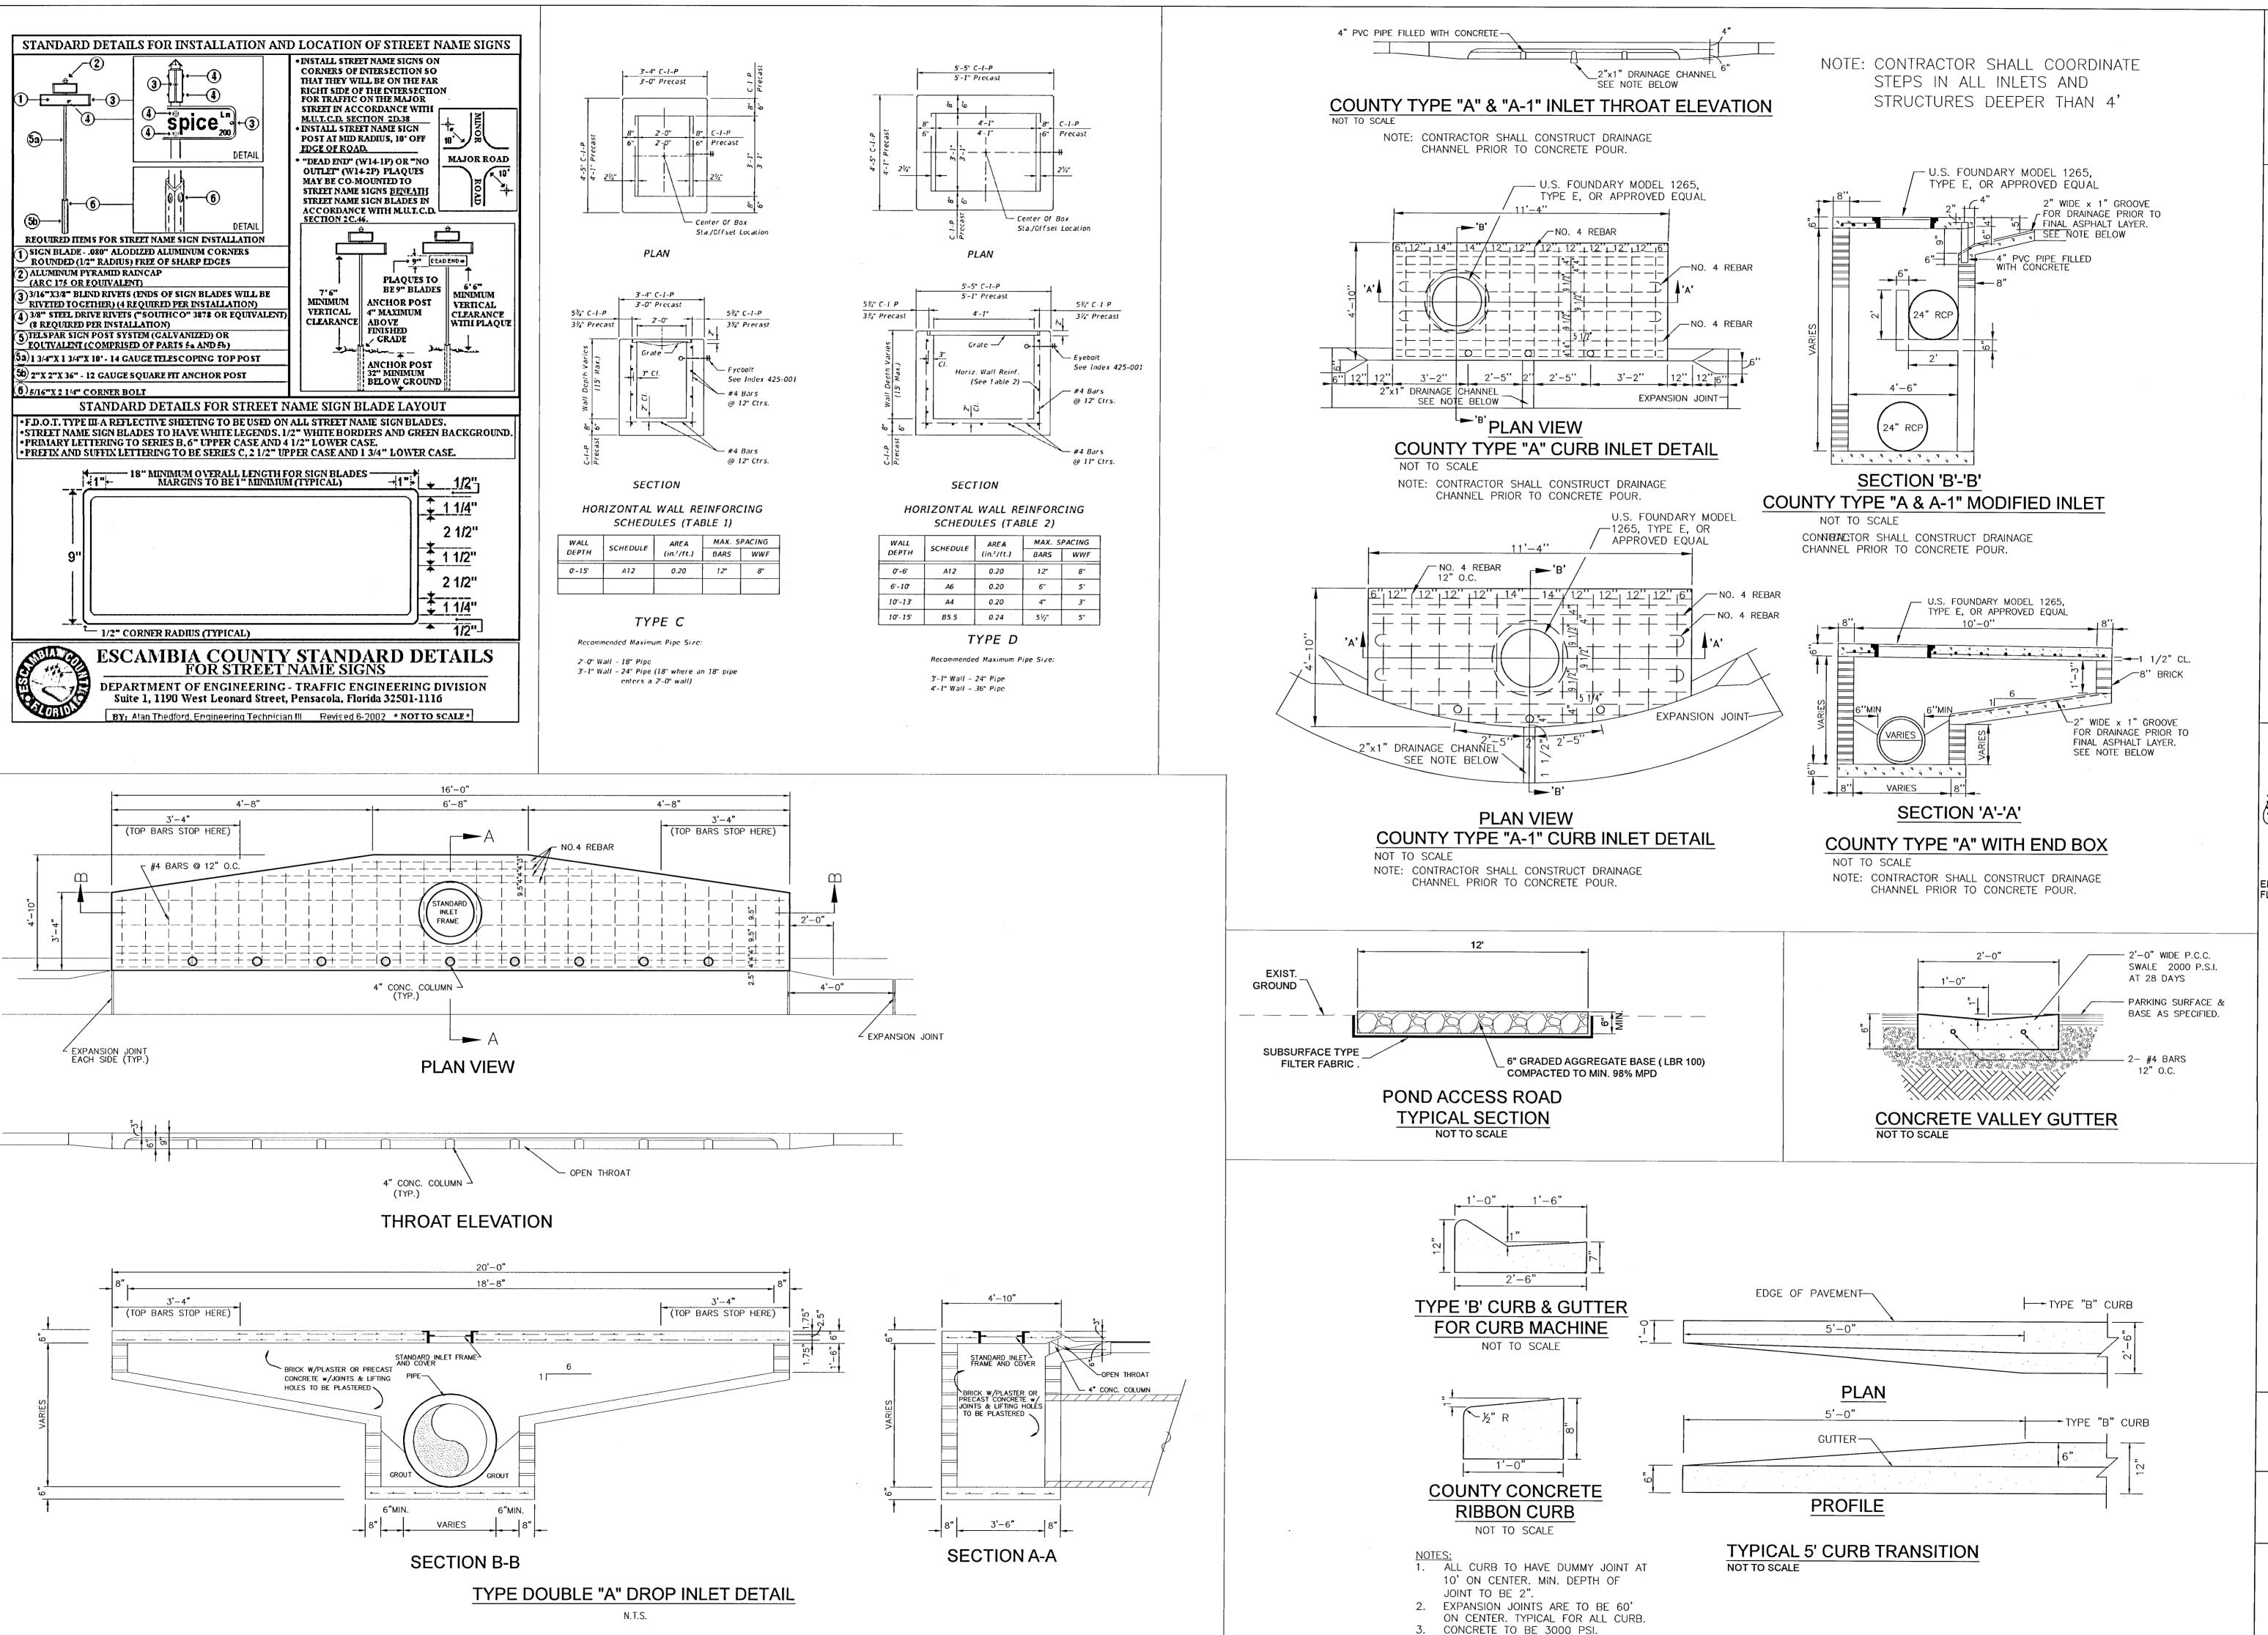
Erosion Control Plan

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Job No. 20-123P
Date: 2/25/2021
Drawn By: CAB
Checked By: ENL

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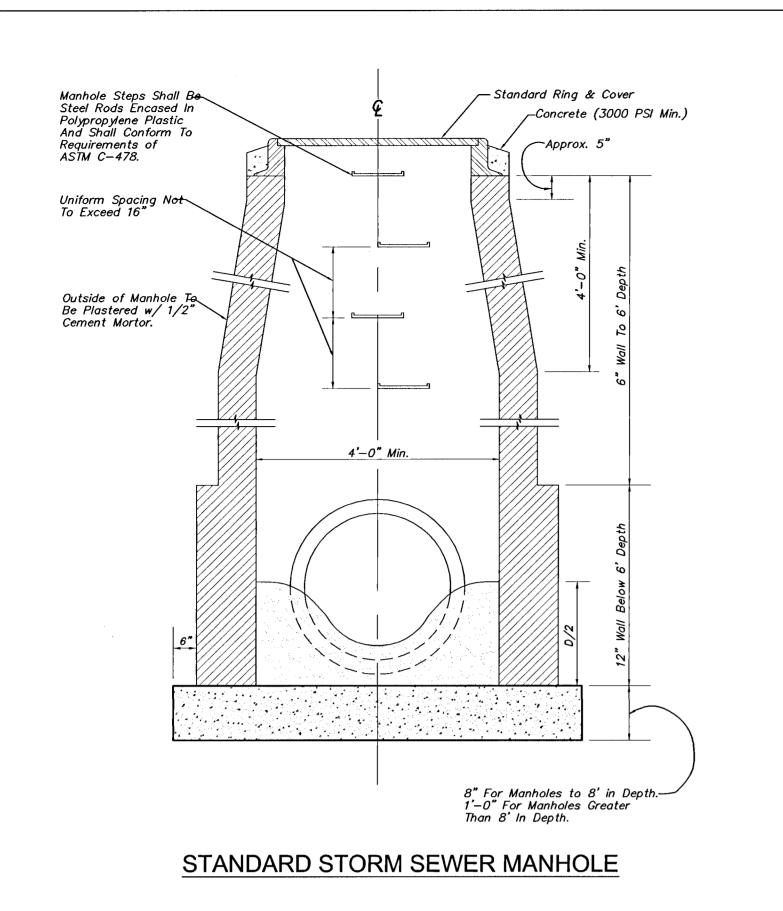
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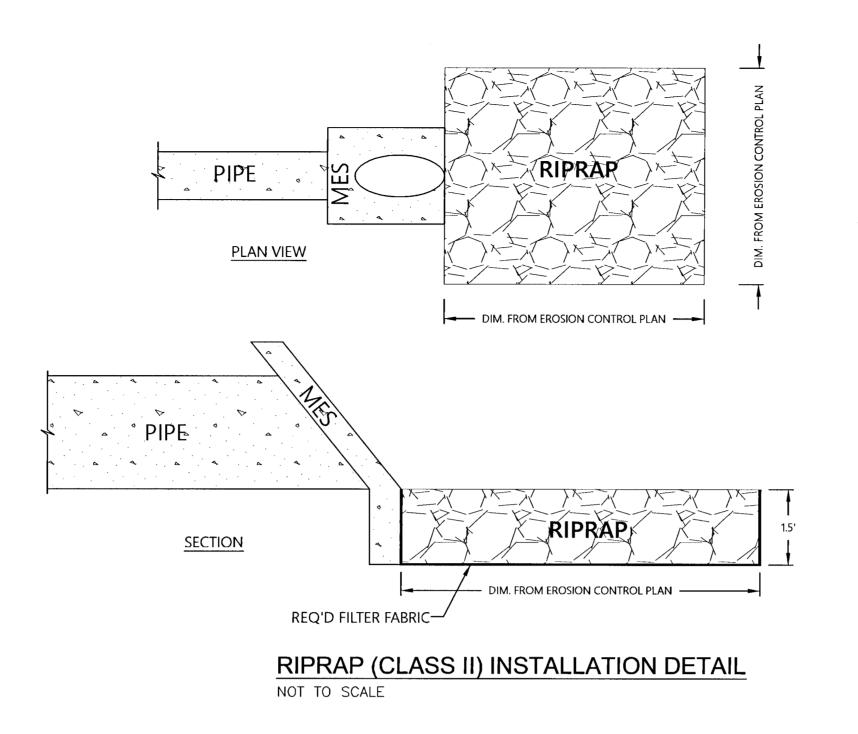
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GENERAL NOTES

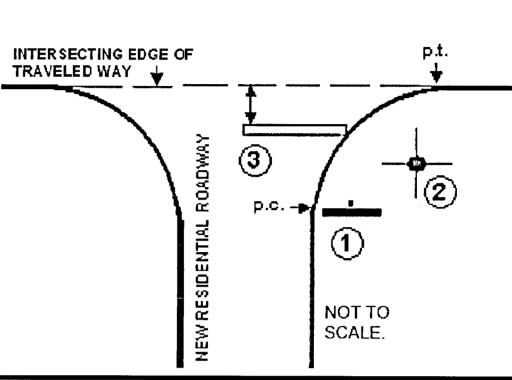
- ALL SIGN INSTALLATIONS MUST COMPLY WITH THE LATEST MANUAL ON UNIFORM TRAFFIC CONTROL DEVICES (M.U.T.C.D.) SPECIFICATIONS.
- ALL PAVEMENT MARKINGS MUST BE THERMOPLASTIC AND COMPLY WITH SECTION 711 OF F.D.O.T.'s STANDARD SPECIFICATIONS FOR ROAD AND BRIDGE CONSTRUCTION.
- STOP BAR APPLICATION IS NOT REQUIRED AT THE INTERSECTION OF TWO RESIDENTIAL ROADWAYS AND / OR ROADWAYS LOCATED WITHIN INTERIORS OF A SUBDIVISION UNLESS SPECIFICALLY NOTED OTHERWISE.

(1) STOP SIGN

SIGN PLACEMENT: LOCATE SIGN ADJACENT TO POINT OF CURVATURE (p.c.) OF CURBING OR EDGE OF ASPHALT TURN OUT. LATERAL CLEARANCE (W / CURB): NO PART OF SIGN ASSEMBLY SHALL BE LESS THAN 1 FOOT FROM BACK OF CURB (EXCLUDES RIBBON CURB).

LATERAL CLEARANCE WITHOUT CURB: NO PART OF SIGN ASSEMBLY SHALL BELESS THAN 6 FROM EDGE OF ASPHALT (INCLUDES RIBBON CURB). VERTICAL CLEARANCE: SIGN SHALL DISPLAY A MINIMUM VERTICAL CLEARANCE OF 7 FEET (MEASURED FROM BOTTOM OF SIGN BLADE TO LEVEL OF ADJACENT ROADWAY).

NEW / EXISTING THROUGH ROADWAY



(2) STREET NAME SIGN

SIGN PLACEMENT: LOCATE STREET NAME SIGN AT MID-RADIUS POINT OF TURN OUT ON SAME SIDE OF STREET AS STOP SIGN. NOTE: SEE ESCAMBIA COUNTY STANDARD DETAILS FOR STREET NAME SIGNS FOR FURTHER FABRICATION, LOCATION AND INSTALLATION REQUIREMENTS

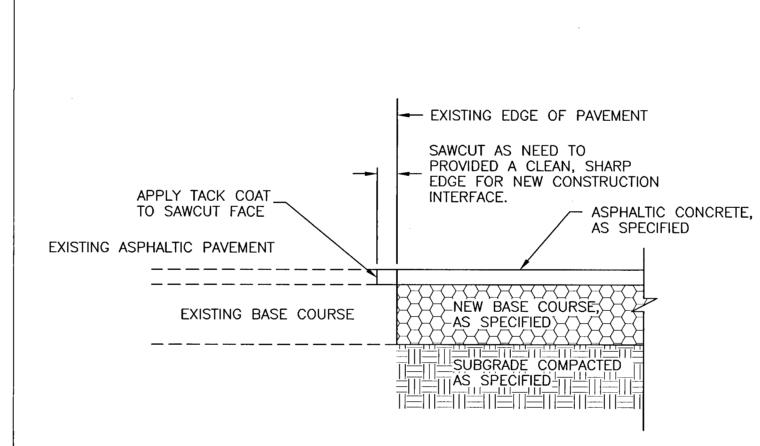
(3) <u>24"STOP BAR</u>

OPTIONAL (SEE GEN. NOTE #3)

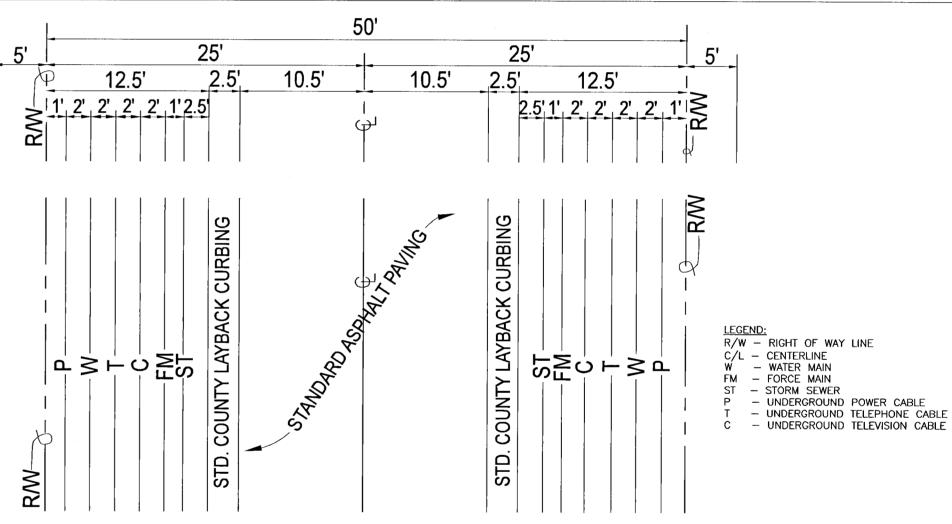
PLACEMENT: LEADING EDGE OF STOP BAR CANNOT BE LESS THAN 4 FEET IN ADVANCE OF INTERSECTING EDGE OF TRAVELED WAY OR MARKED / UNMARKED CROSSWALK, STOP BAR MUST BE LOCATED AS TO PROMDE ADEQUATE INTERSECTION SIGHT DISTANCE PER F.D.O T 's DESIGN STANDARDS INDEX # 546.

INSTALLATION DETAILS

TRAFFIC CONTROL SIGNS & MARKINGS FOR NEW RESIDENTIAL INTERSECTIONS ACCEPTABLE PER CURRENT ESCAMBIA COUNTY INSPECTION PRACTICES



NEW/EXISTING PAVEMENT INTERFACE NOT TO SCALE



COMMON TRENCH & UTILITY LOCATIONS TYPICAL ROAD PLAN VIEW

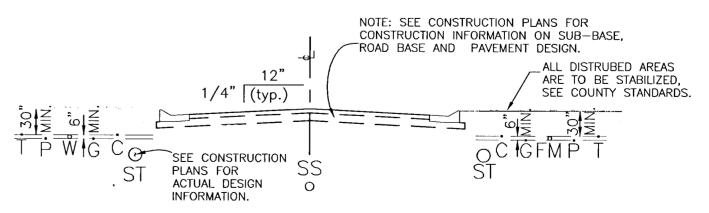
NOT TO SCALE

1) THIS IS A TYPICAL LOCATION PLAN. SEE CONSTRUCTION PLANS TO DETERMINE WHICH SIDE OF THE RW ACTUALLY RECEIVES UTILITIES. SOME UTILITIES MAY ONLY BE ON ONE SIDE (I.E. WATER, FORCE MAIN AND STORM SEWER).

2) ALL PROPOSED UNDERGROUND UTILITIES WITHIN RAW'S OR UTILITY CONDUIT FOR ROAD CROSSINGS SHALL BE INSTALLED PRIOR TO PAVING. NO STREETS OR ROADS UNDER THE TWO (2) YEAR WARRANTY WILL BE ALLOWED TO BE OPEN CUT, OR JACK-AND-BORED. TO ACCOMPLISH THIS REQUIREMENT, COMMON TRENCHING IS REQUIRED WHENEVER POSSIBLE. IF COMMON IS NOT FEASIBLE OPTION, THE DEVELOPER SHALL INSTALL CONDUIT FOR THE UTILITY NOT PARTICIPATING IN THE COMMON TRENCHING FOR ALL ROAD CROSSINGS AND THE UTILITY COMPANY SHALL BE REQUIRED TO USE THE CONDUIT.

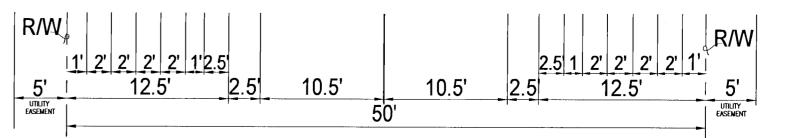
3) ALL R/W CONSTRUCTION WORK SHALL COMPLY WITH ESCAMBIA COUNTY TECHNICAL SPECIFICATIONS.

4) CONTRACTORS SHALL INSTALL EACH UTILITY SERVICE IN THE LOCATION AS SHOWN IN THE COMMON TRENCH DETAIL.



COMMON TRENCH & UTILITY LOCATIONS TYPICAL ROAD CROSS SECTION

NOT TO SCALE



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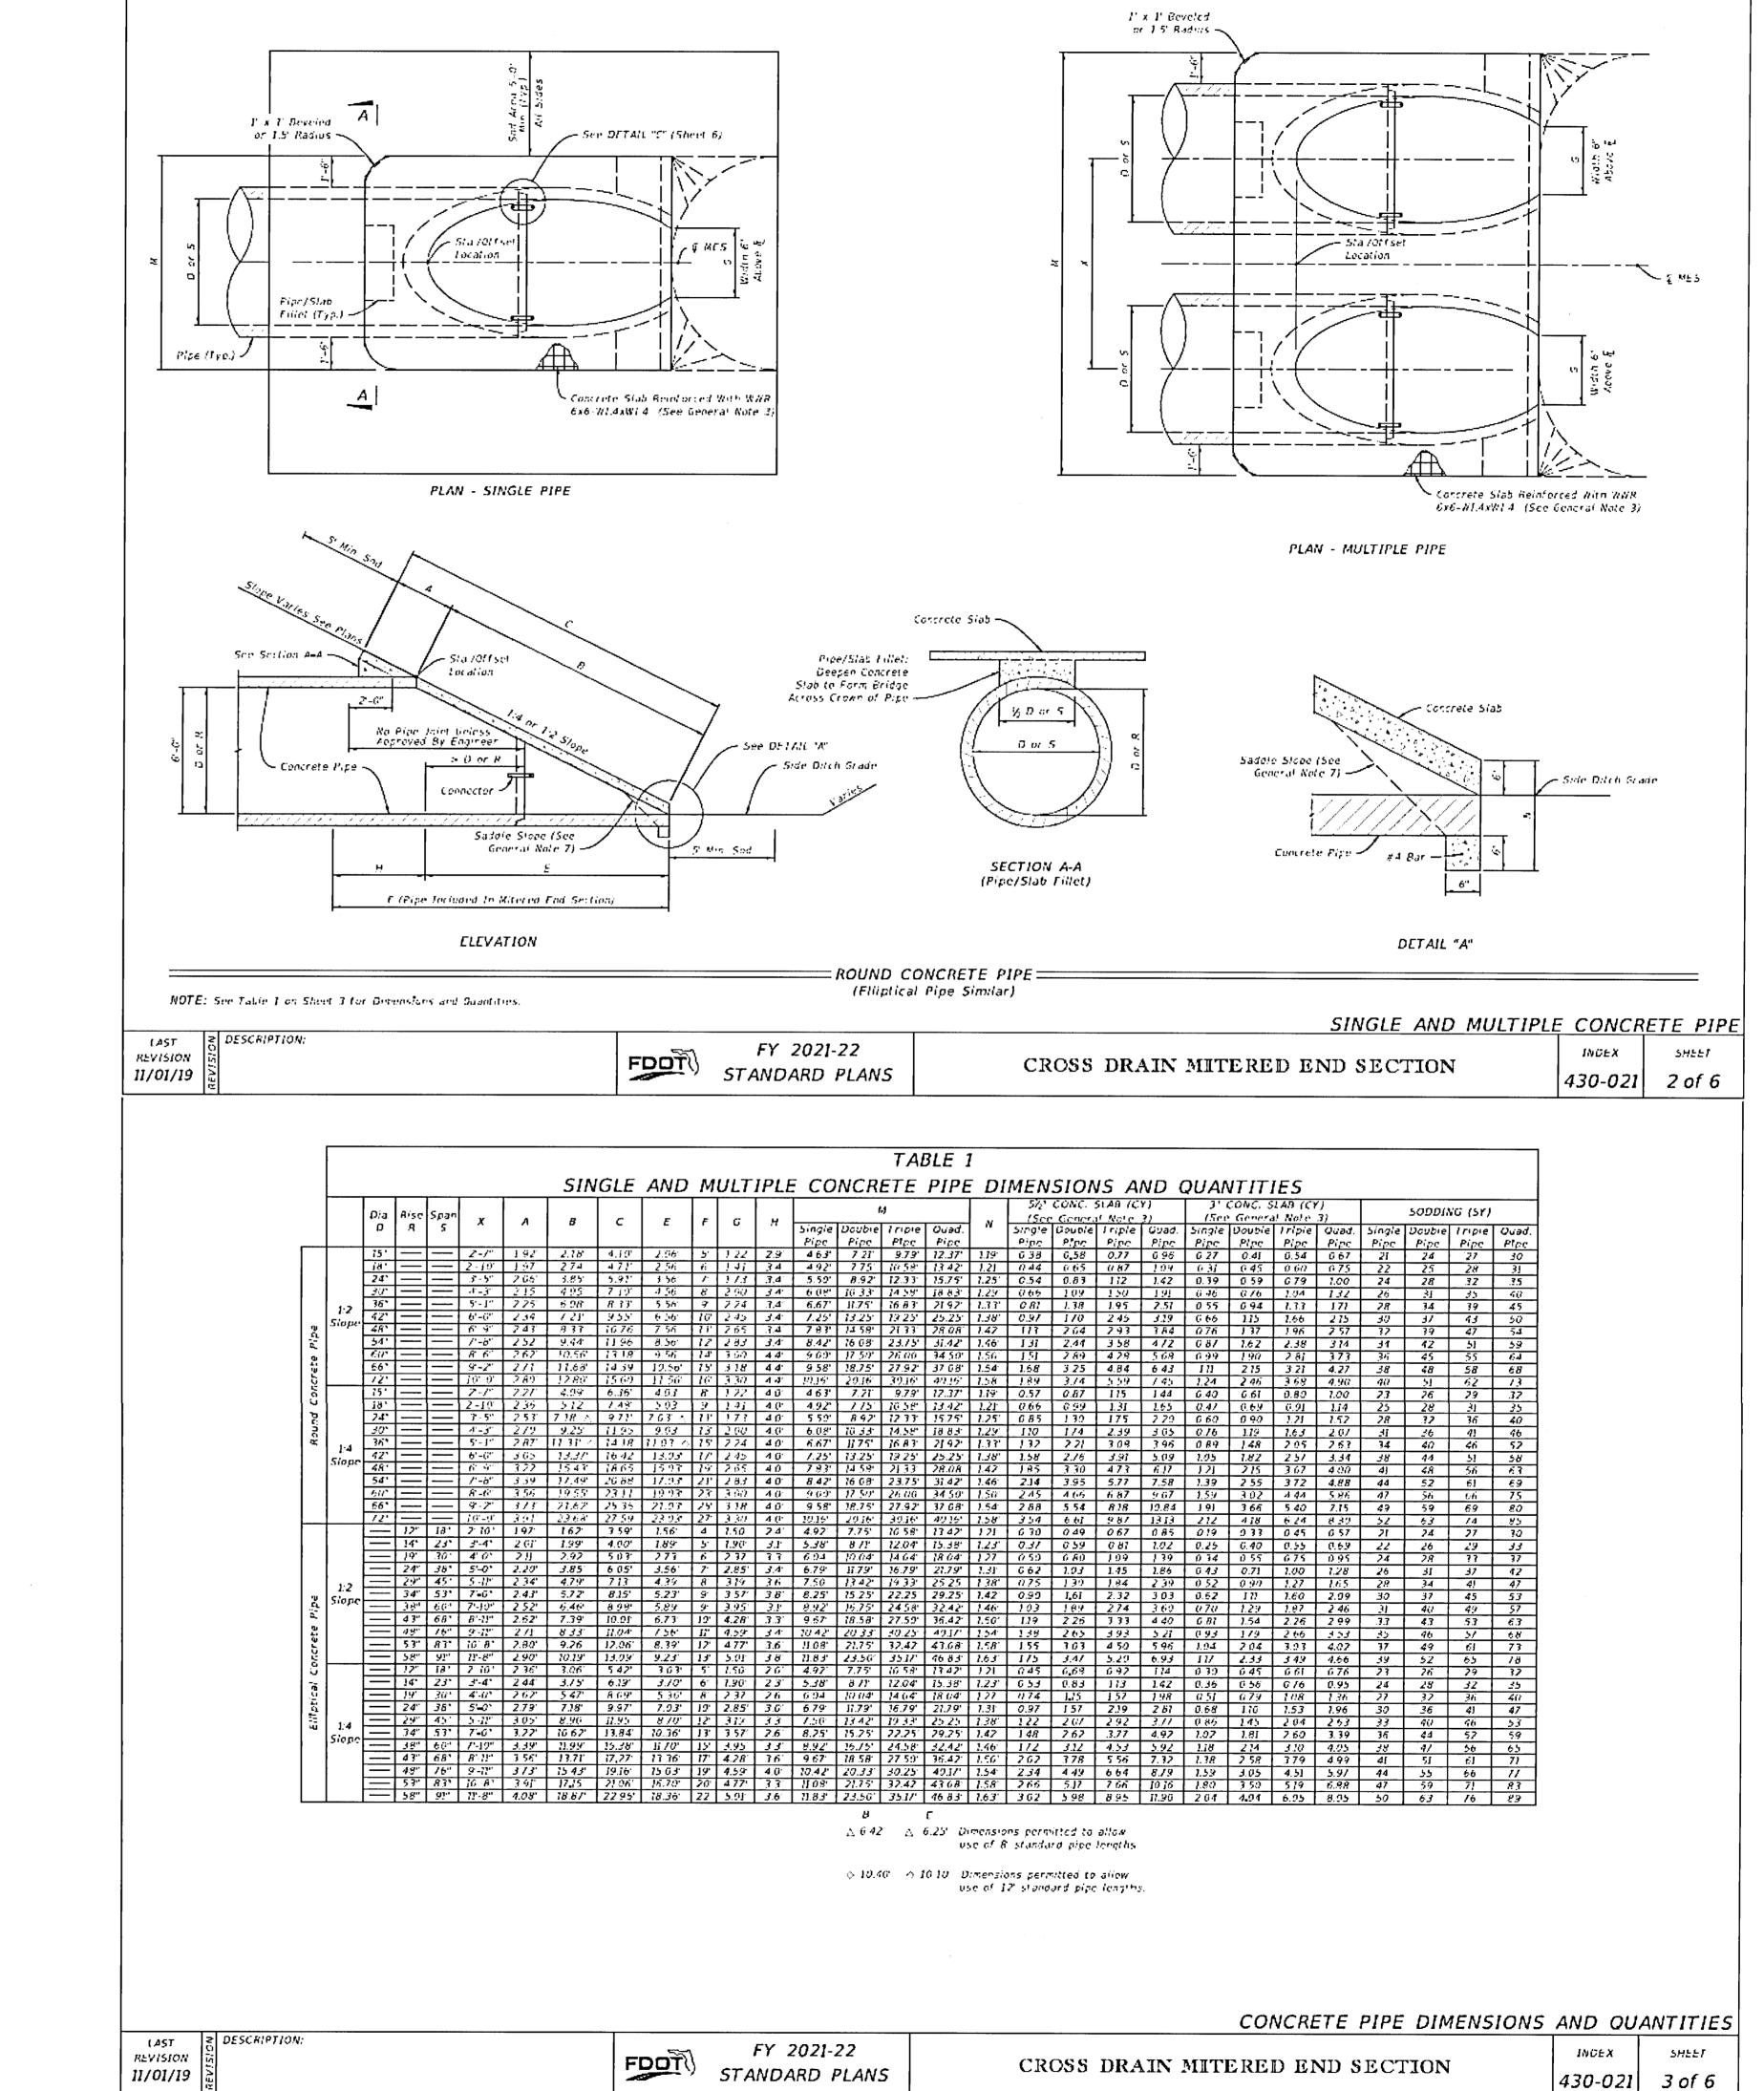
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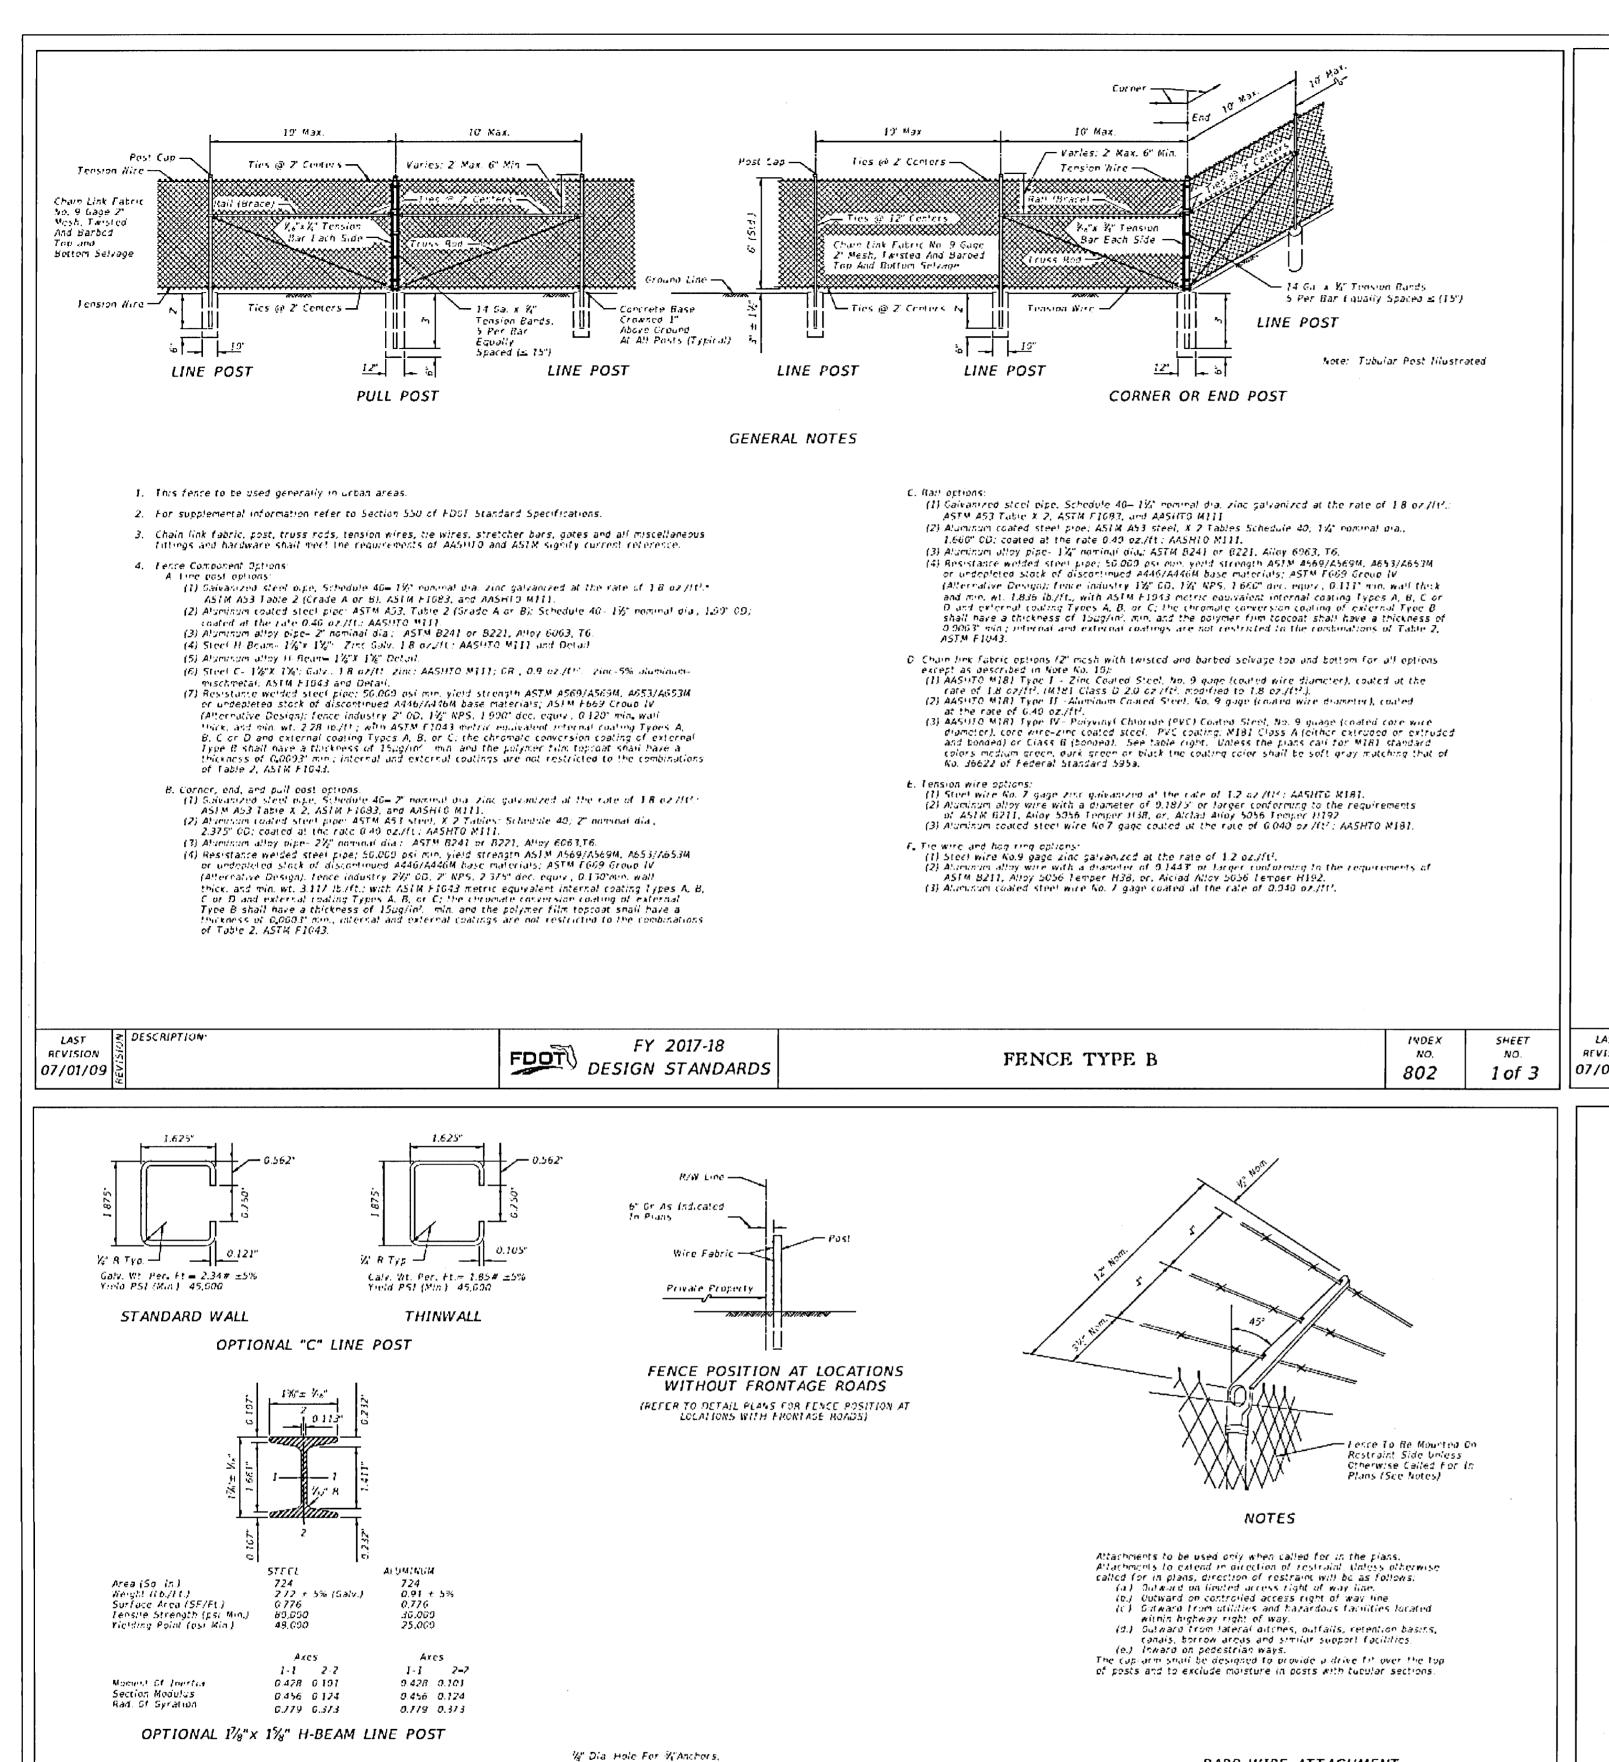
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Nots And Washers (2 Regd.) -

TWO ANCHOR PLATE OPTION

FY 2017-18

FDOT DESIGN STANDARDS

. € Fence And Wall

— Steel - V/ 및 (ASTM A36) Galvanized or :

Aluminum W. A Alloy 6061-16

FENCE MOUNTING ON CONCRETE ENDWALL AND RETAINING WALLS

– Steel ¾: 凡 (ASTM A36) Galvanized or

- %& Dia. Hale For

Note And Washers

- \$ Force And Wall

(4 Keqd.)

16' Galvanized Anchors,

Aluminum & R Alley 6061-T6

Dimensions Same

TOP VIEW

FOUR ANCHOR PLATE OPTION

DESCRIPTION

LAST

REVISION

07/01/09

BARB WIRE ATTACHMENT

1. Base plate identical for line, pull, end and corner posts and shall be

2. Post to be plumbed by grout shim under base plate.

Headed Bolts, 0-Bolts or Chaster Plates. 8" Adnesive Aschors, 6" Min. Embeament."

larger in diameter than the anchor boit.

12' Cast In Place, 109/ Embedment

Expansion Bolts Not Permitted.

onsidered an integral part of the respective posts for basis of payment.

Adhesive anchors shall be headless anchor holts set in drilled holes with an Adnesive Material System in accordance with -

SHEET

3 of 3

NO.

802

Specification Sections 416 and 937; drifted holes shall be "4"

BASE PLATE AND ANCHOR NOTES.

3. Anchors (Galvanized Steel):

FENCE TYPE B

GENERAL NOTES CONTINUED

- Objects a specific material is called for in the plans the Contractor may elect to use either a single type of material or a combination of material types from the component options listed in note 4. Combinations of optional materials are restricted as follows:

 (a) Only one fabric optional material will be permitted between corner and/or end post assemblies.

 (b) Only one line post optional material will be permitted between corner and/or end post assemblies. (t) Pull post assemblies shall be optional materials identical to either the linepost optional material or the corner and end post assembly optional material, but, pull post assemblies shall be the same optional material between any set of corner and/or end post assemblies
- 6. Concrete for Lases shall be Class NS concrete as specified in Section 347 of the Standard Specifications. or a packaged, dry material meeting the requirements of a concrete under ASTM C-387. Materials for Class NS concrete may be proportioned by volume and/or by weight
- 7. The post shall be 8'-6" long (Standard). The post are to be set in concrete as described above or
- (b) Inspectedance with ASIM F367 Subsections 5.4 through 5.10 as approved by the Engineer.
 Line past installed in accordance with Section 5.8 shall be 9-6" long.
 (c) Post mounted on concrete structure or solid rock shall be mounted in accordance with the base. place detail "Fence Mounting On Concrete Endwalls And Retaining Wall", Sheet 3; or, by embedment in accordance with ASTM 1567 Subsection 5.5.

(a) In accordance with special details and/or as specifically described in the contract plans and

- End, pull and corner past assembles shall be in concrete as detailed above for all sail conditions other than solid rock. Post within assemblies that are located on concrete structures or solid rock shall be set by base place of by embedment as prescribed under (b) above for line post
- Time and assembly posts for θ tence which must be lengthered due to a variation in the normal ground clearance, shall be set an additional 3° in depth for each 1° of of additional ground clearance. Pall post shall be used at breaks in vertical grades of 15° or more, or at approximately 350° centers
 except that this maximum interval may be reduced by the Engineer on curves where the curve is
- 9. Corner post are to be installed at all burizontal breaks in tence at 15" or more and as required at vertical
- breaks over 15° as determined by the Engineer. 10. When force has an installed top of fabric height less than 6 knuckled top and bottom selvages shall

posts at the opening. Gates shall be paid for under the contract unit price for Fence Gates, EA.

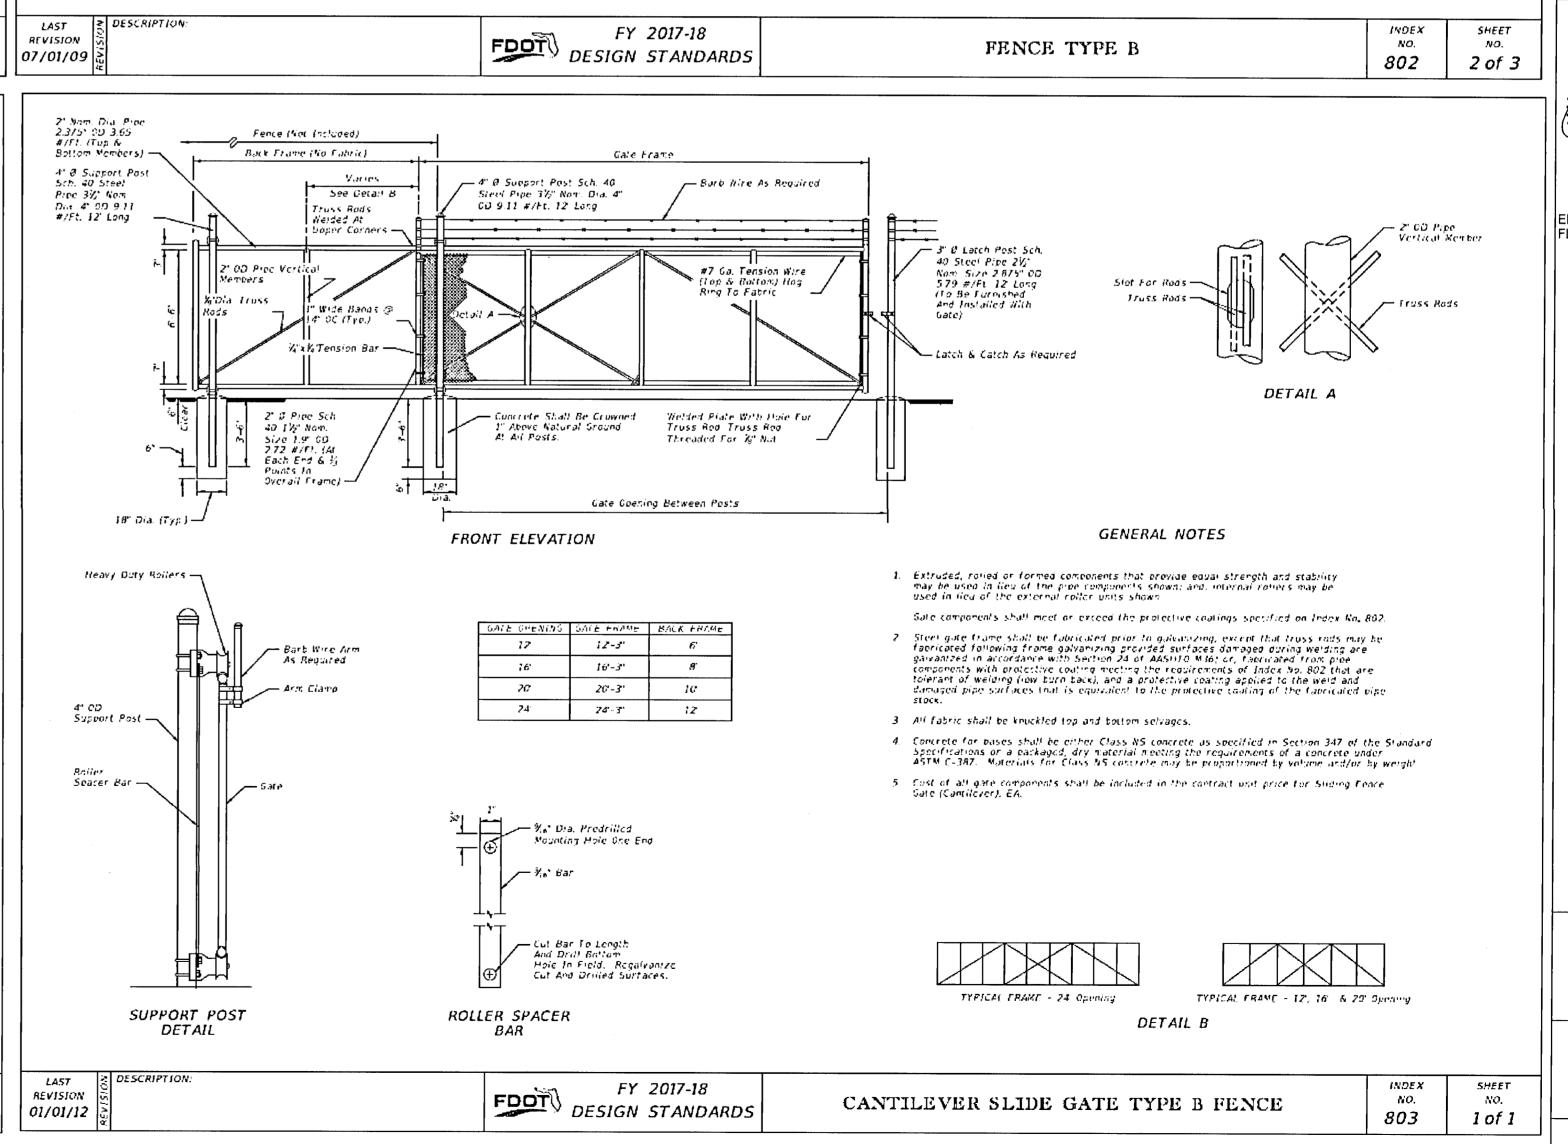
be used unless the plans specifically identify locations for twisted selvage fabrics.

- 11. Onless stiding gates or special gates are called for in the plans, all gates shall be chain link swing gates asserting the material requirements described and as approved by the Engineer, Payment shall nullifie the gates, single or double, all necessary hardware for installation and any additional length and/or size for
- 12. For construction purposes corner post assemblies shall consist of one corner post, two braces, two truss rods and all necessary fillings and hardware as detailed. End post assemblies shall consist of one end post. one brace, one truss rod and all necessary fittings and hardware as detailed.
- 13. In areas where there are physical constraints outside the right-of-way which restricts the fence construction, he labric may be installed on the inside of the posts.

			TYPE	CV VINYC	COATED FABI	RIC		
		AZ	SHTO MIB	1 Toble 4	Redefined A	s Follows		
Specified Diameter St Mutalic Coaled Core Wire					ness Hange			
		Minimum Weight Of Zinc Coating		MIBI Class A (Extrumed Or Extrumed And Bonded Coa(ing)		MIB1 Class B (Bonded Coating)		
15.	ന്ന	quqe	02/117.	9/11/	in	'Al- du	ın.	ews
G 148	3.77	9	0 30	92	0.015 to 0.025	0.38 (0 0.64	0.006 to 0.010	0.15 to 0.25

DESIGN NOTE

This index details feering that is constructed with chain link fabric 6' (commal) in height and with specific ground clearance for tensing of different height or installation details, the tense shall be fully detailed



*** SEE ESCAMBIA COUNTY SPECS FOR SWING GATE OPTION***

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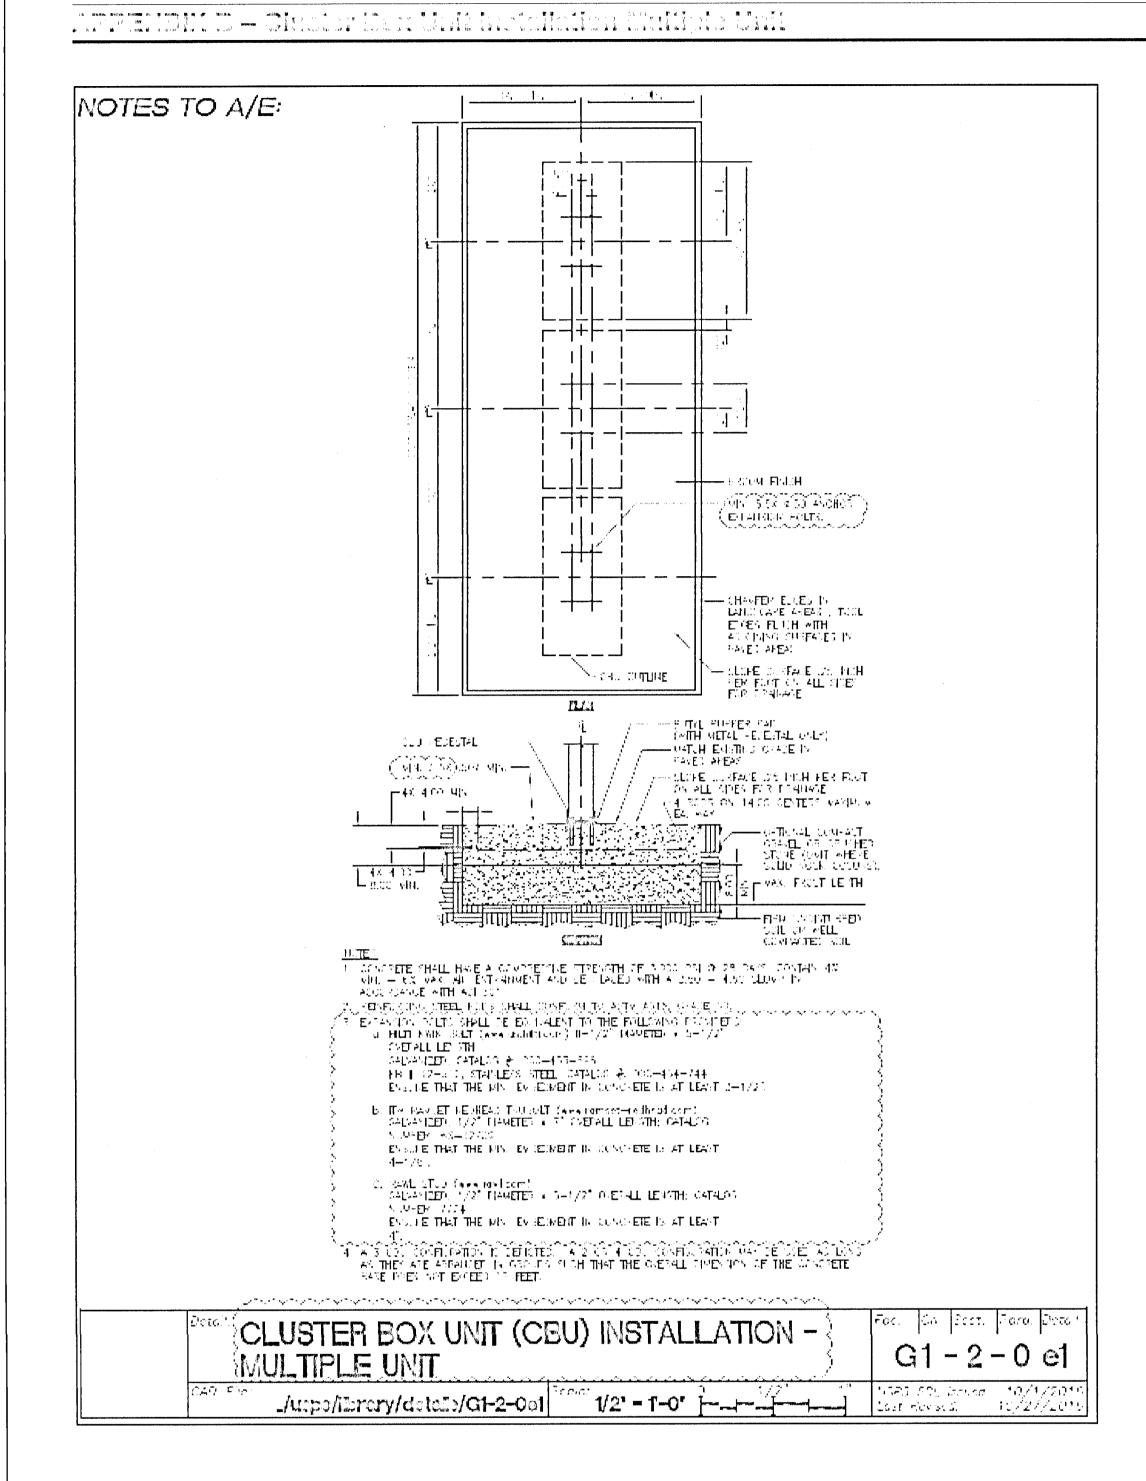
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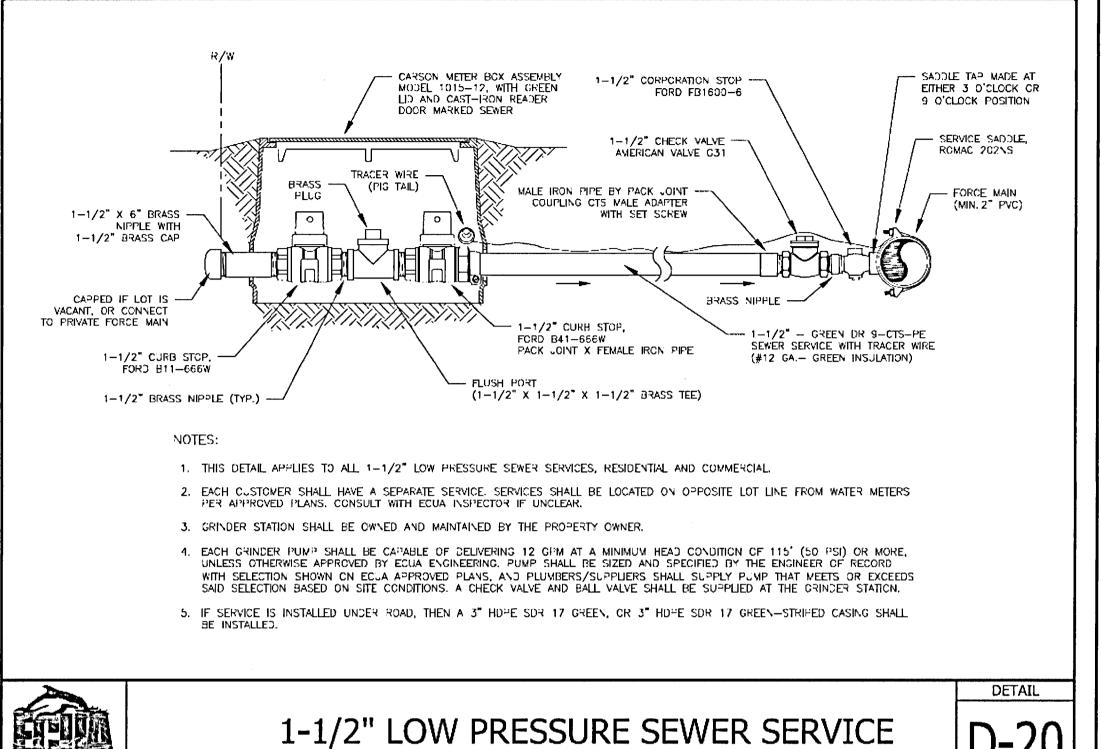
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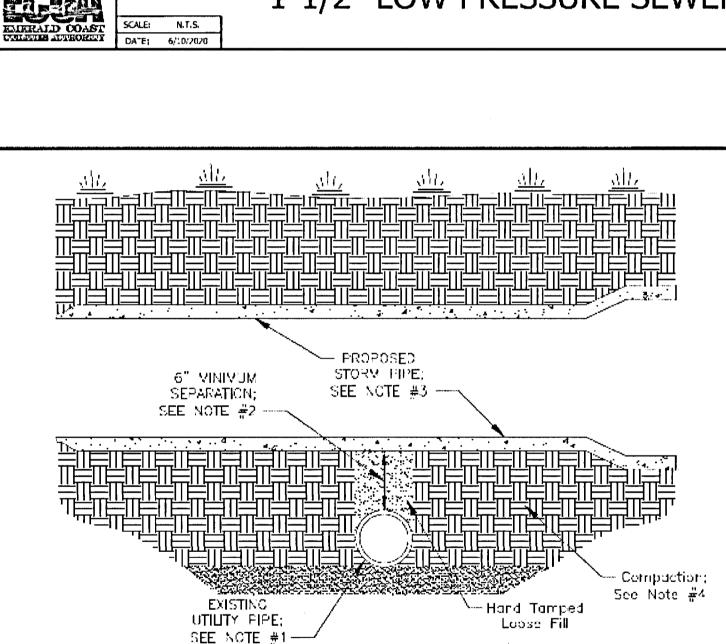
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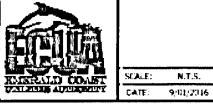






NOTES FOR STORM SYTEM INSTALLATION:

- 1. The first step in avoiding any potential conflict between a proposed storm system. design and an existing utility pipe is confirmation of the exact horizontal and vertical location of the existing utility pipe. Per industry standard best management practices, the storm system designer should have the exisiting utility pipe exposed and survey the exact horizontal location and vertical elevation prior to designing the storm system, thus allowing conflicts to be avoided as much as possible, or, when needed, utility relocations designed into contract.
- 2. Maintain at least 5" of vertical separation as shown from the exterior of the storm pipe to the exterior of the utility pipe. In situations where 6" cannot be provided, then E.C.U.A. will determine if less than $6^{\prime\prime}$ will be allowed. Separations less than **3"** are generally not allowed.
- Contractor shall layout storm system piping such that midpoint of storm pipe. -segment is centered over - utility pipe as much as practical. Bell and spigot endsof storm pipe shall be kept as far away from utility pipe as possible.
- 4. In order to 'bridge' utility pipe, Contractor shall compact soil under entire segment of storm pipe that is over utility pipe to 98% modified Proctor for a depth of 12%below storm pipe, while taking care not to damage utility pipe. Fill space between utility pipe and storm pipe with loose fill and hand tamp.



STORM SEWER VERTICAL **SEPARATION**

SCALE: N.T.S.

WATER / SEWER

DETAIL

7/11111/3/25/20 ERIC NEIL LANE, P.E. COA# 32689 FL. PE No. 86920

VALVE BOX TERMINAL FLUSHING CONNECTION VALVE BOX GRAVEL HEDDING FOR HOX SUPPORT AND SURFACE WATER LEACHING 7" CC X IP COPP STCP FORD MCCEL F1500—X OR APPROVED ECUAL ___ __

INLINE FLUSHING CONNECTION

LOW PRESSURE FLUSHING CONNECTIONS SCALE! N.T.S.

JOINT SPACING • CROSSINGS OTHER PIPE HORIZONTAL SEPARATION CROSSINGS (1) (FULL JOINT CENTERED) WATER MAIN ALTERNATE 3 FT. MINIMUM WATER MAIN 12 INCHES IS THE MINIMUM, WATER MAIN STORM SEWER, EXCEPT FOR STORM SEWER, 3 FT. MINIMUM THEN 6 INCHES IS THE MINIMUM STORMWATER FORCE MAIN AND 12 INCHES IS PREFERRED OTHER PIPE OTHER PIPE ALTERNATE 6 FT MINIMUM WATER MAIN WATER MAIN 12 INCHES IS THE MINIMUM, GRAVITY OR PRESSURE WATER MAIN 10 FT. PREFERRED EXCEPT FOR GRAVITY SEWER. SANITARY SEWER, 6 FT. MINIMJM (2) THEN 6 INCHES IS THE MINIMUM AND 12 INCHES IS PREFERRED SANITARY SEWER FORCE MAIN OTHER PIPE OTHER PIPE

(1) WATER MAIN SHOULD CROSS ABOVE OTHER PIPE. WHEN WATER MAIN MUST BE BELOW OTHER PIPE, THE MINIMUM SEPARATION IS 12 INCHES. 3 FT. GRAMTY SANITARY SEWER WHERE THE BOTTOM OF THE WATER MAIN IS LAID AT LEAST 6 INCHES ABOVE THE TOP OF THE GRAVITY SANITARY SEWER.

- A. INFORMATION PROVIDED FROM FDEP RULE 62-555. IF OTHER FDEP RULES CONFLICT, THEN USE THE MOST STRINGENT RULE.
- B. IF THERE ARE CONFLICTS IN THE SEPARATION REQUIREMENTS BETWEEN COLLECTION SYSTEMS AND DRINKING WATER FACILITIES ESTABLISHED IN FOOTNOTES (1) AND (2) ABOVE AND THOSE ESTABLISHED IN CHAPTER 62-532 OR 62-555, F.A.C., THEN THE REQUIREMENTS IN CHAPTER 62-532 OR 62-555, F.A.C., SHALL APPLY.

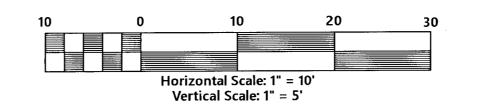


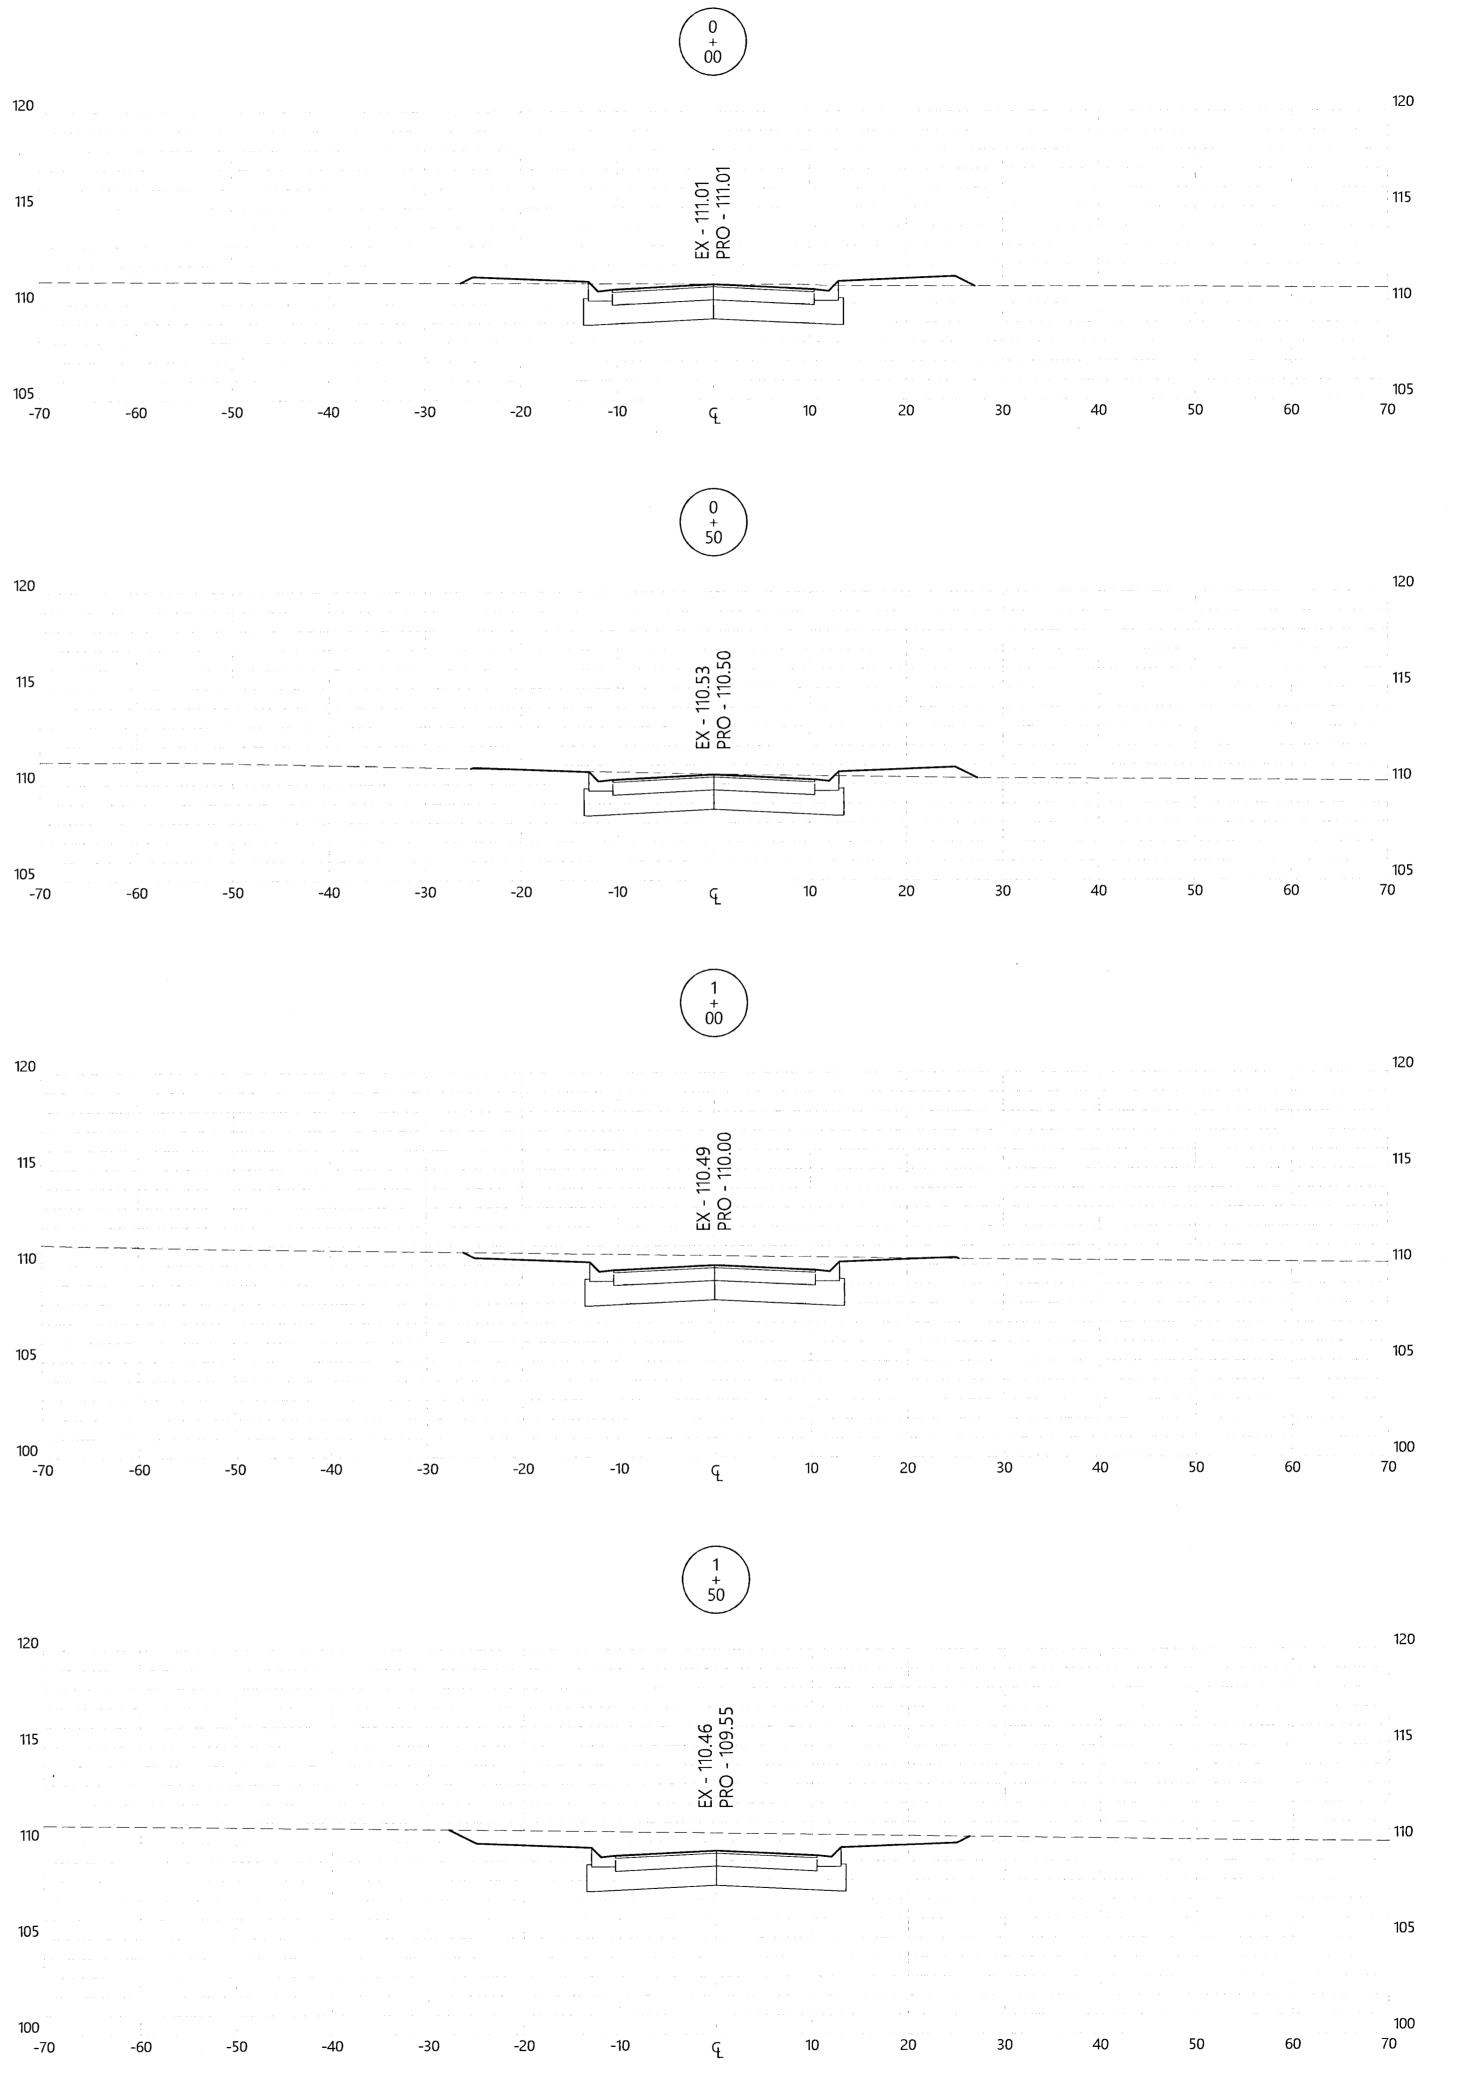
SEPARATION

WATER/SEWER SEPARATION

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Details





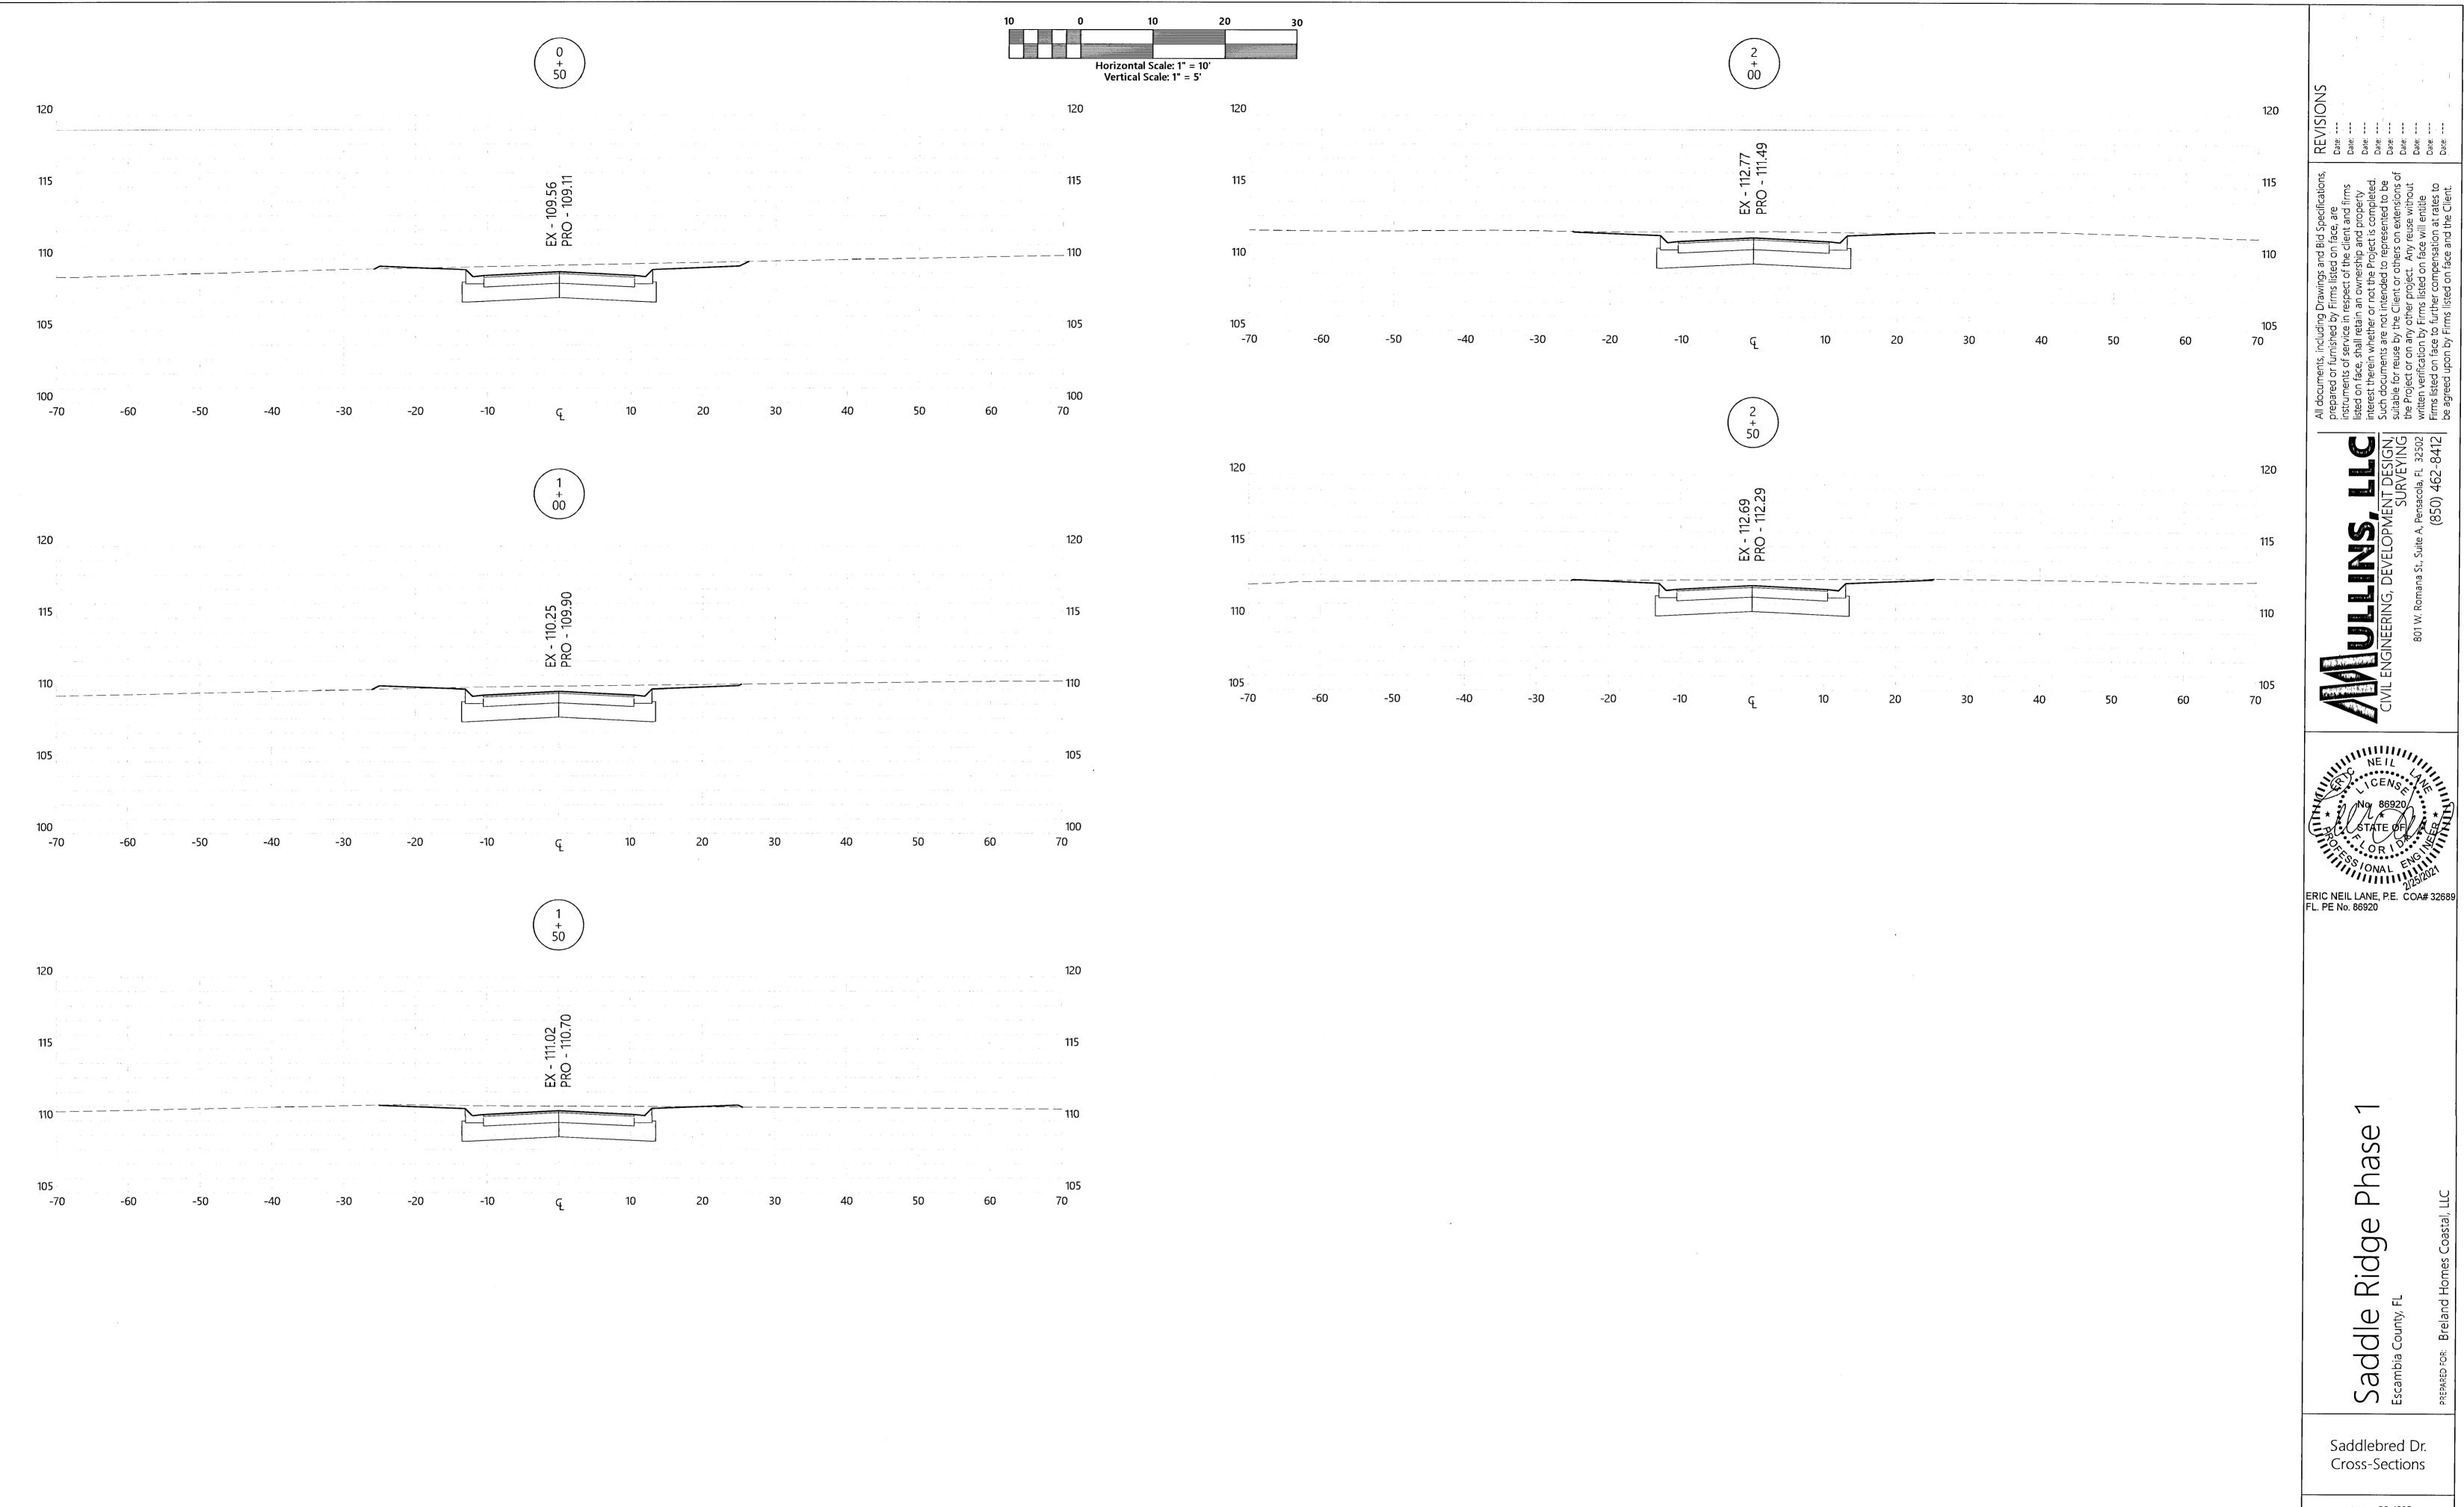
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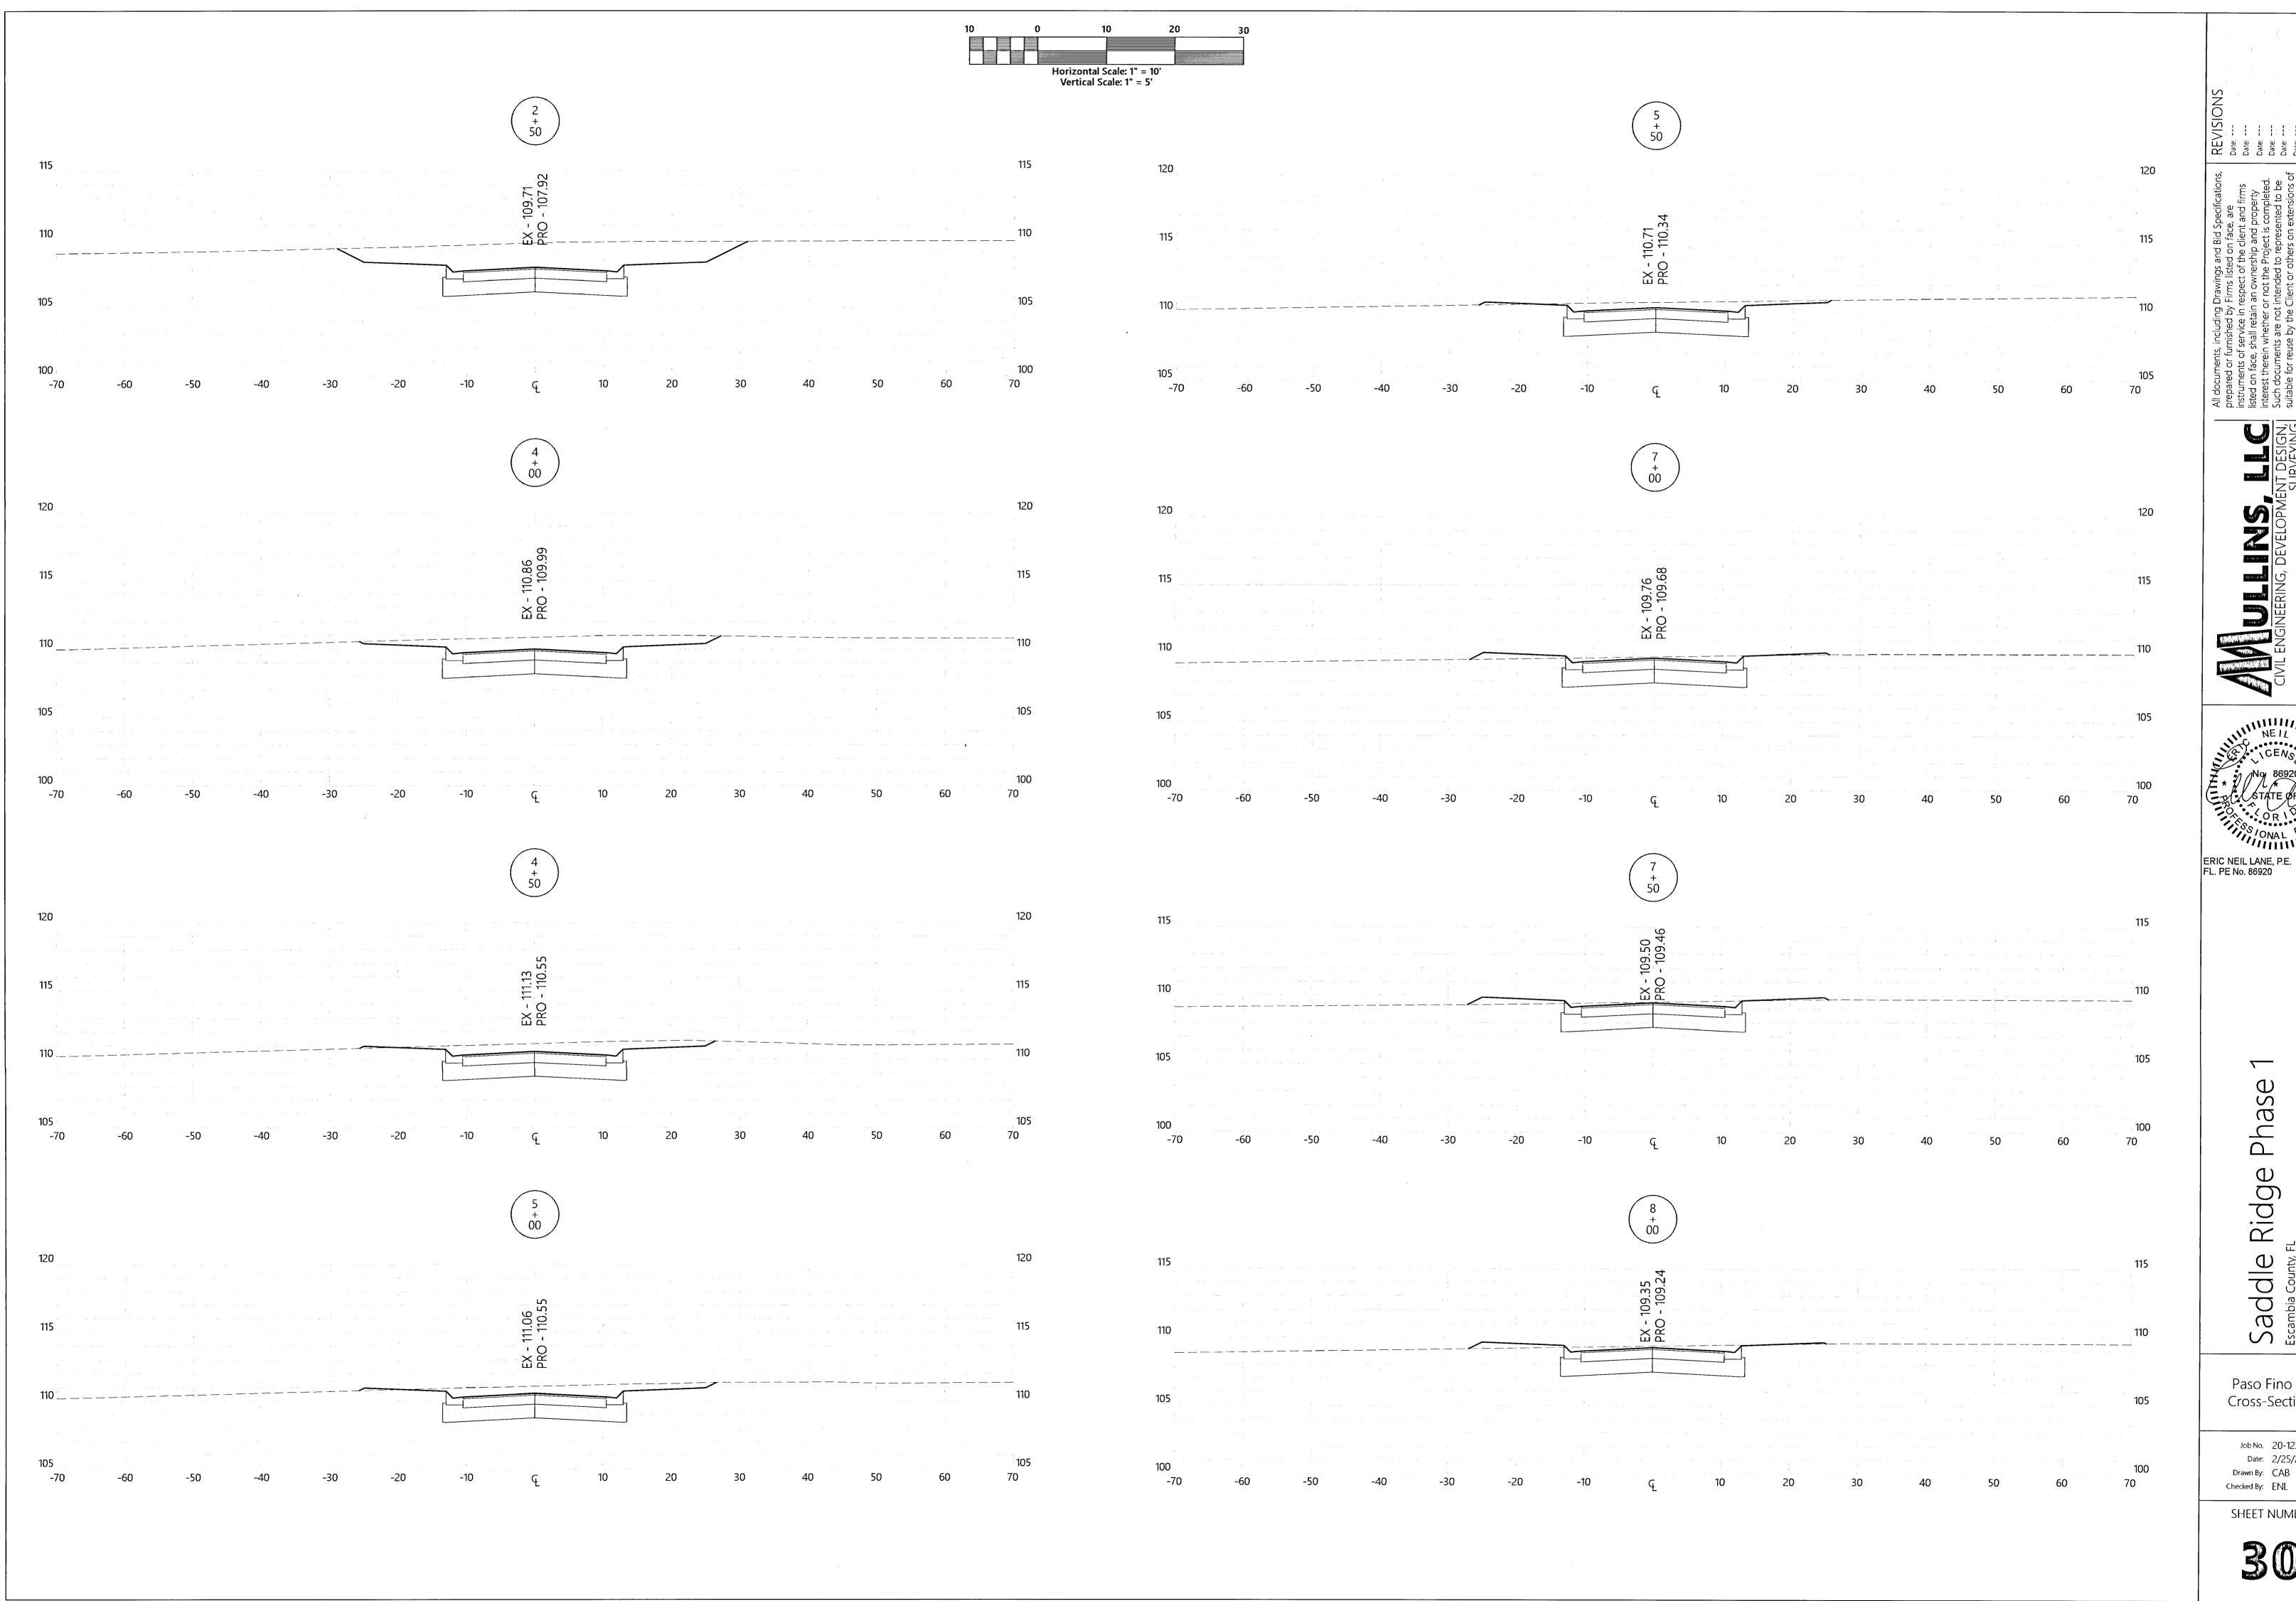
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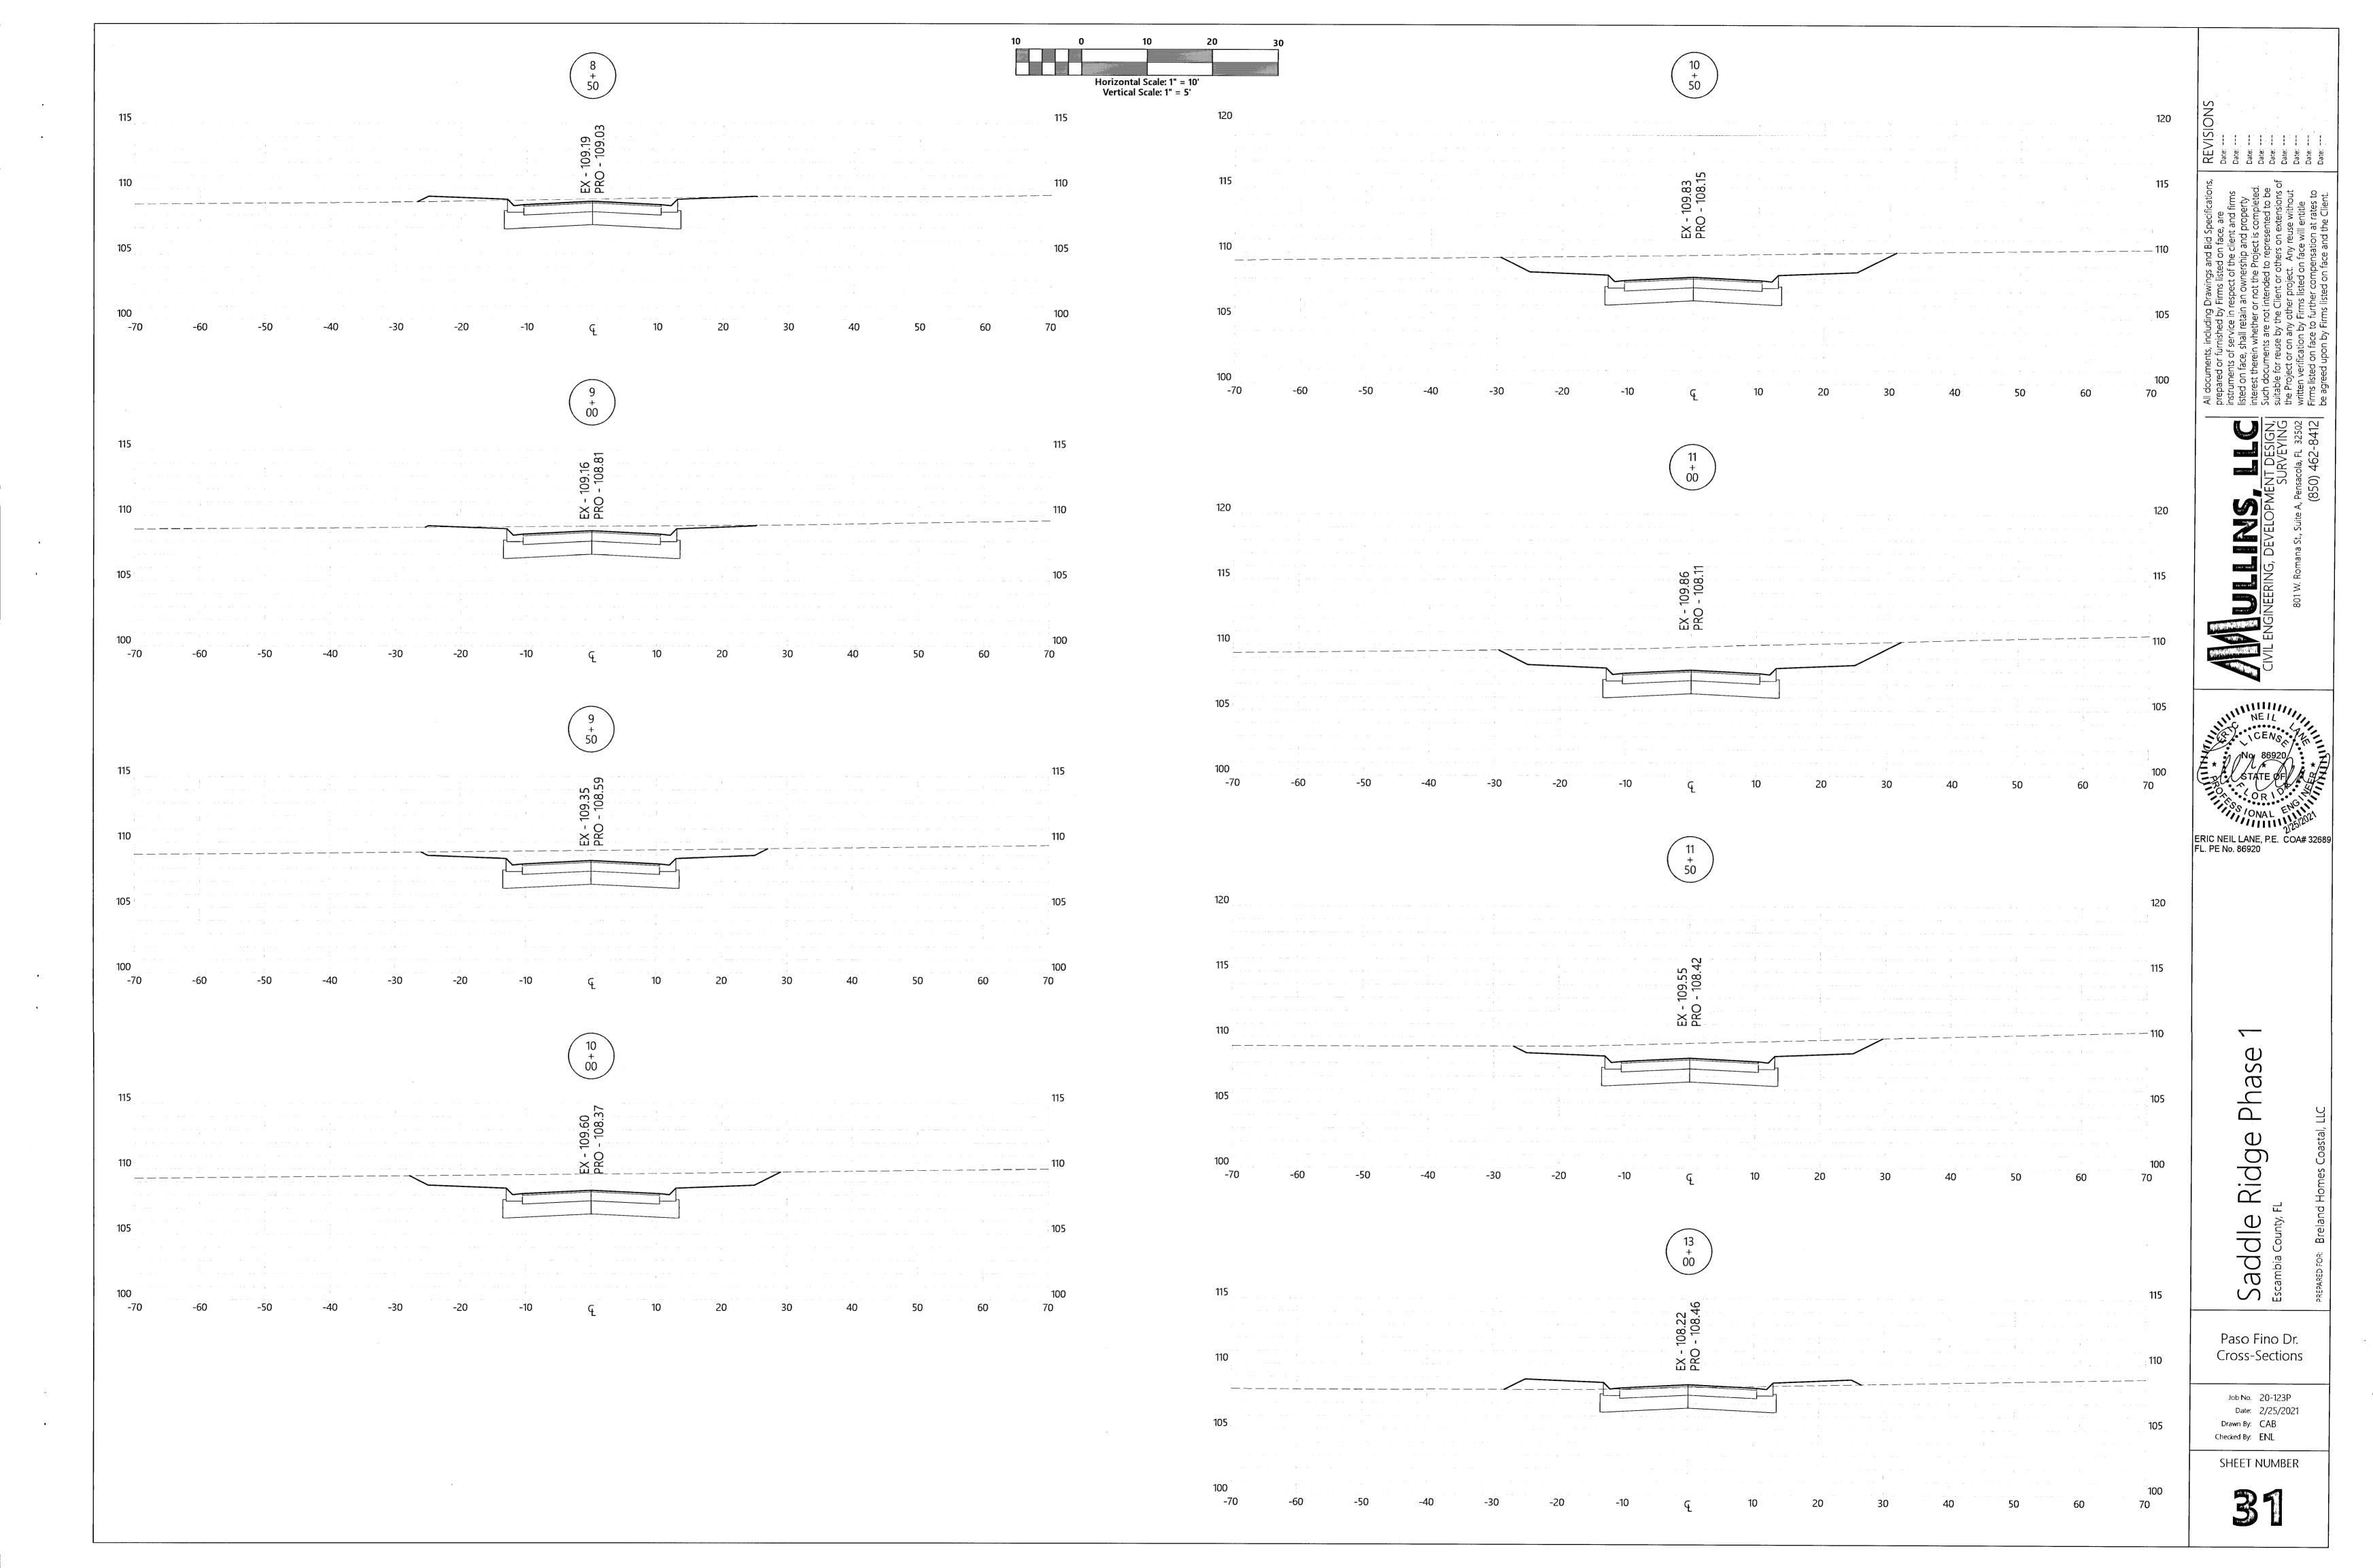
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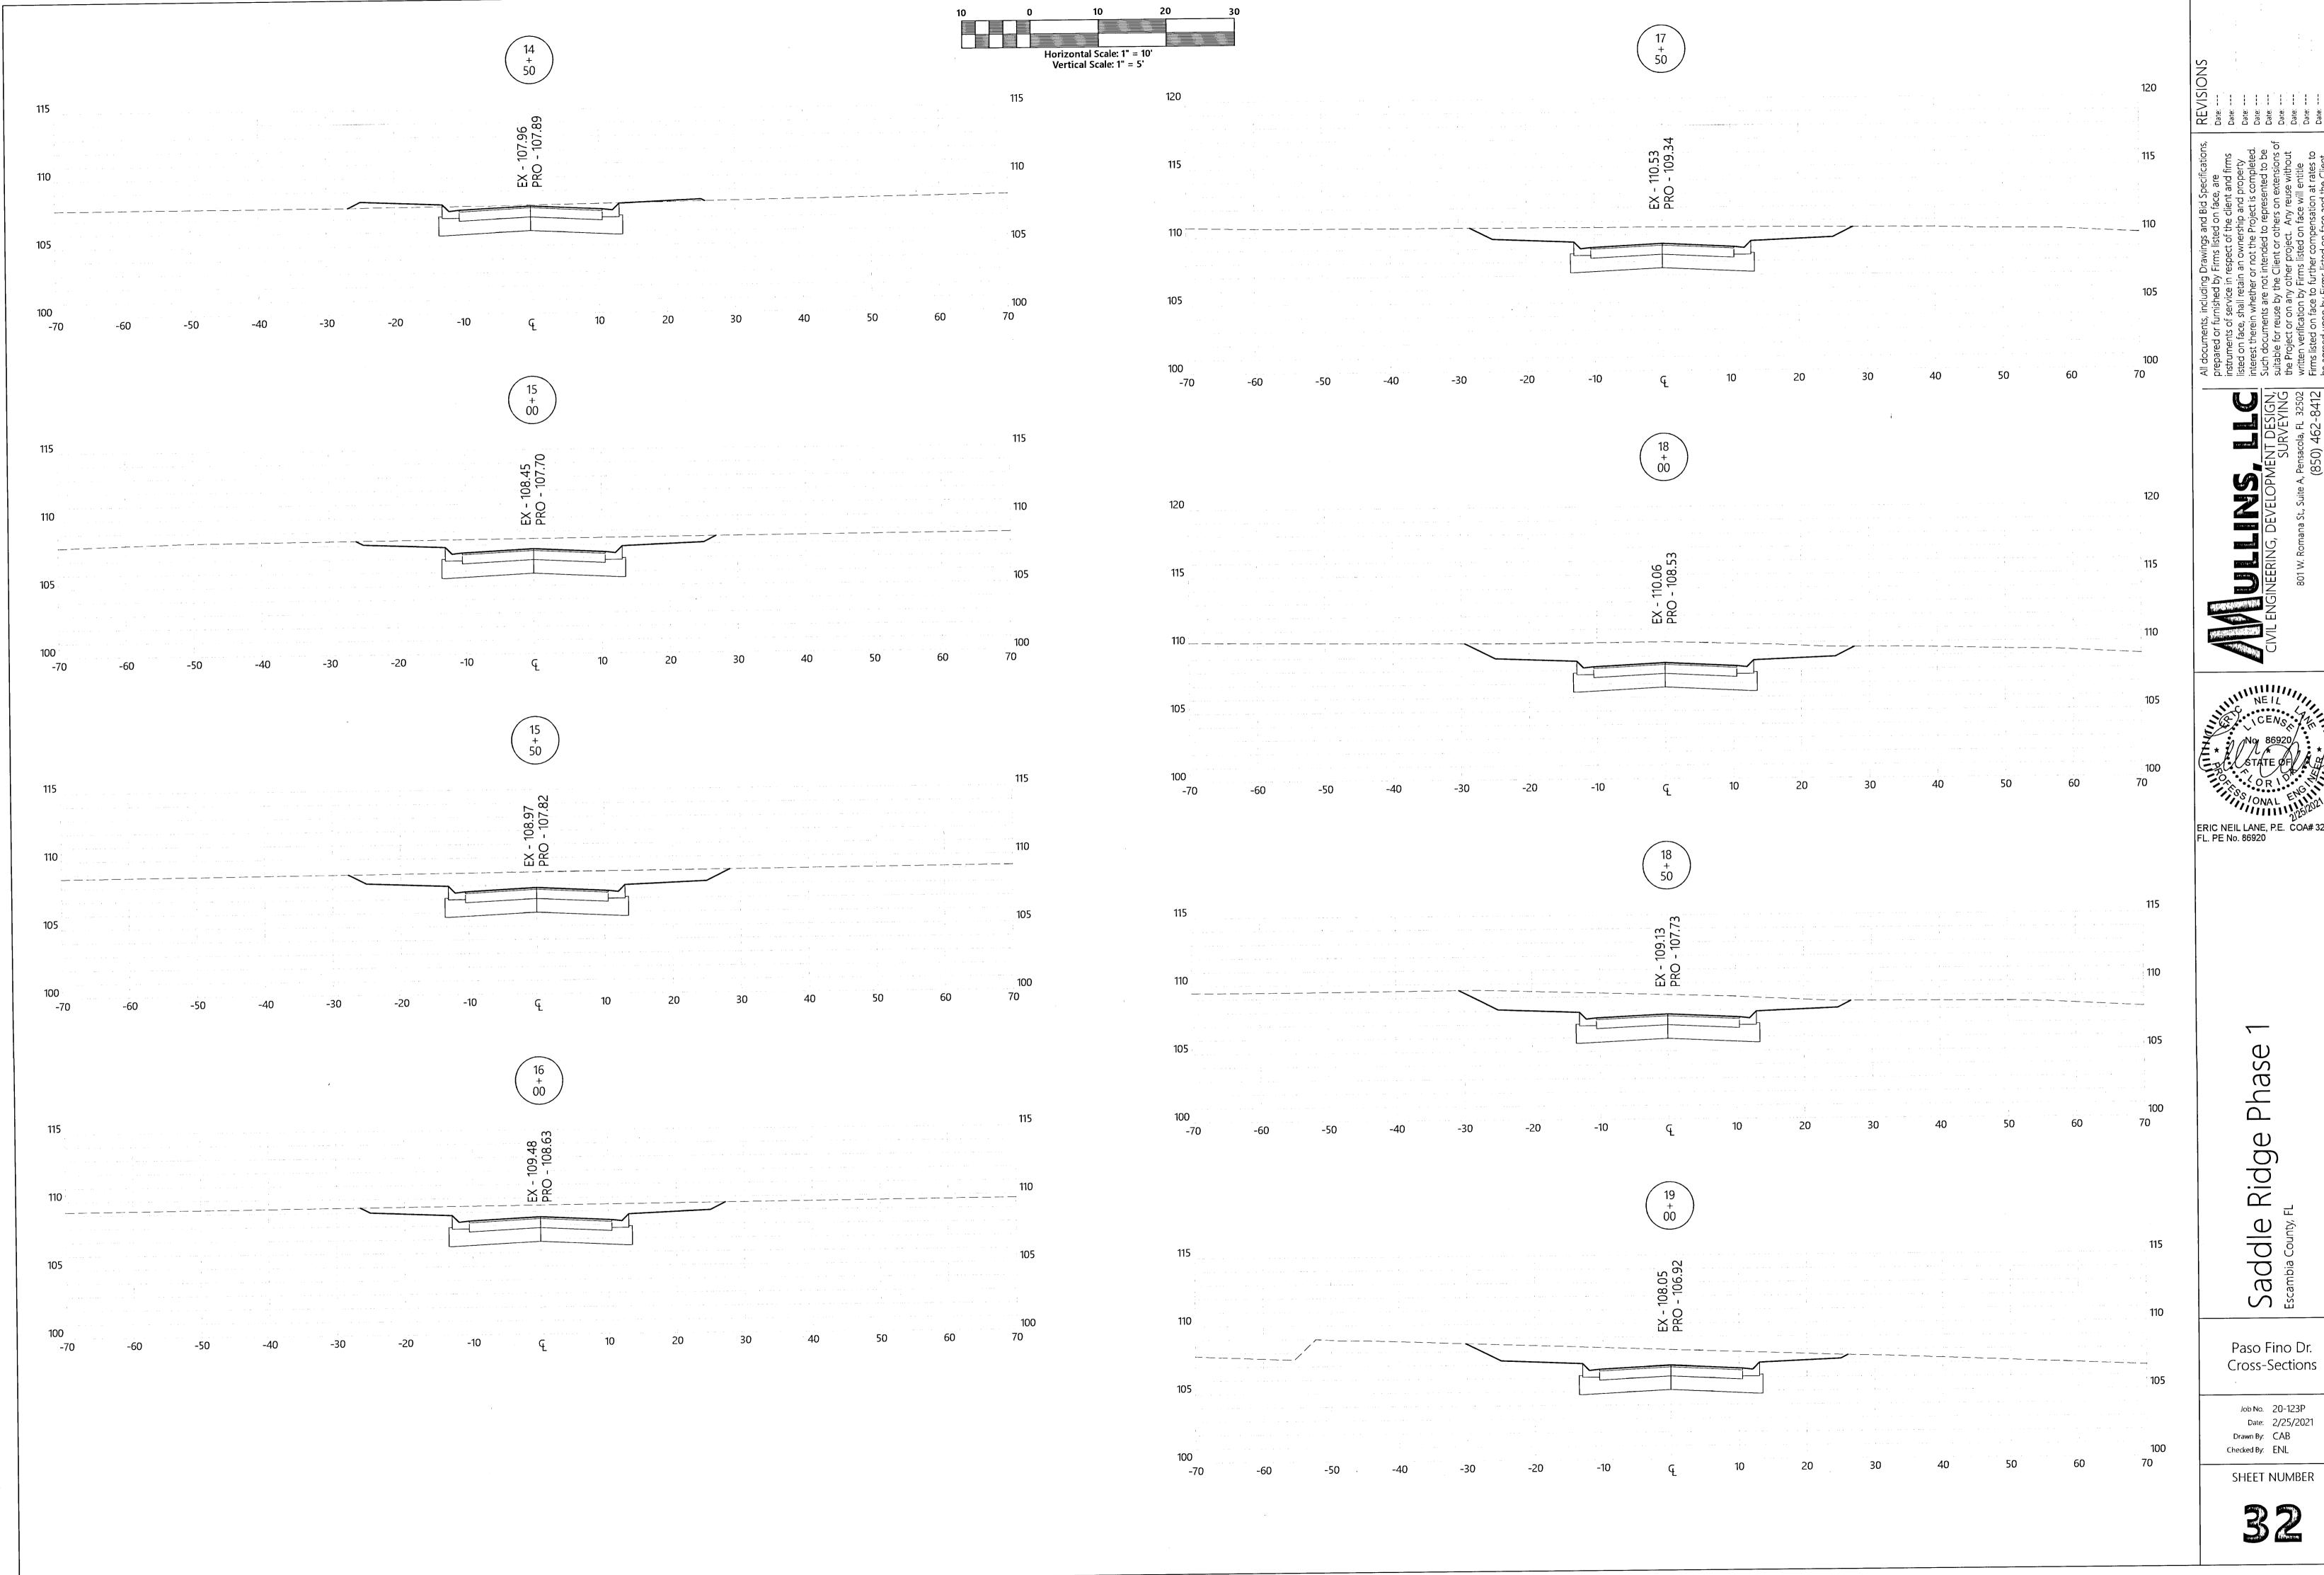
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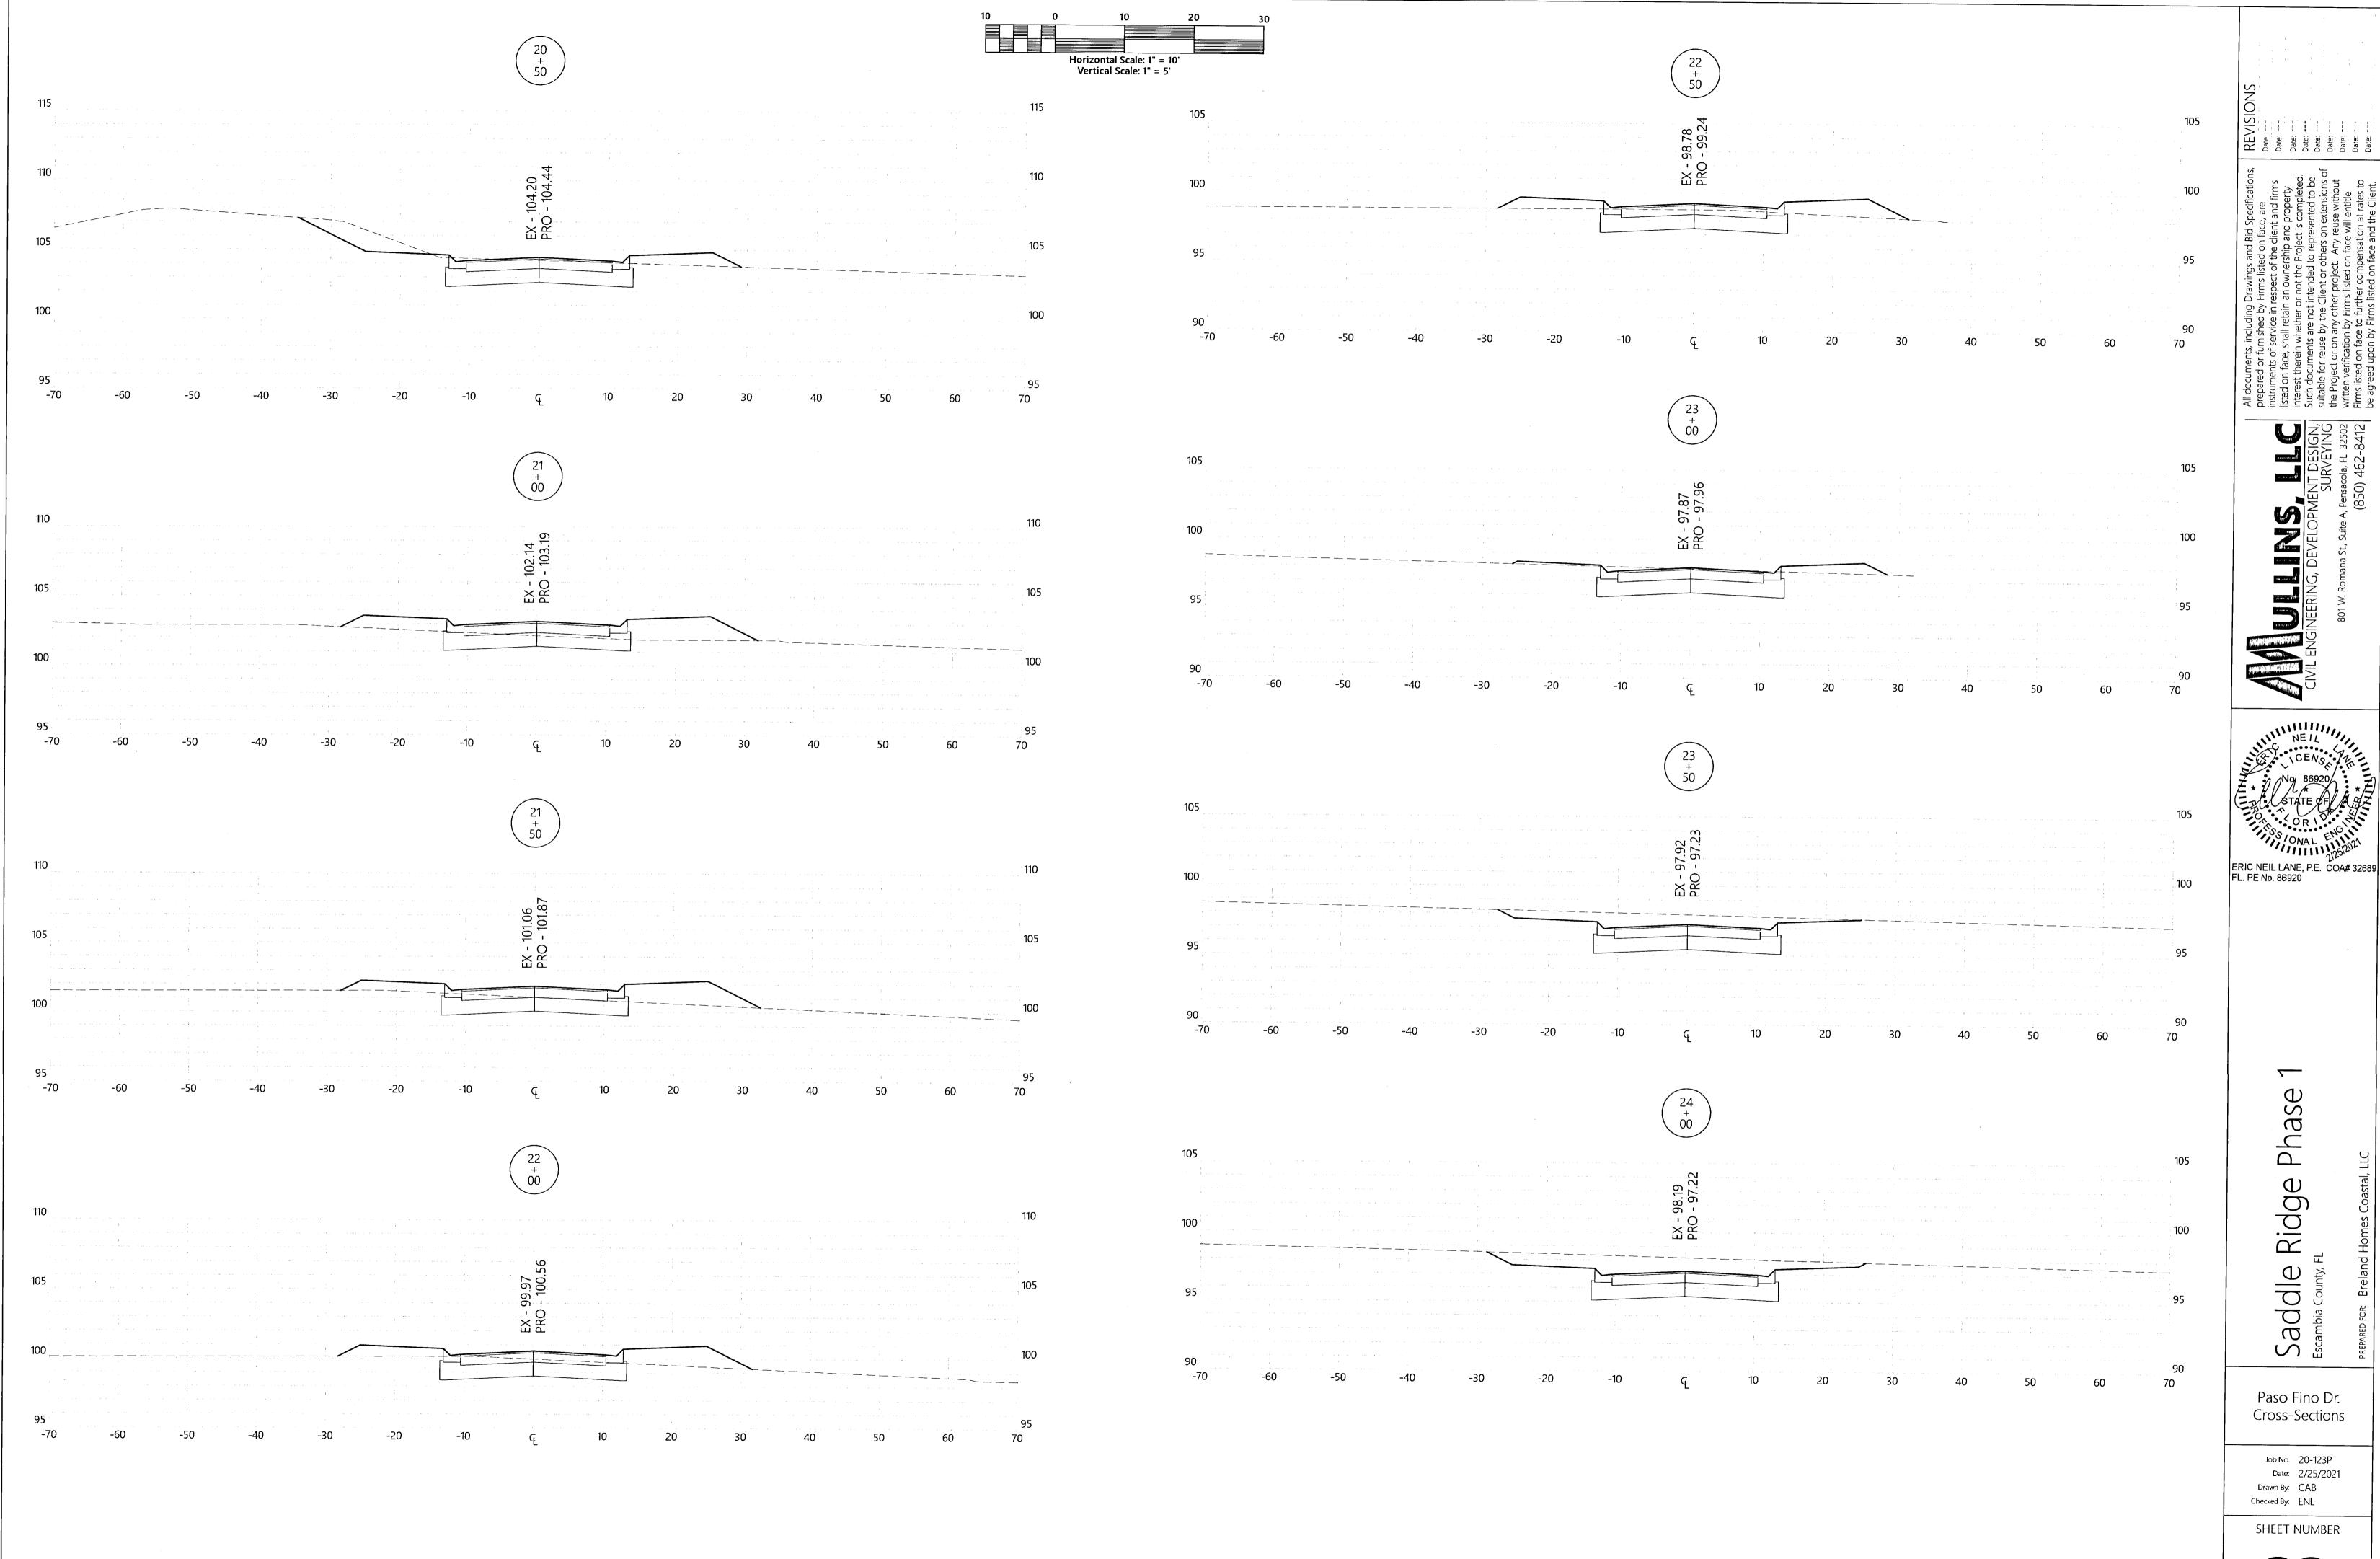
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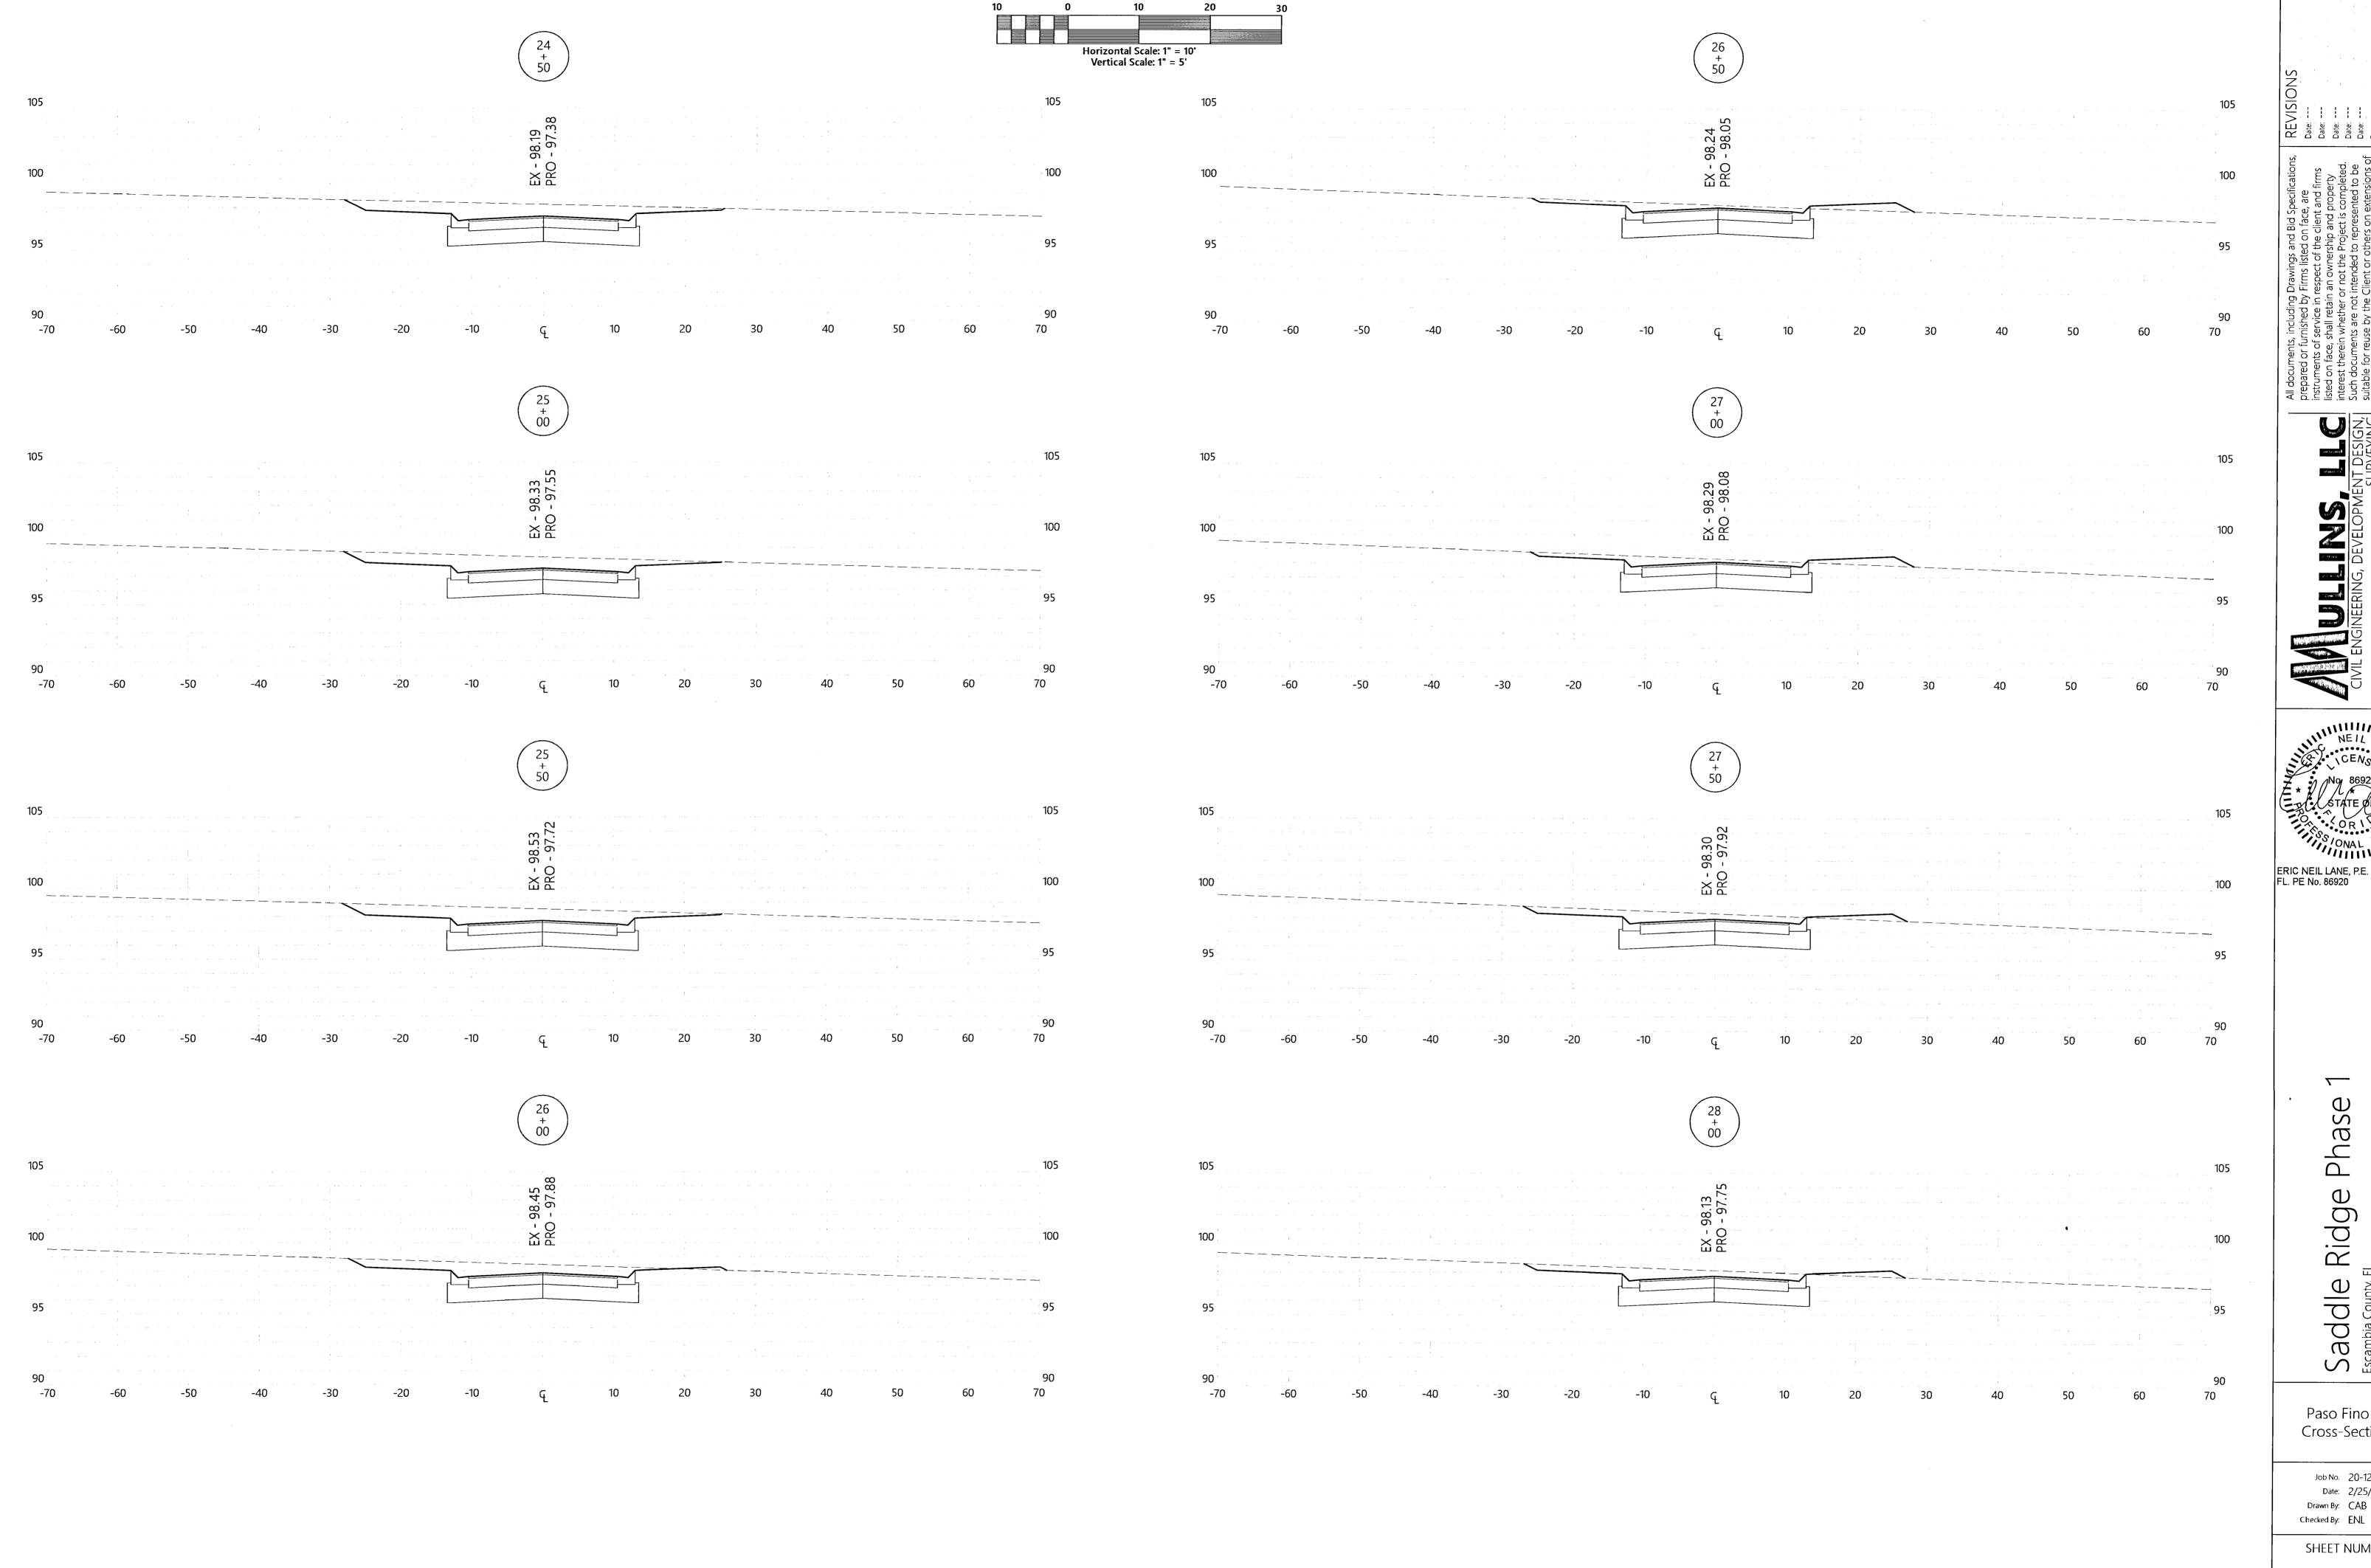
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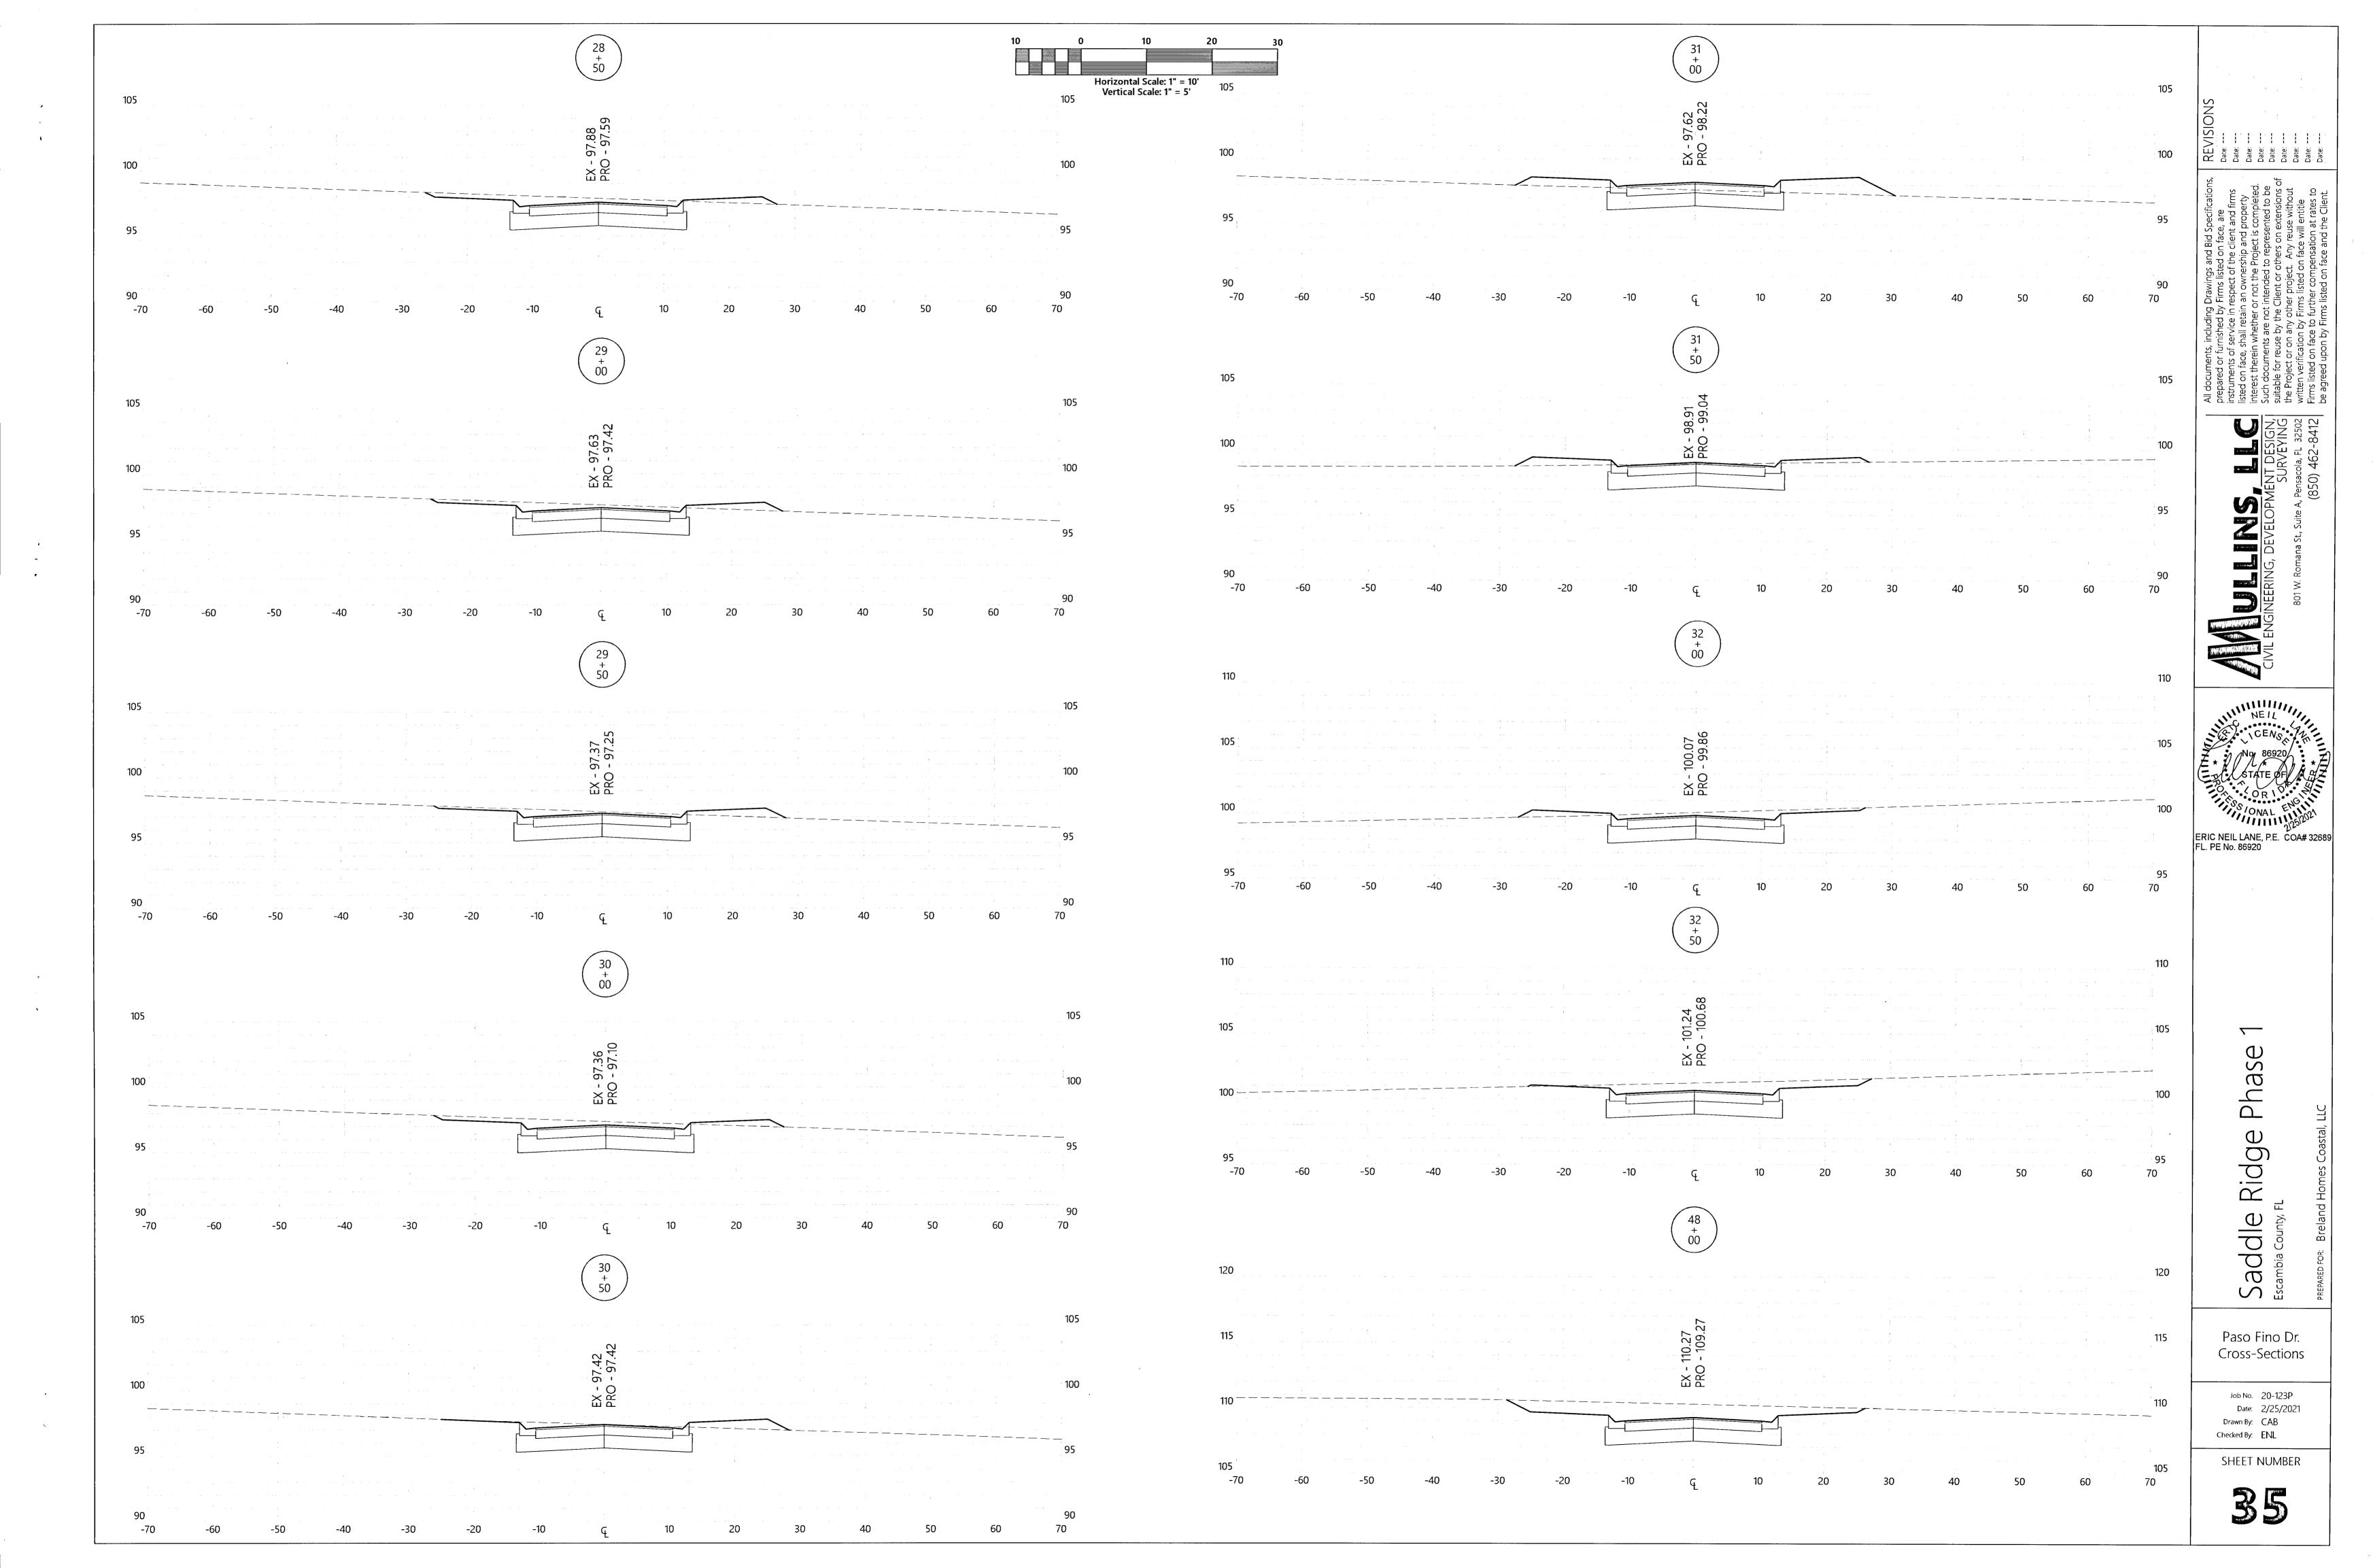
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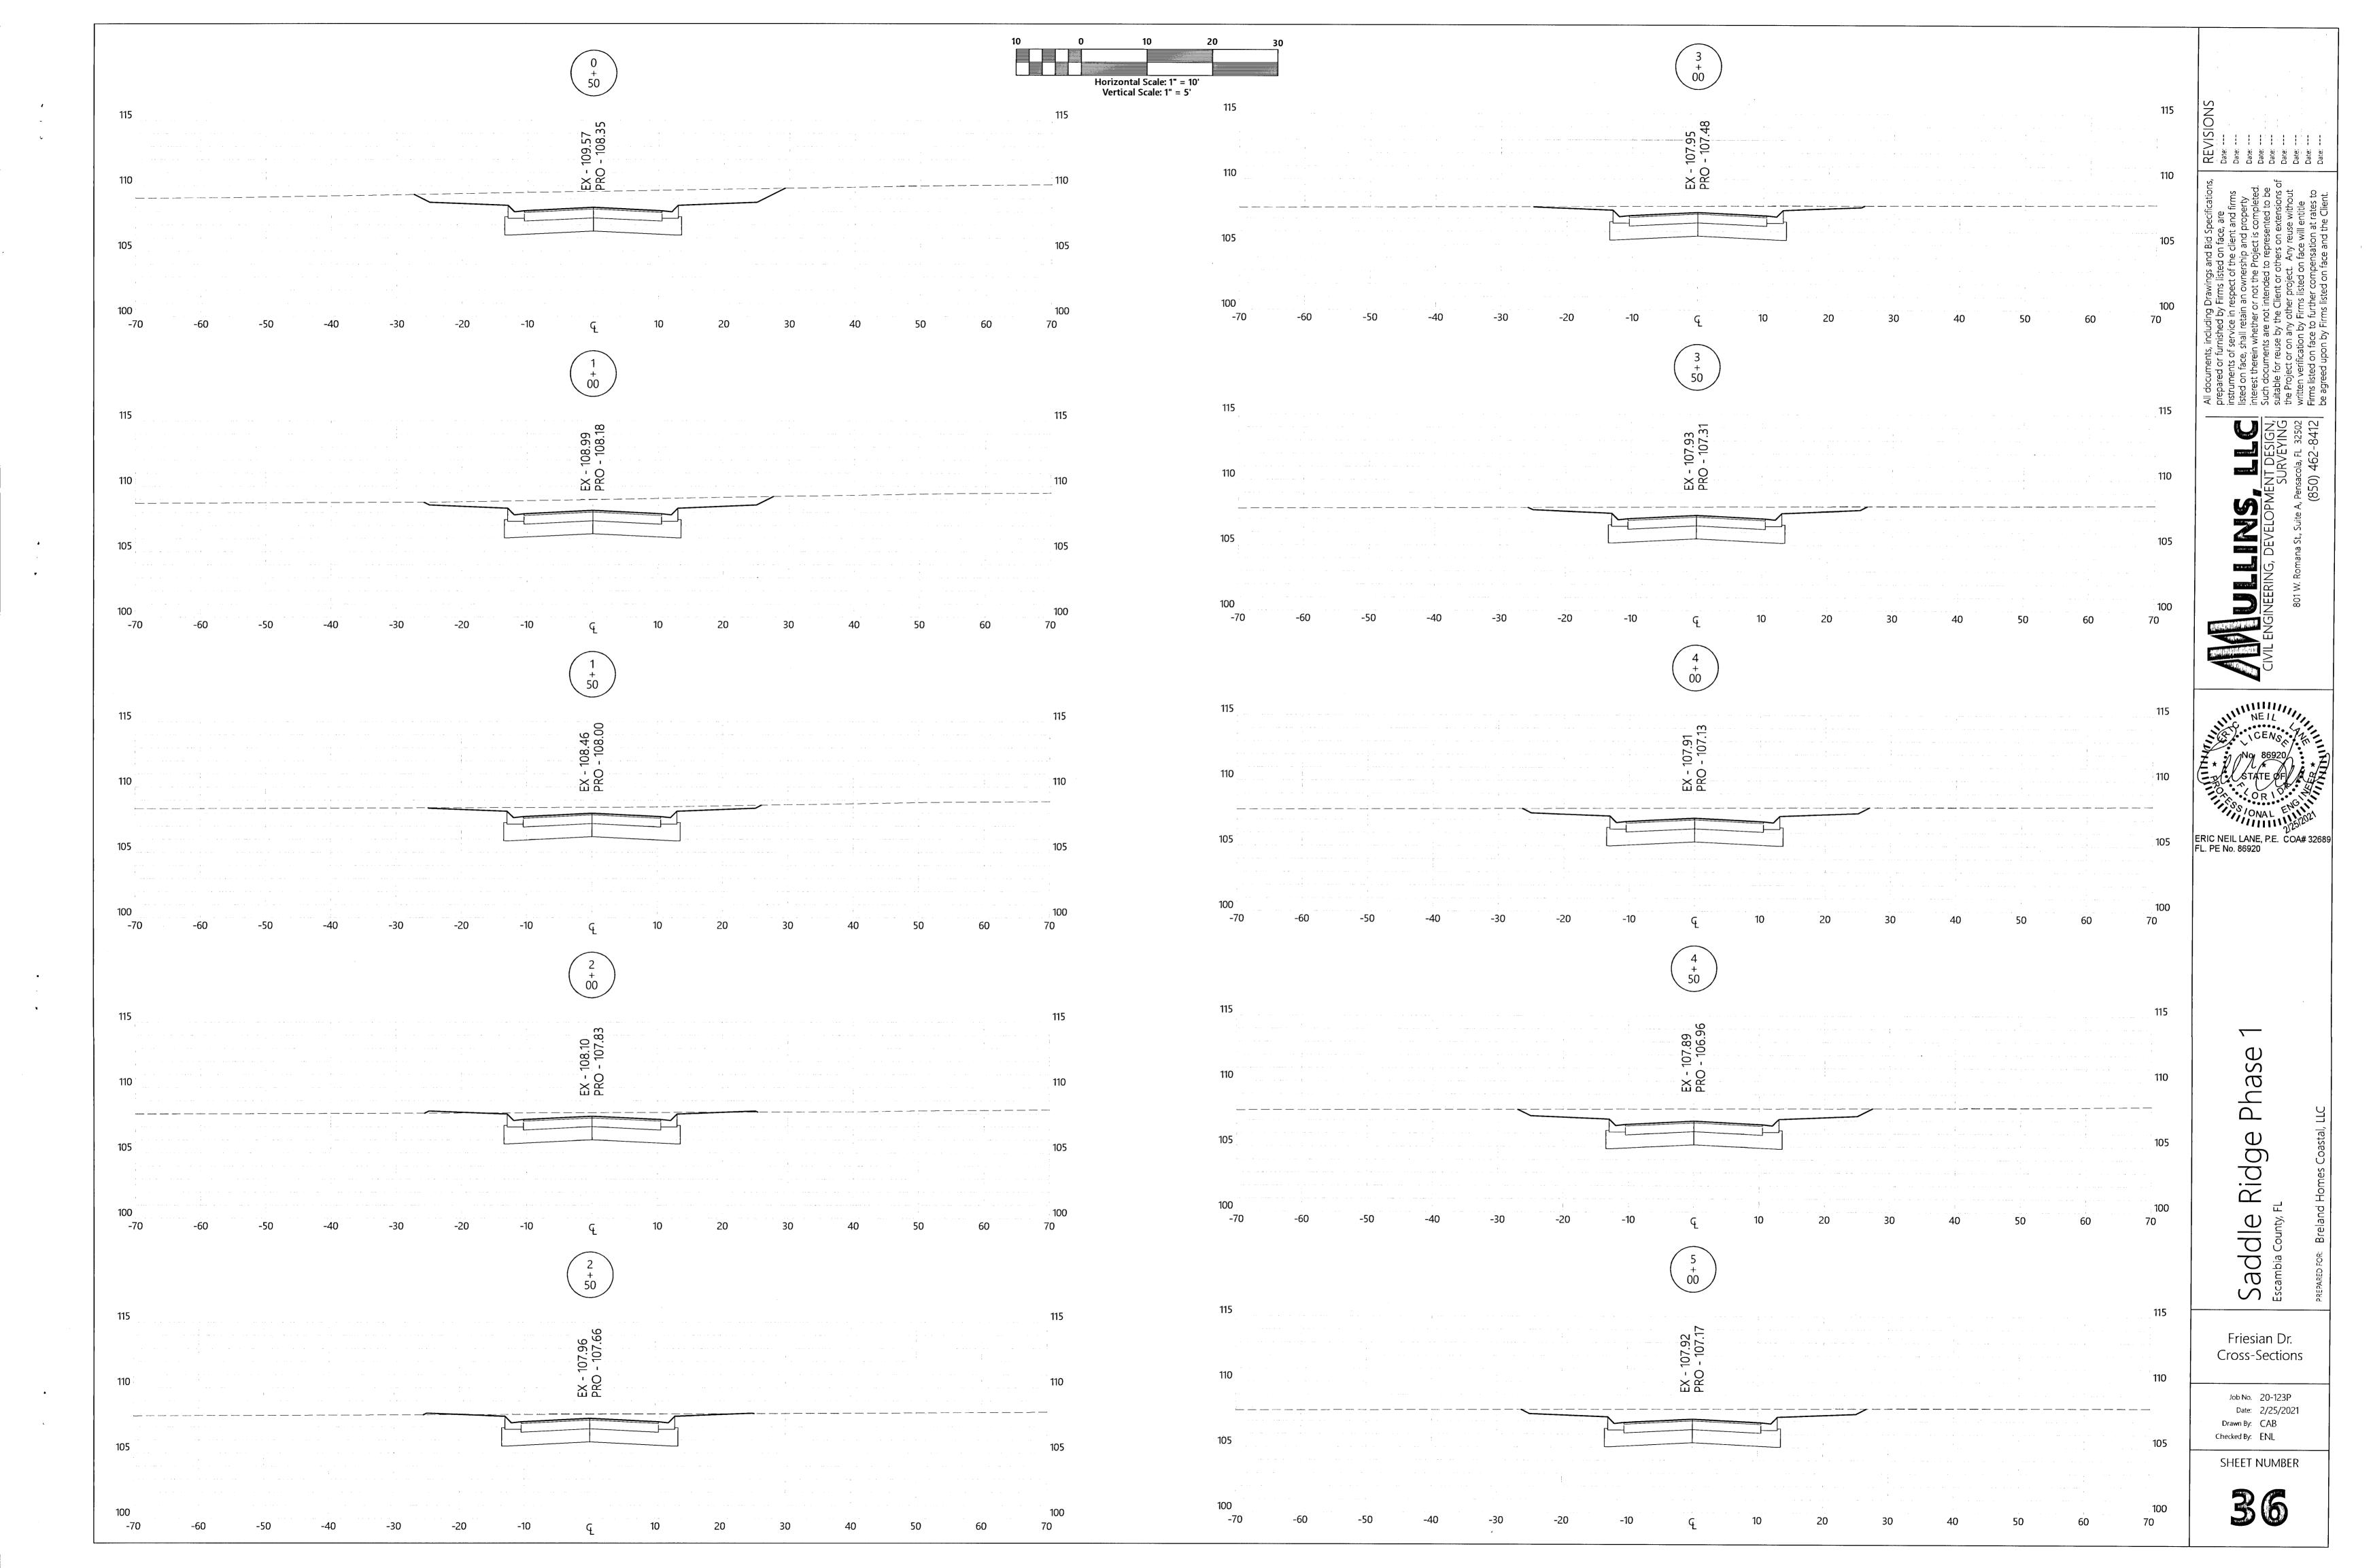
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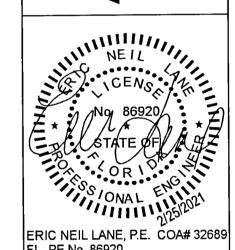
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Paso Fino Dr. Cross-Sections

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