Approved ESCAMBIA COUNTY DRC PLAN REVIEW

This document has been reviewed in accordance with the requirements of applicable Escambia County Regulations and Ordinances, and does not in any way relieve the submitting Architect, Engineer, Surveyor or other signatory from responsibility of details as drawn. A Development Order (DO) must be obtained through the Development Review Process prior to the commencement of construction. This DO approval does not constitute approval by any other agency. All additional state/federal permits shall be provided to the county prior to approval of a final plat or the issuance of state/federal permits shall be provided to the county prior to approval of a final plat or the issuance of a building permit.

SITE NAME:

DUNAWAY

LOCATION CODE:

511076

TOWER TYPE:

PROPOSED 140 FT MONOPOLE TOWER (TOWER HEIGHT - 141' AGL; OVERALL APPURTENANCE HEIGHT - 151' AGL)





PREPARED BY:



6801 PORTWEST DRIVE #100 HOUSTON, TX 77024 713-677-0964

ZONING DRAWINGS

POWER & TELCO COORDINATION:

- POWER COMPANY: MAIN CONTACT NUMBER:
- GULF POWER 850-969-3111
- PWR. CO. ENGINEER:
- ENGINEER CONTACT INFO:
- ESID NUMBER: TBD
- METER ADDRESS:
- TELEPHONE COMPANY:
- TEL. CONTACT NUMBER:
- 850-436-1438

DRIVING DIRECTIONS:

FROM SWITCH:

FROM HARAHAN, TAKE I-10E APPROXIMATELY 197 MILES EAST TO EXIT #7A IN FLORIDA FOR FL-297S / PINE FOREST ROAD. TURN RIGHT ONTO FL-297 N / PINE FOREST ROAD AND TRAVEL 1.4 MILES AND THE RAW LAND SITE WILL BE ON YOUR

THE PROPOSED EQUIPMENT WILL NOT

BE USED FOR EMERGENCY RESPONSE

THE COUNTY SHALL CONSIDER ANY COMMERCIAL COMMUNICATION TOWER WHOSE USE HAS BEEN DISCONTINUED FOR A PERIOD OF 12 MONTHS TO BE ABANDONED. THE OWNER/OPERATOR OF THE TOWER SHALL HAVE 180 DAYS TO REACTIVATE THE USE OF THE TOWER, TRANSFER THE TOWER TO ANOTHER OWNER/OPERATOR, OR DISMANTLE AND

PROJECT INFORMATION

SITE ADDRESS

7038 PINE FOREST ROAD PENSACOLA, FL 32526

SITE NAME:

DUNAWAY

LATITUDE:

30° 29' 32.05" N (NAD83) -87° 18' 12.18" W (NAD83)

LONGITUDE: ELEVATION:

DEVELOPER:

JURISDICTION: CLASSIFICATION:

ESCAMBIA COUNTY

HEAVY COMMERCIAL / LIGHT INDUSTRIAL **ESCAMBIA COUNTY**

COUNTY:

LAND OWNER:

BILL & LISA KITTEL 12230 HALCYON DR.

PENSACOLA, FL 32506 LISA KIRKMAN KITTEL; 850-516-8004

VERIZON WIRELESS 14123 CICERO ROAD

HOUSTON, TX 77095 CM: JEFF MCNARY 850-572-7020

ENGINEER:

P. MARSHALL & ASSOCIATES 6801 PORTWEST DR. SUITE 100 HOUSTON, TX 77024 PATRICK W. MARSHALL, P.E.

DRAWING INDEX

TITLE SHEET & PROJECT INFORMATION

SURVEY (POINT TO POINT)

TREE SURVEY (360 SURVEYING SERVICES)

OVERALL SITE PLAN

OVERALL SITE PLAN W/ MAP

DETAILED SITE PLAN TOWER FLEVATION

ANTENNA ORIENTATION

GRADING SEDIMENT & EROSION CONTROL PLAN

GRADING SEDIMENT & EROSION CONTROL PLAN
GRADING SEDIMENT & EROSION CONTROL PLAN

GRADING SEDIMENT & EROSION CONTROL DETAILS

GRADING SEDIMENT & EROSION CONTROL NOTES

FENCE DETAILS

ENVIRONMENTAL SITE PLAN

TREE PLAN

verizon

DUNAWAY

7038 PINE FOREST ROAD PENSACOLA, FL 32526

> LOCATION CODE: 279068

-			
NO.	DATE	REVISIONS	BY
Α	04/16/20	PRELIM LE	JY
В	B 05/26/20 PRELIM LE		JY
С	07/28/20	PRELIM LE	JY
0	11/05/20	FINAL ZDs	JY
1	12/18/20	JDX COMMENTS	DA
2	12/24/20	JDX COMMENTS	DA
3	01/29/21	JDX COMMENTS	DA
4	02/03/21	SW COMMENTS	DA
5	03/26/21	ENVIRON. COMMENTS	DA
6	06/11/21	DRC COMMENTS	DA
7	06/24/21	DRC COMMENTS	DA



DESIGNED: JY CHECKED: DA

20_V3N_041

TITLE SHEET & PROJECT INFORMATION

T-1



(800) 432-4770 CALL 3 WORKING DAYS BEFORE YOU DIG!





PARENT PARCEL

OWNER: WILLIAM PHILLIP KITTELL, JR., AND LISA E. KIRKMAN, TRUSTEES, OR THEIR SUCCESSORS IN TRUST UNDER THE KITTELL AND KIRKMAN LIVING TRUST DATED NOVEMBER 20, 2006

SITE ADDRESS: 7040 PINE FOREST ROAD, PENSACOLA, FL 32526

PARCEL ID: 241S314301000001

AREA: 9.2808 ACRES (PER TAX ASSESSOR)

ZONED: HC/LHNAI (HEAVY COMMERCIAL / LIGHT INDUSTRIAL)

ALL ZONING INFORMATION SHOULD BE VERIFIED WITH THE PROPER ZONING OFFICIALS

REFERENCE: DEED BOOK 8121 PAGE 1148

FOREST F

50,

1

UP UP

GPS

BASE

TITLE EXCEPTIONS

THIS SURVEY WAS COMPLETED WITH THE AID OF TITLE WORK PREPARED BY US TITLE SOLUTIONS, COMMITMENT DATE OF MARCH 16, 2020, EXAMINED FROM JUNE 27, 1964 TO MARCH 13, 2020, BEING FILE NO. 65123-FL2003-5030, FOR THE PARENT PARCEL, TO DETERMINE THE IMPACTS OF EXISTING

8. AFFIDAVIT BETWEEN WILLIAM P. KITTELL AND LOLA V. KITTELL DATED 5/29/2003 RECORDED 6/9/2003 IN BOOK 5156 PAGE 1858.

[THIS ITEM IS NOT A SURVEY RELATED ITEM]

9. MEMORANDUM OF TRUST BETWEEN WILLIAM P. KITTELL AND LOLA V. KITTELL DATED 7/28/2003 RECORDED 7/30/2003 IN BOOK 5201 PAGE 458.

ITHIS ITEM IS NOT A SURVEY RELATED ITEM!

10. CERTIFICATION OF TRUST BETWEEN WILLIAM PHILLIP KITTELL, JR., AND LISA E. KIRKMAN RECORDED 4/18/2019 IN BOOK 8080 PAGE 1576.

N/F FRANK A. & MYRTLE M. BUCHANAN

PARCEL: 241S314301001001

ZONED: HC/LINA

DB: 258 PG: 107

LAND SPACE-

SEE SHEET 2 FOR DETAIL

[THIS ITEM IS NOT A SURVEY RELATED ITEM]

30' INGRESS-EGRESS

FIBER & UTILITY EASEMENT SEE SHEET 2 FOR DETAIL

KADAR INC

PARCEL: 241S314303000000 ZONED: HC/LI

DB: 6949 PG: 462

HOUSE

PROPERTY LINE

PARENT PARCEL

(PER FILE NO.: 65123-FL2003-5030)

THE SOUTH THREE HUNDRED THIRTY (330) FEET OF THE NORTH SIX HUNDRED SIXTY (660) FEET OF THE SOUTHWEST 1/4 OF THE SOUTHEAST 1/4, IN SECTION 24, TOWNSHIP 1 SOUTH, RANGE 31 WEST, LESS THE WEST ONE HUNDRED (100) FEET THEREOF, FOR PINE FOREST ROAD RIGHT-OF-WAY.

PROPERTY LINE

PARENT PARCEL NF WILLIAM PHILLIP KITTELL, JR., AND LISA E. KIRKMAN, TRUSTEES, OR THEIR SUCCESSORS IN TRUST UNDER

THE KITTELL AND KIRKMAN LIVING TRUST DATED

NOVEMBER 20, 2006

PARCEL: 241S314301000001

ZONED: HC/LI-NA

DB: 8121 PG: 1148

425.9'

N86°59'41"W 328.41

KADER INC

PARCEL: 241S314302000000 ZONED: COM

DB: 8202 PG: 345

5/8" RR





NOT TO SCALE

GENERAL NOTES

* THIS SPECIFIC PURPOSE SURVEY IS FOR THE LAND SPACE AND EASEMENTS ONLY. THIS SPECIFIC PURPOSE SURVEY WAS PREPARED FOR THE EXCLUSIVE USE OF VERIZON WIRELESS AND EXCLUSIVELY FOR THE TRANSFERRAL OF THE LAND SPACE AND THE RIGHTS OF EASEMENT SHOWN HEREON AND SHALL NOT BE USED AS AN EXHIBIT OR EVIDENCE IN THE FEE SIMPLE TRANSFERRAL OF THE PARENT PARCEL NOR ANY PORTION OR PORTIONS THEREOF, BOUNDARY INFORMATION SHOWN HEREON HAS BEEN COMPILED FROM TAX MAPS AND DEED DESCRIPTIONS ONLY. NO BOUNDARY SURVEY OF THE PARENT PARCEL WAS PERFORMED,

THE 1' CONTOURS AND SPOT ELEVATIONS SHOWN ON THIS SPECIFIC PURPOSE SURVEY ARE ADJUSTED TO NAVD 88 DATUM (COMPUTED USING GEOID18) AND HAVE A VERTICAL ACCURACY OF ± 0.5', CONTOURS OUTSIDE THE IMMEDIATE SITE AREA

ALL ZONING INFORMATION SHOULD BE VERIFIED WITH THE PROPER ZONING

ANY UNDERGROUND UTILITIES SHOWN HAVE BEEN LOCATED FROM ABOVE GROUND FIELD SURVEY INFORMATION. THE SURVEYOR MAKES NO GUARANTEES THAT ANY UNDERGROUND UTILITIES SHOWN COMPRISE ALL SUCH UTILITIES IN THE AREA, EITHER IN-SERVICE OR ABANDONED. THE SURVEYOR FURTHER DOES NOT WARRANT THAT ANY UNDERGROUND UTILITIES SHOWN ARE IN THE EXACT LOCATION INDICATED ALTHOUGH THEY ARE LOCATED AS ACCURATELY AS POSSIBLE FROM INFORMATION AVAILABLE. THE SURVEYOR HAS NOT PHYSICALLY LOCATED ANY UNDERGROUND UTILITIES.

PARTY IS PROHIBITED WITHOUT WRITTEN CONSENT OF THE SIGNING PARTY

VICINITY MAP

THIS DRAWING DOES NOT REPRESENT A BOUNDARY SURVEY.

EQUIPMENT USED FOR ANGULAR & LINEAR MEASUREMENTS: LEICA TPS 1200 ROBOTIC & GEOMAX ZENITH 35 [DATE OF LAST FIELD VISIT: JUNE 10, 2020]

BEARINGS SHOWN ON THIS SPECIFIC PURPOSE SURVEY ARE BASED ON GRID NORTH

ADDITIONS OR DELETIONS TO THIS SURVEY MAP BY OTHER THAN THE SIGNING

ORIGINAL SURVEY IS KEPT ON FILE IN THE SURVEYOR'S OFFICE.

SURVEY IS BASED HAVE BEEN PRODUCED AT THE 95% CONFIDENCE LEVEL:

DATES OF SURVEY: APRIL 2, 2020
DATUM / EPOCH: NAD_83(2011)(EPOCH:2010.0000) PUBLISHED / FIXED CONTROL USE: N/A

GEOID MODEL: 18
COMBINED GRID FACTOR(S): 0.99996390 CENTERED ON THE GPS BASE POINT AS SHOWN HEREON.

CONVERGENCE ANGLE: -01°24'36.60" BENCHMARKS USED: DM2660, DM5371, DL7331

SUPERVISION. ANY VISIBLE ENCROACHMENTS ARE SHOWN HEREON. DATE: 08/11/2020 G. DARRELL TAYLOR, FLORIDA PROFESSIONAL SURVEYOR & MAPPER #PSM6904 THIS MAP IS NOT A CERTIFIED SURVEY AND HAS NOT BEEN REVIEWED BY A LOCAL GOVERNMENT AGENCY FOR COMPLIANCE WITH ANY APPLICABLE LAND DEVELOPMENT REGULATIONS, THIS MAP IS ONLY INTENDED FOR THE PARTIES AND PURPOSES SHOWN. THIS MAP IS NOT FOR RECORDATION.

SURVEYOR CERTIFICATION

I HEREBY CERTIFY THAT THIS MAP IS CORRECT AND WAS DRAWN UNDER MY DIRECT.

1/2" OTP



Know what's below. Call before you dig. P2P JOB #: 200449FL

DUNAWAY

SW 1/4 OF SE 1/4 OF SECTION 24, TOWNSHIP 1 SOUTH, RANGE 31 WEST, ESCAMBIA COUNTY, FLORIDA

DRAWN BY: DRC CHECKED BY: JKL

APPROVED: DMM DATE: APRIL 6, 2020

GPS NOTES

POC: IPF 5/8" RB

N: 553859.6181 E: 1084819.9146

THE FOLLOWING GPS STATISTICS UPON WHICH THIS

POSITIONAL ACCURACY: 0.40 FEET (HORZ) 1.08 FEET (YERT)
TYPE OF EQUIPMENT: GEOMAX ZENITH35 PRO BASE AND ROVER, DUAL FREQUENCY
TYPE OF GPS FIELD PROCEDURE: ONLINE POSITION USER INTERFACE

LP LIGHT POLE
FP FLAG POLE
SSMH SANITARY SEWER MANHOLE
INV INVERT
HHE HYDRANT
FP EDGE OF PAVEMENT
TC TOP OF CURB
BC BACK OF CURB
TW TOP OF WALL
BW BOTTOM OF WALL
OU OVERHEAD UTILITY
UE UNDERGROUND UTILITY
CMP CORRUGATED METAL PIPP.
RCP REINFORCED CONCRETE!
PVC POLYMINY CHLORIDE PIP.
GW GUY WINE ANCHOR
TR TRANSFORMER
JB JUNCTION BOX
SWCB SINGLE WING CATCH BAS
DWCB DOUBLE WING CATCH BA
DWCB DUBLE WING CATCH BA
DWC BOUBLE WING CATCH BA
CLF CHAIN LINK FENCE
WW WATER METER
CO SEVER CLEAN-OUT
GV GAS VALVE
NF NOW OR FORMERLY SI OMM DEWIN MAINFULE.
INVERT
FIRE HYDRANT
FOR OF CURB
BACK OF CURB
TOP OF WALL
OVERHEAD UTILITY
CORRIGATED METAL PIPE
REINFORCED CONNERTE PIPE
POLYWINYL CHLORIDE PIPE
GUY WIRE ANOHOR
TRANSFORMER
JUNCTION BOX
3 SINGLE WING CATCH BASIN
CHAIN LINK FENCE
WATER VALVE
WATER METER
SEWER CLEANFOUT
AGS VALVE
NOW OR FORMERLY TREE

(3)

LEGEND

POB POINT OF BEGINNING
POC POINT OF COMMENCEMENT
IPS ROON PIN SET
IPS IRON PIN SED
IRON PIN FOUND
CHE CONCRETE MONUMENT FOUND
UP UTILITY POLE
LP LIGHT POLE
F F FLAG POLE

SANITARY SEWER MANHOLE

GRAPHIC SCALE IN FEET SCALE: 1" = 150'

PER THE FEMA FLOODPLAIN MAPS, THE SITE IS LOCATED IN AN AREA DESIGNATED AS ZONE X (AREA OF MINIMAL FLOOD HAZARD). COMMUNITY PANEL NO.: 12033C0360G DATED: SEPTEMBER 29, 2006 NO WETLAND AREAS HAVE BEEN INVESTIGATED BY THIS SPECIFIC PURPOSE SURVEY.

SPECIFIC PURPOSE SURVEY PREPARED FOR:

STATE OF FLORIDA STATE OF SURVEYOR SULVEYOR SULV

04/07/2020 REVICED LEASE - DRC 06/02/2020 REVISED ACCESS & LEASE - NRW

08/11/2020 CLIENT COMMENTS - NRW

EYOR(er: LB8148 ste. 103

REVISION

4497

.565.

678.

Business License Number: LB 100 Governors Trace, Ste. 1C Peachtree City, GA 30269 (direct) 678.565.4440 (fax) 6 (w) p2pls.com

DATE

1

A

1000 WILLIAMS BLVD. KENNER, LA 70062

SHEET:

LAND SPACE 30' INGRESS-EGRESS, FIBER & UTILITY EASEMENT TOGETHER WITH A 30-FOOT WIDE INGRESS-EGRESS. FIBER AND UTILITY EASEMENT (15 FEET EACH SIDE OF ALL THAT TRACT OR PARCEL OF LAND LYING AND BEING IN THE SOUTHWEST QUARTER OF THE SOUTHEAST CENTERLINE) LYING AND BEING IN THE SOUTHWEST QUARTER OF THE SOUTHEAST QUARTER OF SECTION 24, TOWNSHIP 1 SOUTH, RANGE 31 WEST OF ESCAMBIA COUNTY, FLORIDA, AND BEING A PART OF THE LANDS OF WILLIAM PHILLIP KITTELL, JR., AND LISA E. KIRKMAN, TRUSTEES, OR THEIR SUCCESSORS IN TRUST UNDER THE KITTELL AND KIRKMAN LIVING TRUST DATED NOVEMBER 20, 2006 AS RECORDED IN RECORDED IN DEED BOOK 8121, PAGE 1148, ESCAMBIA COUNTY RECORDS, AND BEING MORE DEED BOOK 8121, PAGE 1148, ESCAMBIA COUNTY RECORDS, AND BEING MORE PARTICULARLY DESCRIBED PARTICULARLY DESCRIBED AS FOLLOWS BY THE FOLLOWING CENTERLINE DATA: TO FIND THE POINT OF BEGINNING, COMMENCE AT A 5/8-INCH REBAR FOUND ON THE EASTERLY TO FIND THE POINT OF BEGINNING, COMMENCE AT A 5/8-INCH REBAR FOUND ON THE EASTERLY RIGHT-OF-WAY OF PINE FOREST ROAD (HAVING A 150-FOOT PUBLIC RIGHT-OF-WAY), SAID REBAR HAVING A FLORIDA GRID NORTH, NAD83, NORTH ZONE VALUE OF N: 553859.6181 E: 1084819.9146; THENCE FLORIDA GRID NORTH, NAD83, NORTH ZONE VALUE OF N: 553859.6181 E: 1084819.9146; THENCE RUNNING ALONG SAID RIGHT-OF-WAY, SOUTH 03°01'41" WEST, 263.43 FEET TO A POINT HAVING A FLORIDA RIGHT-OF-WAY AND RUNNING, SOUTH 88°36'49" EAST, 118.69 FEET TO A POINT; THENCE, NORTH 69°01'46" EAST, 41.31 FEET TO A POINT; THENCE, SOUTH 73°15'29" EAST, 282.37 FEET TO A POINT; GRID NORTH, NAD83, NORTH ZONE VALUE OF N: 553596.5581 E: 1084805.9991 AND THE TRUE POINT OF POC: IPF 5/8" RB N: 553859.6181 BEGINNING; THENCE LEAVING SAID RIGHT-OF-WAY AND RUNNING, SOUTH 88°36'49" EAST, 118.69 FEET TO A E: 1084819.9146 POINT: THENCE, NORTH 69°01'46" EAST, 41.31 FEET TO A POINT: THENCE, SOUTH 73°15'29" EAST, 282.37 THENCE, SOUTH 87°03'17" EAST, 341.01 FEET TO A POINT ON THE WEST LINE OF THE LAND SPACE; FEET TO A POINT; THENCE, SOUTH 87°03'17' EAST, 341.01 FEET TO THE ENDING AT A POINT ON THE WEST LINE OF THE LAND SPACE. OF BEGINNING; THENCE RUNNING, SOUTH 87°03'17" EAST, 60.00 FEET TO A POINT; THENCE, SOUTH 02°56'43" WEST, 60.00 FEET TO A POINT; THENCE, NORTH 87°03'17" WEST, 60.00 FEET TO A POINT; BEARINGS ARE BASED ON FLORIDA GRID NORTH, NAD83, NORTH ZONE. THENCE, NORTH 02°56'43" EAST, 60.00 FEET TO THE POINT OF BEGINNING. BEARINGS ARE BASED ON FLORIDA GRID NORTH, NAD83, NORTH ZONE. SAID TRACT CONTAINS 0.0826 ACRES (3,600 SQUARE FEET), MORE OR LESS. FOREST ROAD 7' PUBLIC R.W SIDEWALK INLET **EXISTING** N69°01'46"E 41.31" 15" ⊕ 60" 26" 40" PROPANE GPS BASE TANK € 35° TEMPORARY 38" GATE LAND SPACE PINE F BRICK COLUMN (TYP) BENCHMARK C/L 30' INGRESS-ELEV: 102.54' RIGHTS TO BE ACQUIRED RCP BRUSH LINE DOLLHOUSE [40" EGRESS, FIBER & TREE LINE POB: LAND-MAY REQUIRE UTILITY EASEMENT POB: ESMT \$88"36"49"E HNVERT-97.66 REMOVAL BY LESSEE SPACE N: 553596.5581 TREE LINE 3 6 118.69 RIGHTS TO BE ACQUIRED E: 1084805.9991 °€ 50" 50" 50" TO BE REMOVED-30" 102 36" RCP WV. BY LESSEE 32" 32 4' HOGWIRE FENCE INVERT INVERT-50" DROP 4'xCHAIN LINK FENCE 96.38 96.64 INCET 102 PROPERTY LINE BRUSH LINE 5/8" RB LEGEND LEGEND POB POINT OF BEGINNING POC POINT OF COMMENCEMENT PS IRON PIN SET IPF IRON PIN FOUND CMF CONCRETE MONUMENT FOUND UP UTILITY POLE LP LIGHT POLE FF FLAG FOLE SSMM SANITARY SEWER MANHOLE INV INVERT FH FIRE HYDRANT EP EDGE OF PAYEMENT TO FO F CURB BC BACK OF CURB TW TOP OF WALL OU OVERHEAD UTILITY UN UNITY BUTTON OF WALL OU OVERHEAD UTILITY UP TOP OF WALL OU OVERHEAD UTILITY UP TOP OF TOP OF THE PAYEMENT TO FO F WALL OU OVERHEAD UTILITY UP UNITY OF WALL OU OVERHEAD UTILITY UP TO TOP OF WALL OU OVERHEAD UTILITY UP TOP OF THE PAYEMENT TO OF WALL OU OVERHEAD UTILITY UP TOP OF WALL OU OVERHEAD UTILITY UP TOP OF THE PAYEMENT TO OF WALL OU OVERHEAD UTILITY UP TO TOP OF WALL OU OVERHEAD UTILITY UP TO THE PAYEMENT TO OF WALL OU OVERHEAD UTILITY UP TO THE PAYEMENT TO OF WALL OU OVERHEAD UTILITY UP TO THE PAYEMENT TO OF WALL OU OVERHEAD UTILITY UP TO THE PAYEMENT TO OF WALL OU OVERHEAD UTILITY UP TO THE PAYEMENT TO OF WALL OU OVERHEAD UTILITY UP TO THE PAYEMENT TO OF WALL OU OVERHEAD UTILITY UP TO THE PAYEMENT TO OF WALL OU OVERHEAD UTILITY UP TO THE PAYEMENT TO OF WALL OU OVERHEAD UTILITY UP TO THE PAYEMENT TO OF WALL OU OVERHEAD UTILITY UP TO THE PAYEMENT TO OF WALL OU OVERHEAD UTILITY UP TO THE PAYEMENT TO OF WALL OU OVERHEAD UTILITY UP TO THE PAYEMENT TO OF WALL TO THE PAYEMENT TO OF WALL TO THE PAYEMENT TO

SITE INFORMATION

LAND SPACE = 3,600 SQUARE FEET (0.0826 ACRES)

LATITUDE = 30°29'32.05" (NAD 83) (30.492236°) LONGITUDE = -87°18'12.18" (NAD 83) (-87.303383°) AT CENTER OF LAND SPACE

ELEVATION AT CENTER OF LAND SPACE = 103.6' A.M.S.L.



QUARTER OF SECTION 24, TOWNSHIP 1 SOUTH, RANGE 31 WEST OF ESCAMBIA COUNTY, FLORIDA, AND BEING A PART OF THE LANDS OF WILLIAM PHILLIP KITTELL, JR., AND LISA E, KIRKMAN, TRUSTEES, OR THEIR SUCCESSORS IN TRUST UNDER THE KITTELL AND KIRKMAN LIVING TRUST DATED NOVEMBER 20, 2006 AS

RIGHT-OF-WAY OF PINE FOREST ROAD (HAVING A 150-FOOT PUBLIC RIGHT-OF-WAY), SAID REBAR HAVING A RUNNING ALONG SAID RIGHT-OF-WAY, SOUTH 03°01'41" WEST, 263,43 FEET TO A POINT HAVING A FLORIDA GRID NORTH, NAD83, NORTH ZONE VALUE OF N: 553596,5581 E: 1084805,9991; THENCE LEAVING SAID THENCE ALONG SAID LAND SPACE, NORTH 02°56'43" EAST, 45.00 FEET TO A POINT AND THE TRUE POINT

> LINE TABLE BEARING

> > S87°03'17"F

S02'56'43"W

N87'03'17"W

NO2'56'43"E

DISTANCE

60.00

60.00

60.00

STATE OF FLORIDA SOLUTION SURVEYOR SURVEYOR SURVEYOR SURVEYOR SURVEYOR SOLUTION SURVEYOR SURV

		and the second second second second second
NO.	DATE	REVISION
1	04/07/2020	REVISED LEASE - DRC
2	06/02/2020	REVISED ACCESS & LEASE - NRW
3	08/11/2020	CLIENT COMMENTS - NRW

678.565 sachtree City, rect) 678.569 p2pls.com

1



SPECIFIC PURPOSE SURVEY PREPARED FOR



DUNAWAY

SW 1/4 OF SE 1/4 OF SECTION 24, TOWNSHIP 1 SOUTH, RANGE 31 WEST, ESCAMBIA COLINTY FLORIDA

DRAWN BY: DRC

APPROVED: DMM

P2P J0B #: 200449FL

CHECKED BY: JKL

DATE: APRIL 6, 2020

[SURVEY NOT VALID WITHOUT SHEET 1 OF 2]


SHEET:

TR TRANSFORMER
JB JINCTION BOX
SWEB SINGLE WING CATCH BASIN
DWEB DOUBLE WING CATCH BASIN
CLF CHAIN LINK FENCE
WV WATER WETER
CO SEWER CLEAH-OUT
GU GAS VALVE
N,F NOW OR FORMERLY (3) TREE

UNDERGROUND UTILITY
CORRUGATED METAL PIPE
REINFORCED CONCRETE PIPE
POLYVINYL CHLORIDE PIPE

GUY WIRE ANCHOR

TRANSFORMER JUNCTION BOX

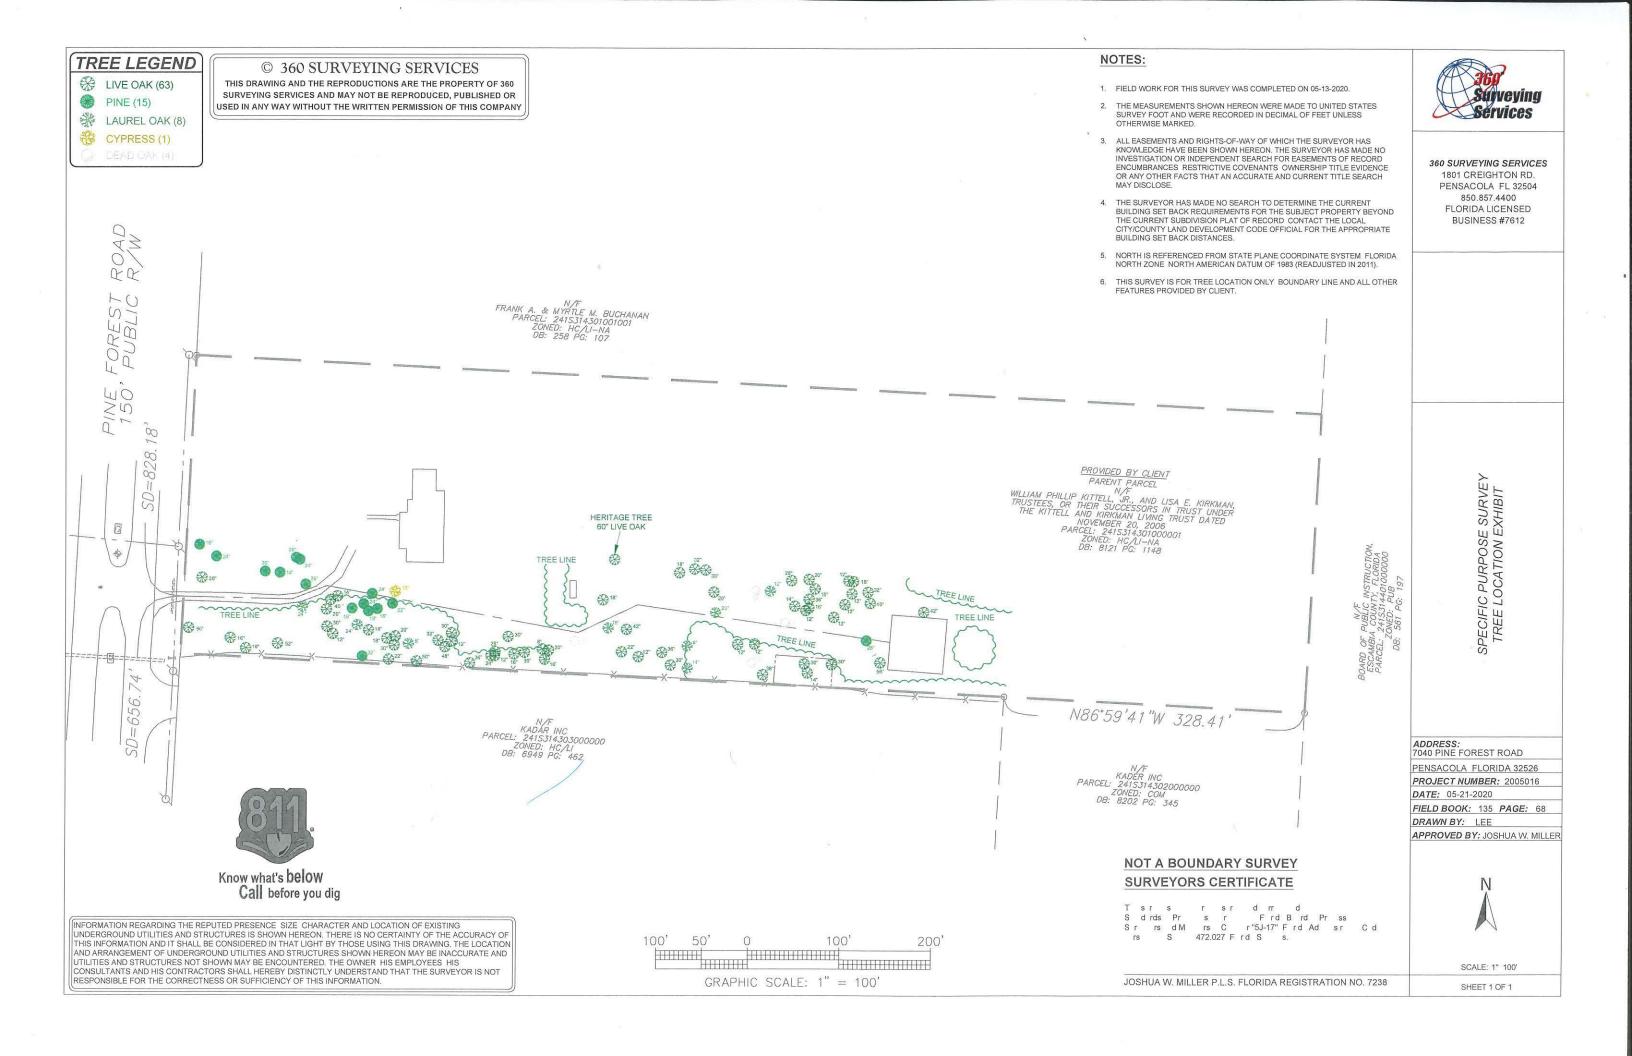

GENERAL NOTES:

THE GENERAL CONTRACTOR MUST VERIFY ALL DIMENSIONS, CONDITIONS AND ELEVATIONS BEFORE STARTING WORK. ALL DISCREPANCIES SHALL BE CALLED TO THE ATTENTION OF THE ENGINEER AND SHALL BE RESOLVED BEFORE PROCEEDING WITH THE WORK. ALL WORK SHALL BE PERFORMED IN A WORKMAN LIKE MANNER IN ACCORDANCE WITH ACCEPTED CONSTRUCTION PRACTICES.

IT IS THE INTENTION OF THESE DRAWINGS TO SHOW THE COMPLETED INSTALLATION. THE CONTRACTOR SHALL BE RESPONSIBLE FOR ALL TEMPORARY BRACING, SHORING, TIES, FORM WORK, ETC. IN ACCORDANCE WITH ALL NATIONAL, STATE, AND LOCAL ORDINANCES, TO SAFELY EXECUTE ALL WORK AND SHALL BE RESPONSIBLE FOR SAME. ALL WORK SHALL BE IN ACCORDANCE WITH LOCAL CODES.

THE CONTRACTOR SHALL USE ADEQUATE NUMBER OF SKILLED WORKMEN WHO ARE THOROUGHLY TRAINED AND EXPERIENCED IN THE NECESSARY CRAFTS AND WHO ARE COMPLETELY FAMILIAR WITH THE SPECIFIED REQUIREMENTS AND METHOD NEEDED FOR PROPER PERFORMANCE OF THE WORK.

CONSTRUCTION CONTRACTOR AGREES THAT IN ACCORDANCE WITH GENERALLY ACCEPTED CONSTRUCTION PRACTICES, CONSTRUCTION CONTRACTOR WILL BE REQUIRED TO ASSUME SOLE AND COMPLETE RESPONSIBILITY FOR JOB SITE CONDITIONS DURING THE COURSE OF CONSTRUCTION OF THE PROJECT, INCLUDING THE SAFETY OF ALL PERSONS AND PROPERTY. THIS REQUIREMENT SHALL BE MADE TO APPLY CONTINUOUSLY AND NOT BE LIMITED TO NORMAL WORKING HOURS. CONSTRUCTION CONTRACTOR FURTHER AGREES TO INDEMNIFY AND HOLD DESIGN ENGINEER HARMLESS FROM ANY AND ALL LIABILITY, REAL OR ALLEGED, IN CONNECTION WITH PERFORMANCE OF WORK ON THIS PROJECT.

SITE GROUNDING SHALL COMPLY WITH VERIZON WIRELESS GROUNDING STANDARDS, LATEST EDITION, AND COMPLY WITH VERIZON WIRELESS GROUNDING CHECKLIST, LATEST VERSION. WHEN NATIONAL AND LOCAL GROUNDING CODES ARE MORE STRINGENT THEY SHALL GOVERN.

ALL WORK SHALL COMPLY WITH OSHA AND STATE SAFETY REQUIREMENTS. PROCEDURES FOR THE PROTECTION OF EXCAVATIONS, EXISTING CONSTRUCTION AND UTILITIES SHALL BE ESTABLISHED PRIOR TO FOUNDATION INSTALLATION. IF TEMPORARY LIGHTING AND MARKING IS REQUIRED BY THE FEDERAL AVIATION ADMINISTRATION (FAA), IT IS THE CONTRACTOR'S RESPONSIBILITY TO MAINTAIN THE NECESSARY LIGHTS AND NOTIFY THE PROPER AUTHORITIES IN THE FYENT OF A PROBLEM.

ALL WORK SHALL BE ACCOMPLISHED IN ACCORDANCE WITH ALL LOCAL, STATE, AND FEDERAL CODES AND ORDINANCES. THE MOST STRINGENT CODE WILL APPLY IN THE CASE OF DISCREPANCIES OR DIFFERENCES IN THE CODE REQUIREMENTS.

ANY DAMAGE TO ADJACENT PROPERTIES SHALL BE CORRECTED AT THE CONTRACTOR'S EXPENSE.

THE CONTRACTOR IS RESPONSIBLE FOR PROVIDING AMPLE NOTICE TO THE BUILDING INSPECTION DEPARTMENT TO SCHEDULE THE REQUIRED INSPECTIONS. A MINIMUM OF 24 HOURS OF NOTICE SHALL BE GIVEN AND THE BUILDING INSPECTION DEPARTMENTS HAVE REQUESTED THAT GROUPS OF TWO OR THREE SITES BE SCHEDULED AT ONE TIME IF POSSIBLE.

CONSTRUCTION MANAGER WILL CONFIRM FAA APPROVAL OF TOWER LOCATION BY ISSUING TOWER RELEASE FORM. NO TOWER SHALL BE CONSTRUCTED UNTIL THE TOWER RELEASE FORM IS ISSUED TO THE CONTRACTOR.

THE COMPLETE BID PACKAGE INCLUDES THESE CONSTRUCTION DRAWINGS ALONG WITH THE FINAL RF DESIGN AND TOWER STRUCTURAL ANALYSIS. CONTRACTOR IS RESPONSIBLE FOR REVIEW OF TOTAL BID PACKAGE PRIOR TO BID STRUKTURAL.

CONTRACTOR SHALL VERIFY LOCATION OF ALL EXISTING UTILITIES WITHIN CONSTRUCTION LIMITS PRIOR TO CONSTRUCTION.

THE CONTRACTOR IS RESPONSIBLE FOR MAINTAINING POSITIVE DRAINAGE ON THE SITE AT ALL TIMES. SILT AND EROSION CONTROL SHALL BE MAINTAINED ON THE DOWNSTREAM SIDE OF THE SITE AT ALL TIMES. ANY DAMAGE TO ADJACENT PROPERTIES SHALL BE CORRECTED AT THE CONTRACTOR'S EXPENSE.

CLEARING OF TREES AND VEGETATION ON THE SITE SHOULD BE HELD TO A MINIMUM. ONLY THE TREES NECESSARY FOR CONSTRUCTION OF THE FACILITIES, AND IDENTIFIED ON SHEET EV-2 AS APPROVED FOR REMOVAL, SHALL BE REMOVED. ANY DAMAGE TO PROPERTY OUTSIDE THE LEASE PROPERTY SHALL BE REPAIRED BY THE CONTRACTOR.

ALL SUITABLE BORROW MATERIAL FOR BACK FILL OF THE SITE SHALL BE INCLUDED IN THE BID. EXCESS TOPSOIL AND UNSUITABLE MATERIAL SHALL BE DISPOSED OF OFF SITE AT LOCATIONS APPROVED BY GOVERNING AGENCIES PRIOR TO DISPOSA!

SEEDING AND MULCHING OF THE SITE SHALL BE ACCOMPLISHED AS SOON AS POSSIBLE AFTER COMPLETION OF THE SITE DEVELOPMENT. THE CONTRACTOR IS RESPONSIBLE FOR PROVIDING AND MAINTAINING AN ADEQUATE COVER OF VEGETATION OVER THE SITE FOR A ONE YEAR PERIOD.

PERMITS: OBTAIN AND PAY FOR REQUIRED PERMITS, LICENSES, FEES, INSPECTIONS, ETC.

RECORD DRAWINGS: MAINTAIN A RECORD OF ALL CHANGES, SUBSTITUTIONS BETWEEN WORK AS SPECIFIED AND INSTALLED. RECORD CHANGES ON A CLEAN SET OF CONTRACT DRAWINGS WHICH SHALL BE TURNED OVER TO THE CONSTRUCTION MANAGER UPON COMPLETION OF THE PROJECT.

THE CONTRACTOR SHALL VISIT THE SITE BEFORE BIDDING ON THE WORK CONTAINED IN THIS DESIGN PACKAGE.

ENVIRONMENTAL NOTES:

NO PROTECTED TREES WILL BE REMOVED OR ADVERSELY IMPACTED BY THIS DEVELOPMENT UNLESS AUTHORIZED BY ESCAMBIA COUNTY THROUGH APPROVAL OF THIS SITE DEVELOPMENT PLAN.

ALL "LAND DISTURBANCE ACTIVITIES" OR OTHER SITE ACTIVITIES, OR WORK SHALL NOT OCCUR ONSITE UNTIL ALL DEVELOPMENT APPROVALS AND APPROPRIATE PERMITS HAVE BEEN ISSUED BY ESCAMBIA COUNTY."

TREES AND VEGETATION REQUIRED TO BE PLANTED PER PLANNER/PLANNING & ZONING REVIEW COMMENTS, REQUIREMENTS OR OTHERWISE, ALL SHALL FOLLOW LANDSCAPING STANDRDS UNDER THE LAND DEVELOPMENT CODE (LDC), DESIGN STANDARD MANUAL (DSM), CHAPTER 2 ENVIRONMENTAL ARTICLE 2 LANDSCAPING, SPECIFICALLY SEC 2-6 PLANT SELECTION, INSTALLATION & IRRIGATION

EXCAVATION & GRADING NOTES:

- 1. ALL CUT AND FILL SLOPES SHALL BE 3: 1 MAXIMUM.
- ALL EXCAVATIONS ON WHICH CONCRETE IS TO BE PLACED SHALL BE SUBSTANTIALLY HORIZONTAL ON UNDISTURBED AND UNFROZEN SOIL AND BE FREE FROM LOOSE MATERIAL AND EXCESS GROUND WATER. DEWATERING FOR EXCESS GROUND WATER SHALL BE PROVIDED IF REQUIRED.
- 3. CONCRETE FOUNDATIONS SHALL NOT BE PLACED ON ORGANIC MATERIAL. IF SOUND SOIL IS NOT REACHED AT THE DESIGNATED EXCAVATION DEPTH, THE UNSATISFACTORY SOIL SHALL BE EXCAVATED TO ITS FULL DEPTH AND EITHER BE REPLACED WITH MECHANICALLY COMPACTED GRANULAR MATERIAL OR THE EXCAVATION BE FILLED WITH CONCRETE OF THE SAME QUALITY SPECIFIED FOR THE FOUNDATION.
- 4. ANY EXCAVATION OVER THE REQUIRED DEPTH SHALL BE FILLED WITH EITHER MECHANICALLY COMPACTED GRANULAR MATERIAL OF CONCRETE OF THE SAME QUALITY SPECIFIED FOR THE FOUNDATION. CRUSHED STONE MAY BE USED TO STABILIZE THE BOTTOM OF THE EXCAVATION. STONE, IF USED, SHALL NOT BE USED AS COMPILING CONCRETE THICKNESS.
- 5. AFTER COMPLETION OF THE FOUNDATION AND OTHER CONSTRUCTION BELOW GRADE, AND BEFORE BACK
 FILLING, ALL EXCAVATIONS SHALL BE CLEAN OF UNSUITABLE MATERIAL SUCH AS VEGETATION, TRASH, DEBRIS, AND
 SO ECOTIF
- 6. BACK FILL SHALL BE:
 - APPROVED MATERIALS CONSISTING OF EARTH, LOAM, SANDY CLAY, SAND, GRAVEL, OR SOFT SHALE;
 - FREE FROM CLODS OR STONES OVER 2-1/2" MAXIMUM DIMENSIONS;
 - IN LAYERS AND COMPACTED.
- 7. SITE FILL MATERIAL AND FOUNDATION BACK FILL SHALL BE PLACED IN LAYERS, MAXIMUM 6" DEEP BEFORE COMPACTION. EACH LAYER SHALL BE SPRINKLED IF REQUIRED AND COMPACTED BY HAND OPERATED OR MACHINE TAMPERS TO 95% OF MAXIMUM DENSITY, AT THE OPTIMUM MOISTURE CONTENT 2% AS DETERMINED BY ASTM DESIGNATION D-698, UNLESS OTHERWISE APPROVED. SUCH BACK FILL SHALL NOT BE PLACED BEFORE 3 DAYS AFTER PLACEMENT OF CONCRETE.
- 8. THE FOUNDATION AREA SHALL BE GRADED TO PROVIDE WATER RUNOFF AND PREVENT WATER FROM STANDING. THE FINAL GRADE SHALL SLOPE AWAY IN ALL DIRECTIONS FROM THE FOUNDATION AND SHALL THEN BE COVERED WITH 4" DEEP COMPACTED STONE OR GRAVEL.
- 9. CONTRACTOR SHALL PROVIDE ALL EROSION AND SEDIMENTATION CONTROL MEASURES AS REQUIRED BY LOCAL CITY, COUNTY AND STATE CODES AND ORDINANCES TO PROTECT EMBANKMENTS FROM SOIL LOSS AND TO PREVENT ACCUMULATION OF SOIL AND SILT IN STREAMS AND DRAINAGE PATHS LEAVING THE CONSTRUCTION AREA. THIS MAY INCLUDE SUCH MEASURES AS SILT FENCES, STAW BALLE SEDIMENT BARRIERS AND CHECK DAMS.
- 10. FILL PREPARATION: REMOVE ALL VEGETATION, TOPSOIL, DEBRIS, WET AND UNSATISFACTORY SOIL MATERIALS, OBSTRUCTIONS, AND DELETERIOUS MATERIALS FROM GROUND SURFACE PRIOR TO PLACING FILLS. PLOW STRIP OR BREAK UP SLOPED SURFACES STEEPER THAT 1 VERTICAL TO 4 HORIZONTAL SO FILL MATERIAL WILL BOND WITH EXISTING SURFACE. WHEN SUBGRADE OR EXISTING GROUND SURFACE TO RECEIVE FILL HAS A DENSITY LESS THAN THAT REQUIRED FOR FILL, BREAK UP GROUND SURFACE TO DEPTH REQUIRED, PULVERIZE, MOISTURE-CONDITION OR ARRATE SOIL AND RECOMPACT TO REQUIRED DENSITY.
- 11. REPLACE THE EXISTING WEARING SURFACE ON AREAS WHICH HAVE BEEN DAMAGED OR REMOVED DURING CONSTRUCTION OPERATIONS. SURFACE SHALL BE REPLACE TO MATCH EXISTING ADJACENT SURFACING AND SHALL BE OF THE SAME THICKNESS. NEW SURFACE SHALL BE FREE FROM CORRUGATIONS AND WAVES. EXISTING SURFACING MAY BE EXCAVATED SEPARATELY AND REUSED IF INJURIOUS AMOUNTS OF EARTH, ORGANIC MATERIAL, OF OTHER DELETERIOUS MATERIALS ARE REMOVED PRIOR TO REUSE. FURNISH ALL ADDITIONAL RESURFACING MATERIAL AS REQUIRED. BEFORE SURFACING IS REPLACED, SUBGRADE SHALL BE GRADED TO CONFORM TO REQUIRED SUBGRADE ELEVATIONS, AND LOOSE OR DISTURBED MATERIALS SHALL BE THOROUGHLY COMPACTED. DEPRESSIONS IN THE SUBGRADE SHALL BE FILLED AND COMPACTED WITH APPROVED SELECTED MATERIAL. SURFACING SHALL NOT BE USED FOR FILLING DEPRESSIONS TO THE SUBGRADE.
- 12. PROTECT EXISTING SURFACING AND SUBGRADE IN AREAS WHERE EQUIPMENT LOADS WILL OPERATE. USE PLANKING OR OTHER SUITABLE MATERIALS DESIGNED TO SPREAD EQUIPMENT LOADS. REPAIR DAMAGE TO EXISTING GRAVEL SURFACING OR SUBGRADE WHERE SUCH DAMAGE IS DUE TO THE CONTRACTOR'S OPERATIONS. DAMAGED GRAVEL SURFACING SHALL BE RESTORED TO MATCH THE ADJACENT UNDAMAGED GRAVEL SURFACING AND SHALL BE OF THE SAME THICKNESS.
- 13. DAMAGE TO EXISTING STRUCTURES AND UTILITIES RESULTING FROM CONTRACTOR'S NEGLIGENCE SHALL BE REPAIRED / REPLACED TO OWNER'S SATISFACTION AT CONTRACTOR'S EXPENSE.
- 14. CONTRACTOR SHALL COORDINATE THE CONSTRUCTION SCHEDULE WITH PROPERTY OWNER SO AS TO AVOID INTERRUPTIONS TO PROPERTY OWNER'S OPERATIONS.
- 15. ENSURE POSITIVE DRAINAGE DURING AND AFTER COMPLETION OF CONSTRUCTION.
- 16. RIPRAP SHALL BE CLEAN, HARD, SOUND, DURABLE, UNIFORM IN QUALITY, AND FREE OF ANY DETRIMENTAL QUANTITY OF SOFT, FRIABLE, THIN, ELONGATED OR LAMINATED PIECES, DISINTEGRATED MATERIAL, ORGANIC MATTER, OIL, ALKALI, OR OTHER DELETERIOUS SUBSTANCE.

LEGEND

———X———	FENCE
[550]	CONTOUR LINE
·	PROPERTY LINE / ROW
	LEASE AREA
	EASEMENT
	DISCONNECT SWITCH
\triangle \bigcirc	METER
-60-	CIRCUIT BREAKER
X	CODED NOTE NUMBER
	CHEMICAL GROUND ROD
\otimes	GROUND ROD
	GROUND ROD WITH INSPECTION SLEEVE
MI.	CADWELD TYPE CONNECTION
0	COMPRESSION TYPE CONNECTION

GROUND WIRE





DUNAWAY

7038 PINE FOREST ROAD PENSACOLA, FL 32526

LOCATION CODE: 279068


NO.	DATE	REVISIONS	BY
Α	04/16/20	PRELIM LE	JY
В	05/26/20	PRELIM LE	JY
C	07/28/20	PRELIM LE	JY
0	11/05/20	FINAL ZDs	JY
1	12/18/20	JDX COMMENTS	DA
2	12/24/20	JDX COMMENTS	DA
3	01/29/21	JDX COMMENTS	DA
4	02/03/21	SW COMMENTS	DA
5	03/26/21	ENVIRON. COMMENTS	DA
6	06/11/21	DRC COMMENTS	DA
		11 11 11 11 11 11 11 11 11 11 11 11 11	
_			



DESIGNED: JY DRAWN: JY CHECKED: DA

JOB#: 20_V3N_041

GENERAL NOTES

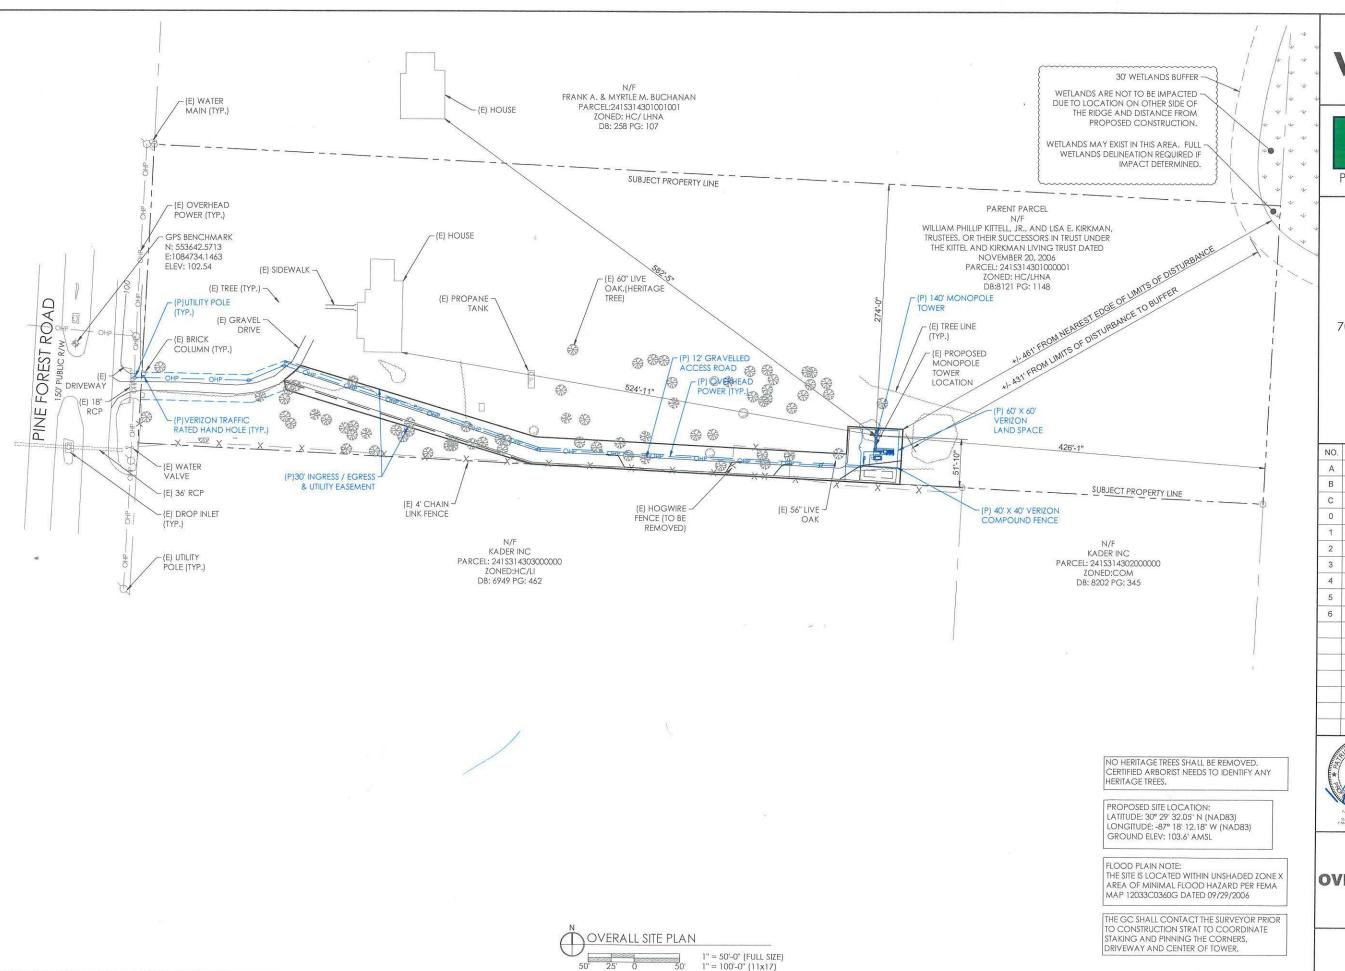





DUNAWAY

7038 PINE FOREST ROAD PENSACOLA, FL 32526

LOCATION CODE: 279068


NO.	DATE	REVISIONS	BY
Α	04/16/20	PRELIM LE	JY
В	05/26/20	PRELIM LE	JY
С	07/28/20	PRELIM LE	JY
0	11/05/20	FINAL ZDs	JY
1	12/18/20	JDX COMMENTS	DA
2	12/24/20	JDX COMMENTS	DA
3	01/29/21	JDX COMMENTS	DA
4	02/03/21	SW COMMENTS	DA
5	03/26/21	ENVIRON. COMMENTS	DA
6	06/11/21	DRC COMMENTS	DA
		-	



DESIGNED: JY
DRAWN: JY
CHECKED: DA

JOB #: 20_V3N_041

OVERALL SITE PLAN

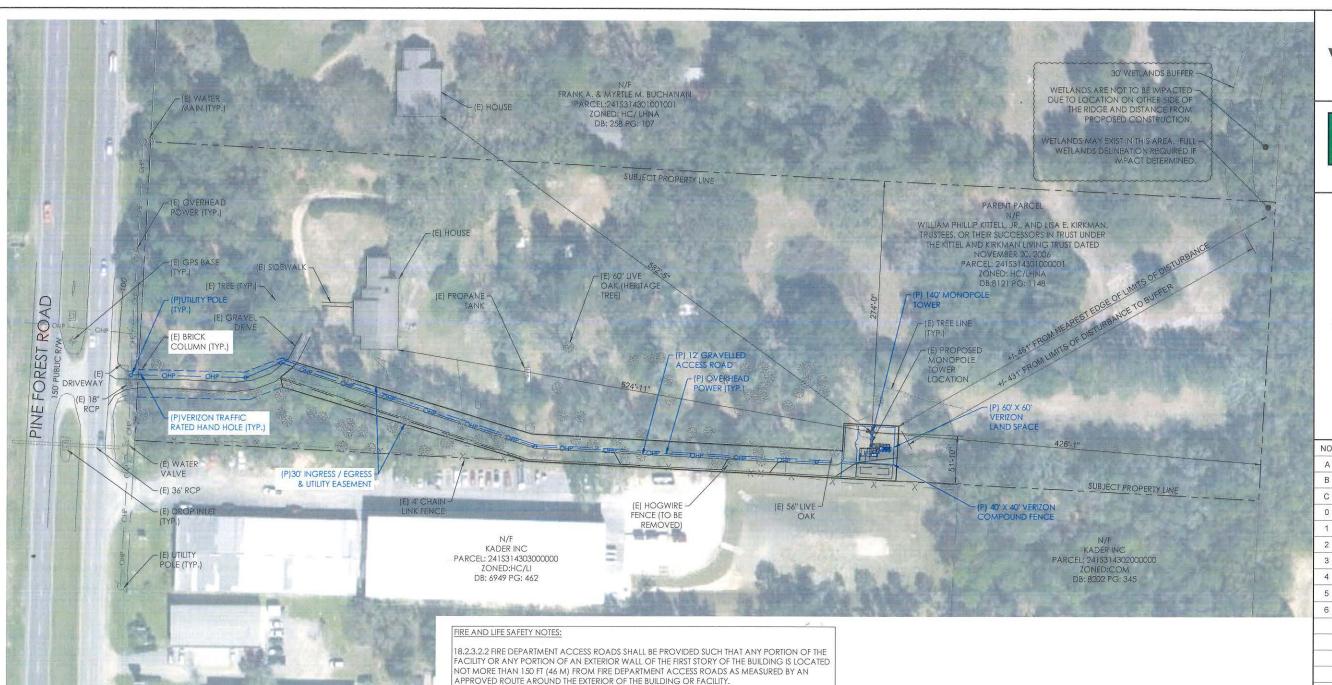

APPROVED ROUTE AROUND THE EXTERIOR OF THE BUILDING OR FACILITY.

8.2.3.4.1.1 FIRE DEPARTMENT ACCESS ROADS SHALL HAVE AN UNOBSTRUCTED WIDTH OF NOT LESS THAN 20 FT (6.1M).

18.2.3.4.1.2 FIRE DEPARTMENT ACCESS ROADS SHALL HAVE AN UNOBSTRUCTED VERTICAL CLEARANCE OF NOT LESS THAN 13 FT 6 IN. (4.1 M).

E) FIRE HYDRANT (ID #8195)

APPROXIMATELY 450' SOUTH OF EXISTING ACCESS DRIVE.

18.2.3.4.2 SURFACE. FIRE DEPARTMENT ACCESS ROADS SHALL BE DESIGNED AND MAINTAINED TO SUPPORT THE IMPOSED LOADS OF FIRE APPARATUS AND SHALL BE PROVIDED WITH AN ALL-WEATHER DRIVING SURFACE. MINIMUM OF 40 TONS.

18.3.1 * AN APPROVED WATER SUPPLY CAPABLE OF SUPPLYING THE REQUIRED FIRE FLOW FOR FIRE PROTECTION SHALL BE PROVIDED TO ALL PREMISES UPON WHICH FACILITIES, BUILDINGS, OR PORTIONS OF BUILDINGS ARE HEREAFTER CONSTRUCTED OR MOVED INTO THE JURISDICTION. THE APPROVED WATER SUPPLY SHALL BE IN ACCORDANCE WITH SECTION 18.4. CLOSEST FIRE HYDRANT SHOWN ON THIS SHEET -- APPROXIMATELY 450' SOUTH OF EXISTING ACCESS DRIVE ALONG PINE FOREST RD / IN FRONT OF 7012 PINE FOREST RD. PENDING CURRENT FIRE HYDRANT FLOW TEST DATA.

> OVERALL SITE PLAN W/ MAP 1" = 50'-0" (FULL SIZE) 1" = 100'-0" (11x17)

NO HERITAGE TREES SHALL BE REMOVED. CERTIFIED ARBORIST NEEDS TO IDENTIFY ANY HERITAGE TREES.

PROPOSED SITE LOCATION: LATITUDE: 30° 29' 32.05" N (NAD83) LONGITUDE: -87° 18' 12.18" W (NAD83) GROUND ELEV: 103.6' AMSL

FLOOD PLAIN NOTE: THE SITE IS LOCATED WITHIN UNSHADED ZONE X AREA OF MINIMAL FLOOD HAZARD PER FEMA MAP 12033C0360G DATED 09/29/2006

THE GC SHALL CONTACT THE SURVEYOR PRIOR TO CONSTRUCTION STRAT TO COORDINATE STAKING AND PINNING THE CORNERS DRIVEWAY AND CENTER OF TOWER.





DUNAWAY

7038 PINE FOREST ROAD PENSACOLA, FL 32526

> LOCATION CODE: 279068

		Committee of the Commit		
NO.	DATE	REVISIONS	BY	
Α	04/16/20	PRELIM LE	JY	
В	05/26/20 PRELIM LE			
С	07/28/20	PRELIM LE	JY	
0	11/05/20	FINAL ZDs	JY	
1	12/18/20	JDX COMMENTS	DA	
2	12/24/20	JDX COMMENTS	DA	
3	01/29/21	JDX COMMENTS	DA	
4	02/03/21	SW COMMENTS	DA	
5	03/26/21	ENVIRON. COMMENTS	DA	
6	06/11/21	DRC COMMENTS	DA	





DESIGNED: JY RAWN: JY CHECKED: DA


> JOB #: 20_V3N_041

OVERALL SITE PLAN W/ MAP

C-2A

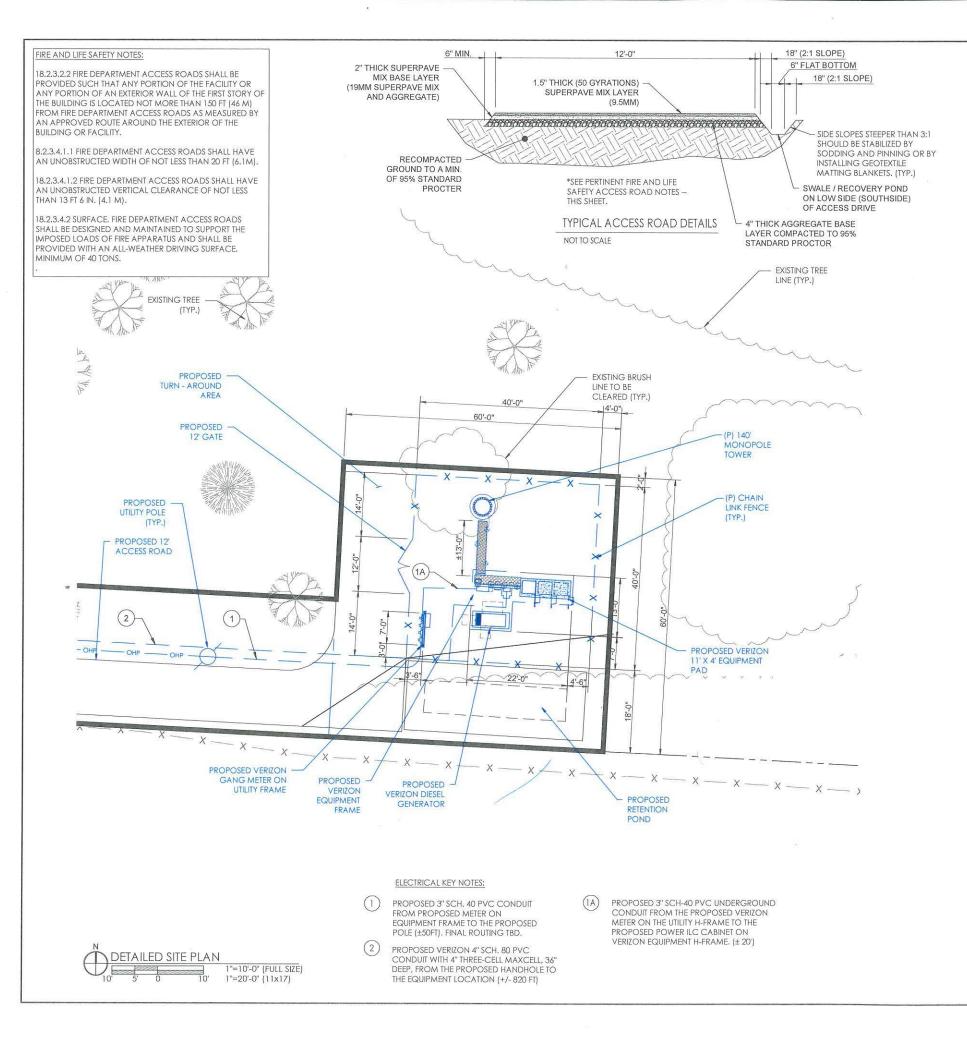


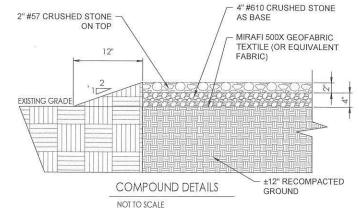

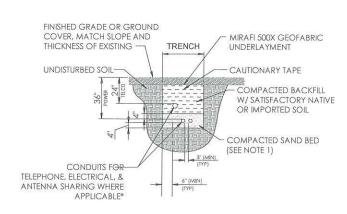

* CONDUIT SIZE, TYPE, QUANTITY AND SEPARATION DIMENSION TO BE VERIFIED WITH LOCAL UTILITY COMPANY REQUIREMENTS

DIRECT BURIED CONDUIT

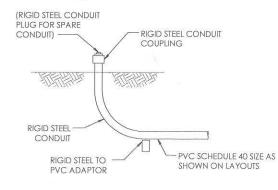

UNDERGROUND CONDUIT STUB-UP





DUNAWAY

7038 PINE FOREST ROAD PENSACOLA, FL 32526

LOCATION CODE: 279068


NO.	DATE	REVISIONS	BY
Α	04/16/20	PRELIM LE	JY
В	05/26/20	PRELIM LE	JY
С	07/28/20	PRELIM LE	JY
0	11/05/20	FINAL ZDs	JY
1	12/18/20	JDX COMMENTS	DA
2	12/24/20	JDX COMMENTS	DA
3	01/29/21	JDX COMMENTS	DA
4	02/03/21	SW COMMENTS	DA




DESIGNED: JY
DRAWN: JY
CHECKED: DA

JOB #: 20_V3N_041

DETAILED SITE PLAN

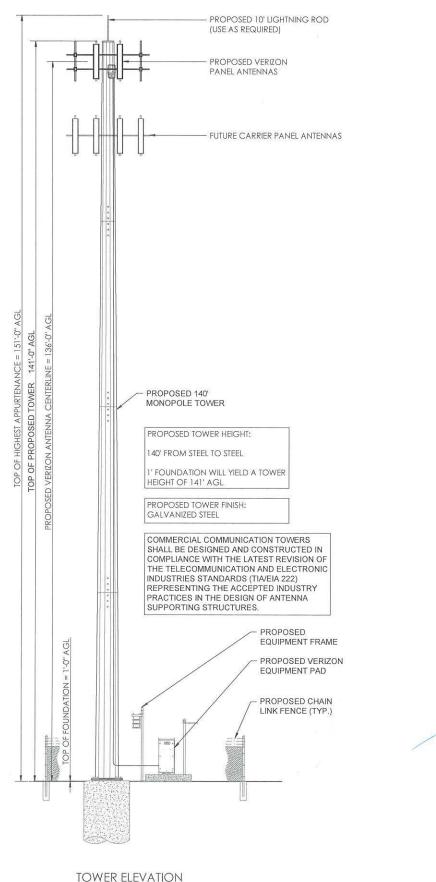




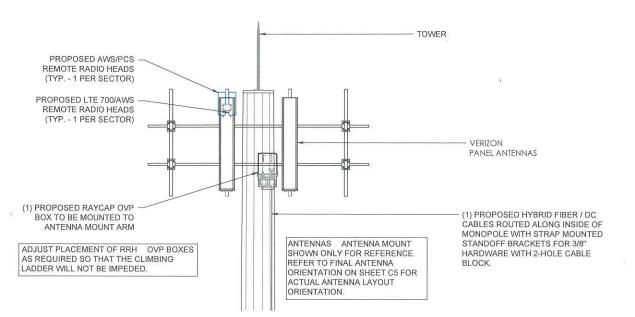

RRH & OVP MOUNTING DETAIL

NOT TO SCALE

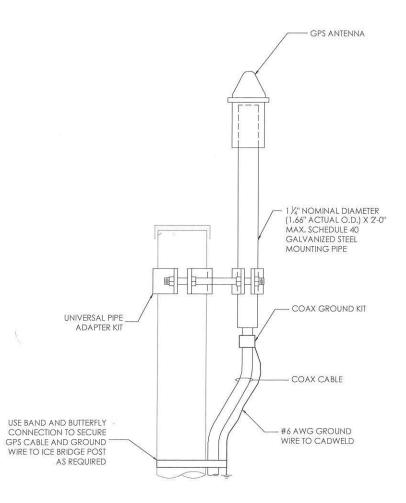

GPS ANTENNA MOUNTING DETAIL

NOT TO SCALE





DUNAWAY

7038 PINE FOREST ROAD PENSACOLA, FL 32526

> LOCATION CODE: 279068

NO.	DATE	REVISIONS	BY
Α	04/16/20	PRELIM LE	JY
В	05/26/20	PRELIM LE	JY
С	07/28/20	PRELIM LE	JY
0	11/05/20	FINAL ZDs	JY
1	12/18/20	JDX COMMENTS	DA
			-
	W MASO	DESIGNED: JY	<u> </u>
PA	No. 53573	DRAWN: JY	



CHECKED: DA

20_V3N_041


TOWER ELEVATION

-	3	250	1)	NHH-65C-R2B	0		/-7'
100	1,000	250	1	NHH-65C-R2B PROPOSED COMMSCOPE			/-12' (1) 1x2 CABLE
136' 2	2	130	1	PROPOSED COMMSCOPE	0		(1) 1x2 CABLE
	i	10	1	PROPOSED COMMSCOPE NHH-65C-R2B	0		(1) 1x2 CABLE /-11'
RAD CENTER	SECTOR	AZIMUTH (DEGREES)	QUANT.	850 LTE ANTENNAS	MECHANICAL DOWNTILT		1x2 HYBRID CABLE LENGT
	3	250	SHARED	SHARED W/ 700 LTE & 850 LTE	0		FIBER JUMPERS
136'	2	130	SHARED	SHARED W/ 700 LTE & 850 LTE	0		(SHARED) (1X2) HYBRID DC/ FIBER JUMPERS
	1	10	SHARED	SHARED W/ 700 LTE & 850 LTE	0		
RAD CENTER	SECTOR	AZIMUTH (DEGREES)	QUANT.	PCS (1900 MHZ) ANTENNAS	MECHANICAL DOWNTILT	(1) 6x12 HYBRID FIBER / DC CABLE LENGTH OF CABLE * LENGTH: ±160' *	1x2 HYBRID CABLE LENGT
	3	250	1	PROPOSED COMMSCOPE NHH-65C-R2B	0		(1) 1x2 CABLI /-7'
136'	2	130	1	PROPOSED COMMSCOPE NHH-65C-R2B	0		(1) 1x2 CABLE /-12'
	1	10	1	PROPOSED COMMSCOPE NHH-65C-R2B	0		(1) 1x2 CABLE /-11'
RAD CENTER	SECTOR	AZIMUTH (DEGREES)	QUANT.	LTE (700 MHZ) ANTENNAS	MECHANICAL DOWNTILT		1x2 HYBRID CABLE LENGT
	3	250	SHARED	SHARED W/ 700 LTE & 850 LTE	0		TIDEN SOM EN
136'	2	130	SHARED	SHARED W/ 700 LTE & 850 LTE	0		(SHARED) (1X2 HYBRID DC/ FIBER JUMPERS
1	1	10	SHARED	SHARED W/ 700 LTE & 850 LTE	0		200
RAD CENTER	SECTOR	AZIMUTH (DEGREES)	QUANT.	AWS (2100 MHZ) ANTENNAS	MECHANICAL DOWNTILT	6x12 HYBRID CABLE	1x2 HYBRID CABLE LENGT

QUANTITY	antenna mounts			
1	PROPOSED PERFECT VISION ANTENNA MOUNT			
QUANTITY	OVP			
1	PROPOSED 12-CIRCUIT RAYCAP OVP (ANTENNA LEVEL)			
1	PROPOSED 12-CIRCUIT RAYCAP OVP (GROUND LEVEL)			
QUANTITY	RRH□			
3	PROPOSED NOKIA AHBCC AIRSCALE DUAL RRH 4T4R B5/B13 320W			
3 PROPOSED NOKIA AHFIC AIRSCALE DUAL RRH 4T4R B2/B66A 32				

CONTRACTOR TO MATCH
THE LENGTHS OF 1x2
HYBRID JUMPERS WITH THE
CORRECT SECTORS AS
REQUIRED. RRH'S & OVP'S
TO BE MOUNTED IN A
MANNER NOT TO INTERFERE
WITH THE TOWER CLIMBING
APPARATUS

VERIZON APPROVED PERFECT VISION ANTENNA MOUNT TO BE USED

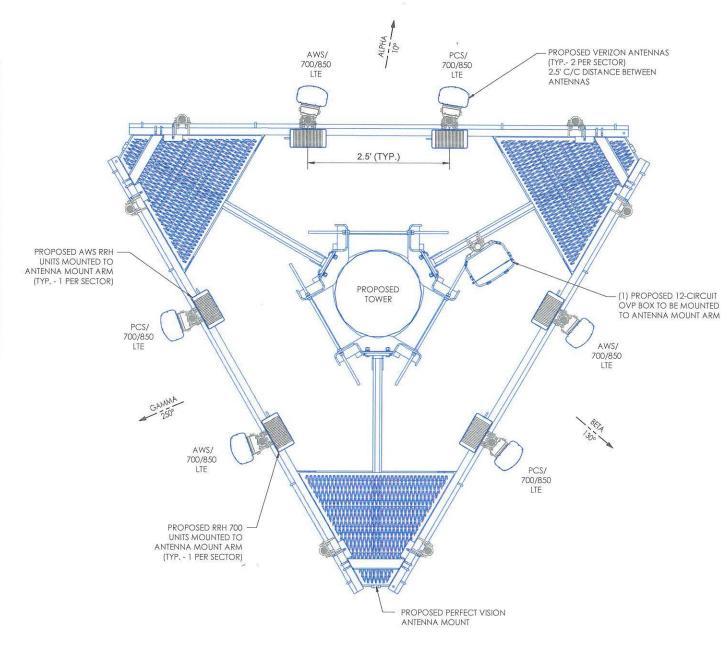

ANTENNA ORIENTATION
NOT TO SCALE





DUNAWAY

7038 PINE FOREST ROAD PENSACOLA, FL 32526

LOCATION CODE: 279068


NO.	DATE	REVISIONS	BY
Α	04/16/20	PRELIM LE	JY
В	05/26/20	PRELIM LE	JY
С	07/28/20	PRELIM LE	JY
0	11/05/20	FINAL ZDs	JY
1	12/18/20	JDX COMMENTS	DA
			1-0-1-1
		-11	
_			
			1
	W MA	DOLONED: N	



DESIGNED: JY DRAWN: JY CHECKED: DA

> JOB#: 20_V3N_041

ANTENNA ORIENTATION

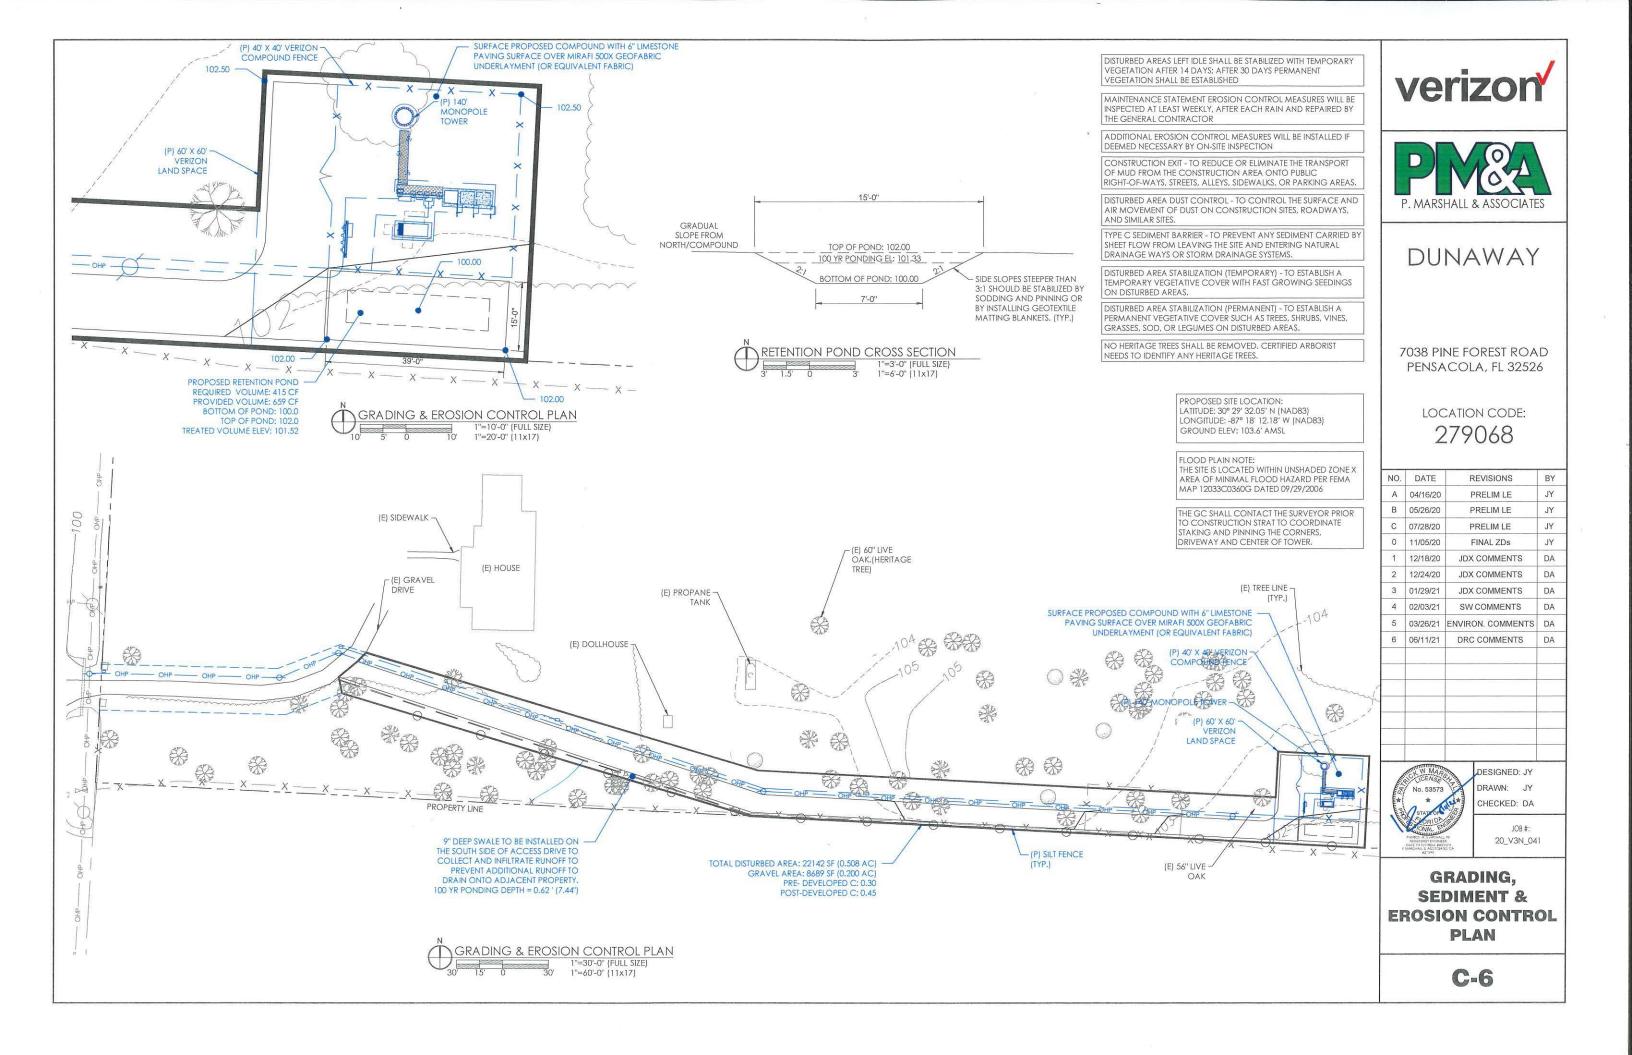

NOTES:

- THE PROJECT ENGINEER (ENGINEER OF RECORD) SHALL PROVIDE TO ESCAMBIA COUNTY "AS-BUILT" RECORD DRAWINGS FOR VERIFICATION AND APPROVAL BY ESCAMBIA COUNTY ONE WEEK PRIOR TO REQUESTING A FINAL INSPECTION AND CERTIFICATE OF OCCUPANCY, OR PROVIDE "AS-BUILT" CERTIFICATION THAT THE PROJECT CONSTRUCTION ADHERES TO THE PERMITTED PLANS AND SPECIFICATIONS. THE "AS-BUILT" CERTIFICATION OR THE "AS-BUILT" RECORD DRAWINGS MUST BE SIGNED, SEALED AND DATED BY A REGISTERED FLORIDA PROFESSIONAL ENGINEER.
- ALL ASPECTS OF THE STORMWATER/DRAINAGE COMPONENTS AND/OR TRANSPORTATION COMPONENTS SHALL BE COMPLETED PRIOR TO ISSUANCE OF A FINAL CERTIFICATE OF OCCUPANCY.
- NO DEVIATIONS OR REVISIONS FROM THESE PLANS BY THE CONTRACTOR SHALL BE ALLOWED WITHOUT PRIOR APPROVAL
 FROM BOTH THE DESIGN ENGINEER AND THE ESCAMBIA COUNTY. ANY DEVIATIONS MAY RESULT IN DELAYS IN OBTAINING A
 CERTIFICATE OF OCCUPANCY.
- 4. THE CONTRACTOR SHALL INSTALL PRIOR TO THE START OF CONSTRUCTION AND MAINTAIN DURING CONSTRUCTION ALL SEDIMENT CONTROL MEASURES AS REQUIRED TO RETAIN ALL SEDIMENTS ON THE SITE. IMPROPER SEDIMENT CONTROL MEASURES MAY RESULT IN CODE ENFORCEMENT VIOLATION.
- RETENTION/DETENTION AREAS SHALL BE SUBSTANTIALLY COMPLETE PRIOR TO ANY CONSTRUCTION ACTIVITIES THAT MAY INCREASE STORMWATER RUNOFF RATES. THE CONTRACTOR SHALL CONTROL STORMWATER DURING ALL PHASES OF CONSTRUCTION AND TAKE ADEQUATE MEASURES TO PREVENT THE EXCAVATED POND FROM BLINDING DUE TO SEDIMENTS.
- ALL DISTURBED AREAS WHICH ARE NOT PAVED SHALL BE STABILIZED WITH SEEDING, FERTILIZER AND MULCH, HYDROSEED AND/OR SOD.
- DEVELOPER/CONTRACTOR SHALL RESHAPE PER PLAN SPECIFICATIONS, CLEAN OUT ACCUMULATED SILT, AND STABILIZE
 RETENTION/DETENTION POND(S) AT THE END OF CONSTRUCTION WHEN ALL DISTURBED AREAS HAVE BEEN STABILIZED AND
 PRIOR TO REQUEST FOR INSPECTION.
- CONTRACTOR SHALL MAINTAIN RECORD DRAWINGS DURING CONSTRUCTION WHICH SHOW "AS-BUILT" CONDITIONS OF ALL
 WORK INCLUDING PIPING, DRAINAGE STRUCTURES, TOPO OF POND(S), OUTLET STRUCTURES, DIMENSIONS, ELEVATIONS,
 GRADING ETC. RECORD DRAWINGS SHALL BE PROVIDED TO THE ENGINEER OF RECORD PRIOR TO REQUESTING FINAL
 INSPECTION.
- THE OWNER OR HIS AGENT SHALL ARRANGE/SCHEDULE WITH THE COUNTY A FINAL INSPECTION OF THE DEVELOPMENT UPON
 COMPLETION AND ANY INTERMEDIATE INSPECTIONS AT (850) 595-3472. AS-BUILT CERTIFICATION IS REQUIRED PRIOR TO
 REQUEST FOR FINAL INSPECTION/APPROVAL.
- 10. NOTIFY SUNSHINE UTILITIES 48 HOURS IN ADVANCE PRIOR TO DIGGING WITHIN R/W; 1-800-432-4770.
- ANY DAMAGE TO EXISTING ROADS DURING CONSTRUCTION WILL BE REPAIRED BY THE DEVELOPER PRIOR TO FINAL "AS-BUILT SIGN OFF FROM THE COUNTY.
- 12. THERE WILL BE NO IMPACT TO THE ADJACENT PROPERTIES OR DRAINAGE SYSTEMS FOR THE POST DEVELOPMENT CONDITIONS.
- 13. THE CONTRACTOR SHALL NOTIFY FDOT 48 HOURS IN ADVANCE PRIOR TO INITIATING ANY WORK IN THE STATE RIGHT-OF-WAY.

RIGHT-OF-WAY NOTES:

 WORK PROPOSED NEXT TO THE R/W WITH EXISTING SWALES SYSTEMS MAY REQUIRE ADDITIONAL PROVISIONS TO REPAIR / RESTORE EXISTING DRAINAGE SWALES AS NEEDED TO ENSURE ADEQUATE DRAINAGE. R/W SHOULDER STABILIZATION SHOULD BE IN ACCORDANCE WITH FDOT STANDARD SPECIFICATIONS FOR ROAD AND BRIDGE CONSTRUCTION LATEST EDITION.

DRAINAGE NOTES:

- THE SITE IS RELATIVELY FLAT. THERE IS MINIMUM GRADING PROPOSED ON THIS SITE TO MAINTAIN THE EXISTING DRAINAGE PATTERN AND REDUCE IMPACTS ON EXISTING MATURE TREES ONSITE THERE IS A LOCALIZED HIGH POINT ON THE SITE JUST NORTH OF THE COMPOUND. RUNOFF FROM THE SITE DRAINS SOUTH INTO THE PROPOSED RETENTION POND. A SWALE IS TO BE CONSTRUCTED SOUTH OF THE ACCESS DRIVE TO ALLOW FOR INFILTRATION OF RUNOFF FROM THE ACCESS DRIVE. ANY EXCESS RUNOFF CONTINUES TO DRAIN SOUTH/SOUTH WEST TOWARDS PINE FOREST ROAD, CONTINUING ACROSS PINE FOREST ROAD VIA EXISTING CULVERTS INTO AN UNNAMED TRIBUTARY OF EIGHT MILE CREEK, JOINING ELEVEN MILE CREEK AND ULTIMATELY DISCHARGING INTO THE GULF OF MEXICO.
- THE PROPOSED RETENTION POND AND "SWALE" ARE DESIGNED TO RETAIN AND INFILTRATE ALL PROPOSED STONE SURFACE IMPROVEMENTS. SEE RETENTION POND CALCULATIONS ON SHEET C-7.
- SINCE RUNOFF HAS BEEN DESIGNED TO BE RETAINED AND INFILTRATED ONSITE, THERE ARE NO ADVERSE IMPACTS DUE TO THE CONSTRUCTION/DEVELOPMENT OF THIS PROJECT TO ADJACENT PARCELS OR DRAINAGE BASIN.

DISTURBED AREAS LEFT IDLE SHALL BE STABILIZED WITH TEMPORARY VEGETATION AFTER 14 DAYS; AFTER 30 DAYS PERMANENT VEGETATION SHALL BE ESTABLISHED

MAINTENANCE STATEMENT EROSION CONTROL MEASURES WILL BE INSPECTED AT LEAST WEEKLY, AFTER EACH RAIN AND REPAIRED BY THE GENERAL CONTRACTOR

ADDITIONAL EROSION CONTROL MEASURES WILL BE INSTALLED IF DEEMED NECESSARY BY ON-SITE INSPECTION

CONSTRUCTION EXIT - TO REDUCE OR ELIMINATE THE TRANSPORT OF MUD FROM THE CONSTRUCTION AREA ONTO PUBLIC RIGHT-OF-WAYS, STREETS, ALLEYS, SIDEWALKS, OR PARKING AREAS.

DISTURBED AREA DUST CONTROL - TO CONTROL THE SURFACE AND AIR MOVEMENT OF DUST ON CONSTRUCTION SITES, ROADWAYS, AND SIMIL AP SITES

TYPE C SEDIMENT BARRIER - TO PREVENT ANY SEDIMENT CARRIED BY SHEET FLOW FROM LEAVING THE SITE AND ENTERING NATURAL DRAINAGE WAYS OR STORM DRAINAGE SYSTEMS.

DISTURBED AREA STABILIZATION (TEMPORARY) - TO ESTABLISH A TEMPORARY VEGETATIVE COVER WITH FAST GROWING SEEDINGS ON DISTURBED AREAS.

DISTURBED AREA STABILIZATION (PERMANENT) - TO ESTABLISH A PERMANENT VEGETATIVE COVER SUCH AS TREES, SHRUBS, VINES, GRASSES, SOD, OR LEGUMES ON DISTURBED AREAS.

NO HERITAGE TREES SHALL BE REMOVED. CERTIFIED ARBORIST NEEDS TO IDENTIFY ANY HERITAGE TREES.

PROPOSED SITE LOCATION: LATITUDE: 30° 29' 32.05" N (NAD83) LONGITUDE: -87° 18' 12.18" W (NAD83) GROUND ELEV: 103.6' AMSL

FLOOD PLAIN NOTE:
THE SITE IS LOCATED WITHIN UNSHADED ZONE X
AREA OF MINIMAL FLOOD HAZARD PER FEMA
MAP 12033C0360G DATED 09/29/2006

THE GC SHALL CONTACT THE SURVEYOR PRIOR TO CONSTRUCTION STRAT TO COORDINATE STAKING AND PINNING THE CORNERS, DRIVEWAY AND CENTER OF TOWER.





DUNAWAY

7038 PINE FOREST ROAD PENSACOLA, FL 32526

LOCATION CODE: 279068

REVISIONS

PRELIM LE

PRELIM LE

PRELIM LE

FINAL ZDs

JDX COMMENTS

JDX COMMENTS

JDX COMMENTS

SW COMMENTS

ENVIRON. COMMENTS

DRC COMMENTS

BY

JY

JY


JY

JY

DA

DA

DA

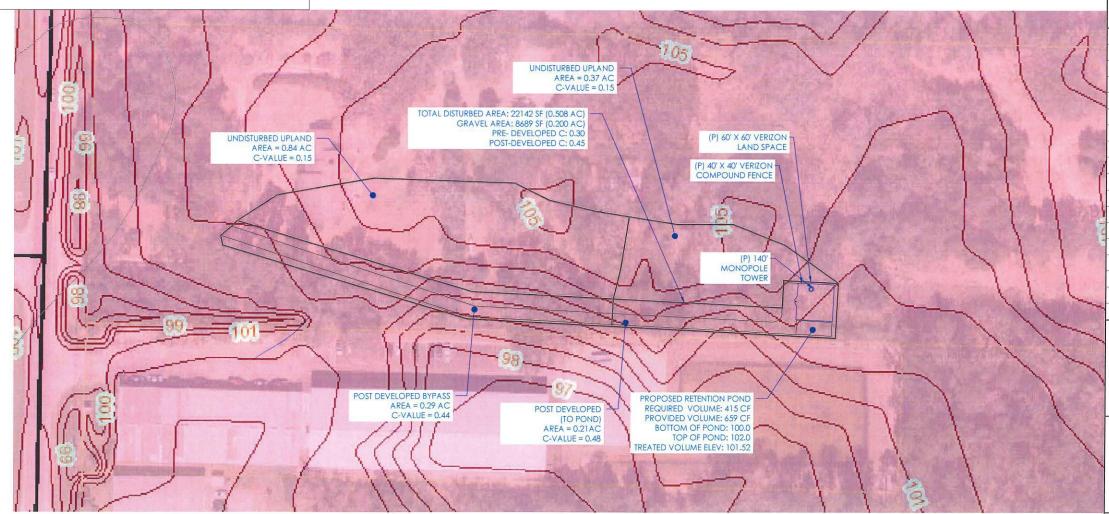

DISTURBED AREA/DRAINAGE PLAN

1" = 50'-0" (FULL SIZE 1" = 100'-0" (11x17) M MASS
No. 53573

STATEOR

PRINCE ALL MONAL PRINCE ALL MO

NO.

0 11/05/20

DATE

07/28/20

12/18/20

3 01/29/21

4 02/03/21

5 03/26/21 6 06/11/21

A 04/16/20

B 05/26/20

DESIGNED: JY

DRAWN: JY

CHECKED: DA

JOB#: 20_V3N_041

GRADING, SEDIMENT & EROSION CONTROL PLAN

C-6A

Client Name:	Verizon Wirel	ess - HGC Re	gion	
Site Number:	279068			
Site Name:	Dunaway			
Designer:	Dara Ay			
Date:	6/11/2021			
Proposed Conditions				
Description		Area (SF)	Area (AC)	С
Parent Tract Parcel Area		404272	9.2808	NA
Proposed Disturbed Area		22142	0.5083	NA
Proposed Impervious Area		0	0.0000	0.95
Proposed Graveled Area		8689	0.1995	0.60
Proposed Landscaped Area		13453	0.3088	0.35
Proposed Natural Area		0	0.0000	0.30
Proposed Relative Are	eas			
Description				%
Disturbed Area Relative to Pare Impervious Area Relative to Par		Area Only Con	sidered)	5.48 0.00
Proposed Routed Run	off Calculation	s (See Hy	drology St	udio Report)
Proposed Runoff Coefficient		***************************************		0.45
Description	С	I	A	Q
Q(2)	0.45 0.45	4.75	0.5083 0.5083	0.48
Q(5)		6.25		0.63
Q(10)	0.45	6.97	0.5083	0.70
Q(25)	0.45	8.00	0.5083	0.81
Q(50)	0.45	8.90	0.5083	0.90
Q(100)	0.45	9.72	0.5083	0.98
Existing Conditions				
Description		Area (SF)	Area (AC)	С
Parent Tract Parcel Area		404272	9.2808	NA
Existing Impervious Area		0	0.0000	0.95
Existing Graveled Area		0	0.0000	0.60
Existing Landscaped Area		0	0.0000	0.35
Existing Natural Area		22142	0.5083	0.30
Existing Relative Areas	5			
Description				%
Disturbed Area Relative to Pare Impervious Area Relative to Par		Area Only Con	isidered)	5,48 0,00
Existing Runoff Calcul	ations			C
Existing Runoff Coefficient				0.30
Description O(2)	C 0.20	1 4.7E	A	Q
Q(2)	0.30	4.75	0.5083	0.73
Q(5)	0.30	6.25	0.5083	0.96
Q(10)	0.30	6.97	0.5083	1.07
Q(25)	0.30	8.00	0.5083	1.22
Q(50)	0.30	8.90	0.5083	1.36
Q(100)	0.30	9.72	0.5083	1.49
Conclusions			PROP Storage,	
Description	EX. Flow, cfs	PROP Flow, cfs	cf (Swale/Pond)	Proposed Ponding El. (Swale/Pond)
1 Hour, 100 Year Storm	2.51	3.72	487 / 337	100.62 / 101.33
2 Hour, 100 Year Storm	2.51	3.72	487 / 337	100.62 / 101.33
4 Hour, 100 Year Storm	2.51	3.72	487 / 337	100.62 / 101.33
8 Hour, 100 Year Storm	2.51	3.72	487 / 337	100.62 / 101.33
24 Hour, 100 Year Storm	2.51			
e i modi, 100 rear Storiii	2,31	3.72	487 / 337	100.62 / 101.33

HYDROLOGY CALCULATIONS

Project Information

Recovery Time and Treatment Volume				Proj Name: Dunaway Proj No: 20V3N-041 Rev: 1 Date: 01.29/21
		Site Data		
Drainage Area	=	0.299	AC	
Impervious Area	-	0.129	AC	
Percent Impervious		43	%	
Offsite drainage area	=	0.84	AC	
f	=	0.30		
K _{vs}	-	11.90	ft/day	From NRCS Soil Survey
FS	=	2.00	-	
ld	=	5.95	ft/day	
		Proposed Retention	basin	0.0017653765300
Stage (ft)	Area (ft²)	Storage (ft³)		
100.0	221.0	0		
100.5	1110.0	332.75		
100.75	1558.0	666.25		
A CONTRACT C				110000000000000000000000000000000000000
The state of the s	For 0.5	5" of runoff (Off Line	Retention)	
				The wines of the individual of the property of the wines.
Runoff	221.00	0.50	in	
Total treatment volume	=	244.21	ft³	Based on Rational Method
				and Post Developed C = 0.45
Treatment Volume Elevation		100.37	ft	
Treatment volume depth, h _v	=	0.37	ft	
	THE PARTY OF THE P			**************************************
Height of water table to basin bottom	=	6.67	ft	
Height of water to saturate the soil, hu	=	2.0001	ft	
h _v <h<sub>u</h<sub>	→	NO Saturated Lat	eral Flow	
		\		
		Stage One (V _u) Infiltra	rtion	
Pond Bottom Area	=	221.00	ft ²	
Stage One Treatment Volume (V _u)	=	244.21	ft³	
Kvu	=	7.933	ft/day	
la .	=	3.967	ft/day	
t _{siz}	-	0.093	day	
		Recovery Time		
Stage One Recovery Time	=	0.093	ft	
Total Recovery Time	=	0.09	days	

PV&	Recov	ery Time and Trea	Proj Name: Dunaway Proj No: 20V3N-041 Rev: 1 Date: 01/29/21		
L.		Site Data		Date: 01/25/21	
Drainage Area		0.210	AC		
Impervious Area	=	0.107	AC		
Percent Impervious	=	51	%		
Offsite drainage area	=	0.37	AC		
1	=	0.30			
K _{vs}	(=)	11.90	ft/day	From NRCS Soil Survey	
FS FS	=	2.00			
I _d	=	5.95	ft/day	***************************************	
-					
		Proposed Retention	basin		
Stage (ft)	Area (ft²)	Storage (ft³)			
100.0	146.0	0			
100.5	219.0	91.25			
101.0	299.0	220.75			
101.5	434.0	404.00			
102.0	587.0	659.25			
	For 0.	5" of runoff (Off Line	Retention)		
Runoff		0.50	in		
Total treatment volume	=	171.52	ft³	Based on Rational Method	
SOF AND ALLOW A SHARE IS SETTING AND A CONTRACT OF THE STATE OF THE ST				and Post Developed C = 0.4	
Treatment Volume Elevation	=	100.81	ft		
Treatment volume depth, h,	=	0.81	ft		
Height of water table to basin bottom	=	6.67	ft		
Height of water to saturate the soil, h	=	2.0001	ft		
h, < h,	→	NO Saturated Lat			
		1 1			
AND ASSESSED TO SELECTION OF CONTRACT CONTRACT OF CONTRACT CONTRAC		Stage One (V _u) Infiltra	rtion		
Pond Bottom Area	=	146.00	ft²		
Stage One Treatment Volume (Vu)	=	171.52	ft³		
K _u		7.933	ft/day		
l _d		3.967	ft/day		
t _{sat}	=	0.204	day		
)				
		Recovery Time			
Stage One Recovery Time		0.204	ft		

RETENTION POND / RECOVERY TIME CALCULATIONS





DUNAWAY

7038 PINE FOREST ROAD PENSACOLA, FL 32526

LOCATION CODE: 279068

A 04/16/20 PRELIM LE J' B 05/26/20 PRELIM LE J' C 07/28/20 PRELIM LE J' 0 11/05/20 FINAL ZDs J' 1 12/18/20 JDX COMMENTS D 2 12/24/20 JDX COMMENTS D 3 01/29/21 JDX COMMENTS D 4 02/03/21 SW COMMENTS D 5 03/26/21 ENVIRON. COMMENTS D				
B 05/26/20 PRELIM LE J C 07/28/20 PRELIM LE J 0 11/05/20 FINAL ZDs J 1 12/18/20 JDX COMMENTS D 2 12/24/20 JDX COMMENTS D 3 01/29/21 JDX COMMENTS D 4 02/03/21 SW COMMENTS D 5 03/26/21 ENVIRON. COMMENTS D	NO.	DATE	REVISIONS	BY
C 07/28/20 PRELIM LE J' 0 11/05/20 FINAL ZDs J' 1 12/18/20 JDX COMMENTS D 2 12/24/20 JDX COMMENTS D 3 01/29/21 JDX COMMENTS D 4 02/03/21 SW COMMENTS D 5 03/26/21 ENVIRON. COMMENTS D	Α	04/16/20	PRELIM LE	JY
0 11/05/20 FINAL ZDs J 1 12/18/20 JDX COMMENTS D. 2 12/24/20 JDX COMMENTS D. 3 01/29/21 JDX COMMENTS D. 4 02/03/21 SW COMMENTS D. 5 03/26/21 ENVIRON. COMMENTS D.	В	05/26/20	PRELIM LE	JY
1 12/18/20 JDX COMMENTS D. 2 12/24/20 JDX COMMENTS D. 3 01/29/21 JDX COMMENTS D. 4 02/03/21 SW COMMENTS D. 5 03/26/21 ENVIRON. COMMENTS D.	С	07/28/20	PRELIM LE	JY
2 12/24/20 JDX COMMENTS D. 3 01/29/21 JDX COMMENTS D. 4 02/03/21 SW COMMENTS D. 5 03/26/21 ENVIRON. COMMENTS D.	0	11/05/20	FINAL ZDs	JY
3 01/29/21 JDX COMMENTS DA 4 02/03/21 SW COMMENTS DA 5 03/26/21 ENVIRON. COMMENTS DA	1	12/18/20	JDX COMMENTS	DA
4 02/03/21 SW COMMENTS DA 5 03/26/21 ENVIRON. COMMENTS DA	2	12/24/20	JDX COMMENTS	DA
5 03/26/21 ENVIRON. COMMENTS D	3	01/29/21	JDX COMMENTS	DA
a constraint and a cons	4	02/03/21	SW COMMENTS	DA
6 06/11/21 DRC COMMENTS D/	5	03/26/21	ENVIRON. COMMENTS	DA
	6	06/11/21	DRC COMMENTS	DA
				-



DESIGNED: JY
DRAWN: JY
CHECKED: DA

JOB#: 20_V3N_041

GRADING, SEDIMENT & EROSION CONTROL PLAN

C-6B

PIEDMONT VEGETATIVE COVERS

	CALENDAR MONTH	TEMPORARY SEED	APPLICATION RATE/ACRE	PERMANENT SEED	APPLICATIOI RATE/ACRE
1.	JANUARY	RYE GRASS	40-50 LB.	UNHULLED BERMUDA SERICEA LESPEDEZA	2 8-10 LE 30-40 LE
2.	FEBRUARY			UNHULLED BERMUDA SERICEA LESPEDEZA FESCUE	8-10 LE 30-40 LE 30-50 LE
3.	MARCH	RYE ANNUAL LESPEDEZA WEEPING LOVE GRASS	2-3 BU. 20-25 LB. 4-6 LB.	UNHULLED BERMUDA SERICEA LESPEDEZA FESCUE	8-10 LE 30-40 LE 30-50 LE
4.	APRIL	RYE BROWN TOP MILLET ANNUAL LESPEDEZA SUDAN ANNUAL	2-3 BU. 30-40 LB. 20-25 LB. 35 LB.	WEEPING LOVE GRASS HULLED BERMUDA BAHIA	4-6 LE 5-6 LE 40-60 LE
5.	MAY	WEEPING LOVE GRASS SUDAN GRASS BROWN TOP MILLET	4-6 LB. 35 LB. 30-40 LB.	WEEPING LOVE GRASS HULLED BERMUDA BAHIA	4-6 LE 5-6 LE 40-60 LE
6.	JUNE	WEEPING LOVE GRASS SUDAN GRASS BROWN TOP MILLET	4-6 LB. 35 LB. 30-40 LB.	WEEPING LOVE GRASS HULLED BERMUDA BAHIA	4-6 LE 5-6 LE 40-60 LE
7.	JULY	WEEPING LOVE GRASS SUDAN GRASS BROWN TOP MILLET	4-6 LB. 35 LB. 30-40 LB.		
8.	AUGUST	RYE GRASS WEEPING LOVE GRASS	40-50 LB. 4-6 LB.		
9.	SEPTEMBER			TALL FESCUE	30-50 LB
]0.	OCTOBER	WHEAT	2-3 BU.	UNHULLED BERMUDA SERICEA LESPEDEZA FESCUE	8-10 LB 30-40 LB 30-50 LB
11.	NOVEMBER	WHEAT	2-3 BU.	UNHULLED BERMUDA SERICEA LESPEDEZA FESCUE	8-10 LB 30-40 LB 30-50 LB
12.	DECEMBER	RYE RYE GRASS WHEAT	2-3 BU. 40-50 LB. 2-3 BU.	UNHULLED BERMUDA SERICEA LESPEDEZA FESCUE	8-10 LB 30-40 LB 30-50 LB

USE A MINIMUM OF 40 LBS. SCARIFIED SEED. THE REMAINDER MAY BE UNSCARIFIED, CLEAN HULLED SEED.

DISTURBED AREA STABILIZATION (WITH TEMPORARY SEEDING)

DISTURBED AREA STABILIZATION (WITH PERMANENT VEGETATION)

GENERAL

THIS VEGETATIVE PLAN WILL BE CARRIED OUT ON ROAD CUT AND FILL SLOPES, SHOULDERS, AND OTHER CRITICAL AREAS CREATED BY CONSTRUCTION, SEEDING WILL BE DONE AS SOON AS CONSTRUCTION IN AN AREA IS COMPLETED, PLANTINGS WILL BE MADE TO CONTROL EROSION, TO REDUCE DAMAGE FROM SEDIMENT AND RUNOFF TO DOWNSTREAM AREAS AND TO IMPROVE THE SAFETY AND BEAUTY OF THE DEVELOPMENT AREA.

SOIL CONDITIONS

DUE TO GRADING AND CONSTRUCTION, THE AREAS TO BE TREATED ARE MAINLY SUBSOIL AND SUBSTRATES. FERTILITY IS LOW AND THE PHYSICAL CHARACTERISTICS OF THE EXPOSED MATERIAL ARE UNFAVORABLE TO ALL BUT THE MOST HARDY PLANTS.

TREATMENT SPECIFICATIONS

HYDRAULIC SEEDING EQUIPMENT: WHEN HYDRAULIC SEEDING AND FERTILIZING EQUIPMENT IS USED, NO GRADING AND SHAPING OR SEEDBED PREPARATION WILL BE REQUIRED. THE FERTILIZER, SEED AND WOOD CELLULOSE FIBER MULCH WILL BE MIXED WITH WATER AND APPLIED IN A SLURRY. ALL SLURRY INGREDIENTS MUST BE COMBINED TO FORM A HOMOGENOUS MIXTURE, AND SPREAD UNIFORMLY OVER THE AREA WITHIN ONE HOUR AFTER MIXTURE IS MADE. STRAW OR HAY MULCH AND ASPHALT EMULSION WILL BE APPLIED WITH BLOWER-TYPE MULCH SPREADING EQUIPMENT WITHIN 24 HOURS AFTER SEEDING. THE MULCH WILL BE SPREAD UNIFORMLY OVER THE AREA, LEAVING ABOUT 25 PERCENT OF THE GROUND SURFACE EXPOSED. THE PER ACRE APPLICATION RATES ARE AS FOLLOWS:

A. SEEDING WITH MULCH: (HYDRAULIC SEEDING EQUIPMENT ON SLOPES 3:1 AND STEEPER)

AGRICULTURAL LIMESTONE #75	4000 LBS./ACF
FERTILIZER, 5-10-15	1500 LBS./ACF
MULCH (STRAW OR HAY) OR	5000 LBS./ACF
WOOD CELLULOSE FIBER MULCH	1000 LBS./ACF

60 LBS. 4 LBS. 6 LBS. 3/1 - 6/ 6 LBS. 9/1 - 10/
6 LBS. 9/1 10/
6 LBS. 9/1 10/
60 LBS.
40 LBS.
75 LBS. 11/1 - 2/
50 LBS.
5000 LBS. 6/15 - 8/

B. TOP DRESSING: APPLY WHEN PLANTS ARE 2 TO 4 INCHES TALL

FERTILIZER (AMMONIUM NITRATE 33.5%) 300 LBS./ACRE

C. SECOND-YEAR TREATMENT:

FERTILIZER (0-20-20 OR EQUIVALENT) 500 LBS./ACRE

GENERAL

THIS VEGETATIVE PLAN WILL BE CARRIED OUT ON ROAD CUT AND FILL SLOPES, SHOULDERS, AND OTHER CRITICAL AREAS CREATED BY CONSTRUCTION. SEEDING WILL BE DONE AS SOON AS CONSTRUCTION IN AN AREA IS COMPLETED. PLANTINGS WILL BE MADE TO CONTROL EROSION, TO REDUCE DAMAGE FROM SEDIMENT AND RUNOFF TO DOWNSTREAM AREAS AND TO IMPROVE THE SAFETY AND BEAUTY OF THE DEVELOPMENT AREA.

SOIL CONDITIONS

DUE TO GRADING AND CONSTRUCTION, THE AREAS TO BE TREATED ARE MAINLY SUBSOIL AND SUBSTRATES. FERTILITY IS LOW AND THE PHYSICAL CHARACTERISTICS OF THE EXPOSED MATERIAL ARE UNFAVORABLE TO ALL BUT THE MOST HARDY PLANTS.

TREATMENT SPECIFICATIONS

CONVENTIONAL SEEDING EQUIPMENT: GRADE, SHAPE, AND SMOOTH WHERE NEEDED TO PROVIDE FOR SAFE EQUIPMENT OPERATION AT SEEDING TIME AND FOR MAINTENANCE PURPOSES. THE LIME AND FERTILIZER IN DRY FORM WILL BE SPREAD UNIFORMLY OVER THE AREA IMMEDIATELY BEFORE SEEDBED PREPARATION. A SEEDBED WILL BE PREPARED BY SCARIFYING TO A DEPTH OF 1 TO 4 INCHES AS DETERMINED ON SITE. THE SEEDBED MUST BE WELL PULVERIZED, SMOOTHED, AND FIRMED. SEEDING WILL BE DONE WITH A CULTIPACKER-SEEDER, DRILL, ROTARY SEEDER, OR OTHER MECHANICAL OR HAND SEEDER. SEED WILL BE DISTRIBUTED UNIFORMLY OVER A FRESHLY PREPARED SEEDBED AND COVERED LIGHTLY. WITHIN 24 HOURS AFTER SEEDING, STRAW OR HAY MULCH WILL BE SPREAD UNIFORMLY OVER THE AREA, LEAVING ABOUT 25 PERCENT OF THE GROUND SURFACE EXPOSED. MULCH WILL BE SPREAD WITH BLOWER-TYPE MULCH EQUIPMENT OR BY HAND AND ANCHORED IMMEDIATELY AFTER IT IS SPREAD. A DISK HARROW WITH THE DISK SET STRAIGHT OR A SPECIAL PACKER DISK MAY BE USED TO PRESS THE MULCH INTO THE SOIL. THE PER ACRE APPLICATION RATES ARE AS FOLLOWS:

A. SEEDING WITH MULCH: (CONVENTIONAL SEEDING EQUIPMENT ON SLOPES LESS THAN 3:1)

AGRICULTURAL LIMESTONE #75 FERTILIZER, 5-10-15 MULCH (STRAW OR HAY) 4000 LBS./ACRE 1500 LBS./ACRE 5000 LBS./ACRE

A DDI ICATION	
RATE/ACRE	PLANTING DATES
10 LBS.	3/1 - 6/15
50 LBS.	9/1 - 10/31
50 LBS. 50 LBS.	11/1 - 2/28
5000 LBS.	6/15 - 8/31
	10 LBS. 50 LBS. 50 LBS. 50 LBS.

B. TOP DRESSING: APPLY WHEN PLANTS ARE 2 TO 4 INCHES TALL

FERTILIZER (AMMONIUM NITRATE 33.5%)

300 LBS./ACRE

C. SECOND-YEAR TREATMENT:

FERTILIZER (5-10-15 OR EQUIVALENT)

800 LBS./ACRE

DISTURBED AREA STABILIZATION (WITH TEMPORARY SEEDING)

DISTURBED AREA STABILIZATION (WITH PERMANENT VEGETATION)





DUNAWAY

7038 PINE FOREST ROAD PENSACOLA, FL 32526

279068

NO.	DATE	REVISIONS	BY
Α	04/16/20	PRELIM LE	JY
В	05/26/20	PRELIM LE	JY
С	07/28/20	PRELIM LE	JY
0	11/05/20	FINAL ZDs	JY
1	12/18/20	JDX COMMENTS	DA
2	12/24/20	JDX COMMENTS	DA
3	01/29/21	JDX COMMENTS	DA
4	02/03/21	SW COMMENTS	DA
5	03/26/21	ENVIRON. COMMENTS	DA
6	06/11/21	DRC COMMENTS	DA
7	06/24/21	DRC COMMENTS	DA




DESIGNED: JY
DRAWN: JY
CHECKED: DA

JOB#: 20 V3N 041

GRADING, SEDIMENT & EROSION CONTROL NOTES

² USE EITHER COMMON SERALA OR INTERSTATE SERICEA LESPEDEZA.

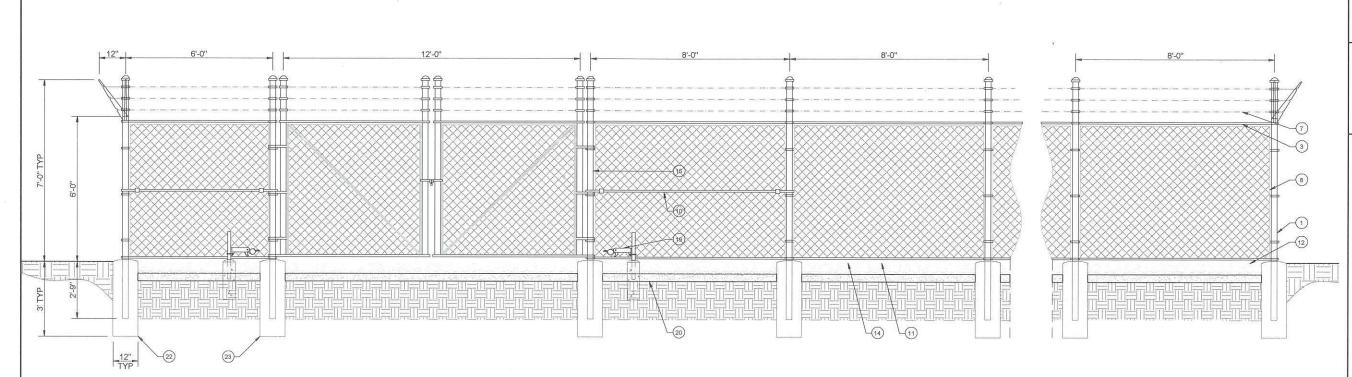

REFERENCE NOTES:

- CORNER, END OR PULL POST 3" NOMINAL SCHEDULE 40 PIPE.
- ② LINE POST: 2 1/2" SCHEDULE 40 PIPE, PER ASTM-F1083. LINE POSTS SHALL BE EQUALLY SPACED AT MAXIMUM 8"-0" O.C.
- ③ TOP RAIL & BRACE RAIL: 1 1/2" PIPE, PER ASTM-F1083.
- FABRIC: 9 GA CORE WIRE SIZE 2" MESH, CONFORMING TO ASTM-A392.
- TIE WIRE: MINIMUM 11 GA GALVANIZED STEEL AT POSTS AND RAILS

 (S) A SINGLE WRAP OF FABRIC TIE AND AT TENSION WIRE BY HOG RINGS SPACED MAX. 24" INTERVALS.
- 6 TENSION WIRE: 9 GA. GALVANIZED STEEL.
- Ø BARBED WIRE: DOUBLE STRAND 12-1/2" O.D. TWISTED WIRE TO MATCH WITH FABRIC 14 GA, 4 PT. BARBS SPACED ON APPROXIMATELY 5" CENTERS.
- STRETCHER BAR.
- 3/8" DIAGONAL ROD WITH GALVANIZED STEEL TURNBUCKLE OR DIAGONAL THREADED ROD.
- (i) FENCE CORNER POST BRACE: 1 5/8" DIA. EACH CORNER EACH WAY.
- 1 1/2" MAXIMUM CLEARANCE FROM GRADE.

- 2" FINISH OR AS DETERMINED BY CONSTRUCTION MANAGER DURING BID WALK.
- (3) 4" COMPACTED 95% BASE MATERIAL OR AS DETERMINED BY CONSTRUCTION MANAGER DURING BID WALK.
- (4) FINISH GRADE SHALL BE UNIFORM AND LEVEL.
- GATE POST 4". SCHEDULE 40 PIPE, FOR GATE
 WIDTHS UP THRU 7 FEET OR 14 FEET FOR
 DOUBLE SWING GATE, PER ASTM-F1083.
- (a) GATE FRAME: 1 1/2" PIPE, PER ASTM-F1083.
- (7) GATE FRAME; 1 5/8" DIAMETER PIPE, PER ASTM-F1083
- (B) GATE DIAGONAL GALVANIZED STEEL 1 1/2" PIPE.
- DUCK BILL OPEN GATE HOLDER. VERIFY LOCATION IN FIELD PRIOR TO INSTALLATION.
- @ GEOTEXPILE FABRIC
- ② LINE POST: CONCRETE FOUNDATION (2000 PSI)
- CORNER POST: CONCRETE FOUNDATION (2000 PSI)
- GATE POST: CONCRETE FOUNDATION (2000 PSI)

GENERAL NOTES:

- 1. INSTALL FENCING PER ASTM F-567
- 2. INSTALL SWING GATES PER ASTM F-900
- LOCAL ORDINANCE OF BARBED WIRE PERMIT REQUIREMENT SHALL BE COMPLIED IF REQUIRED.
- 4. POST & GATE PIPE SIZES ARE INDUSTRY STANDARDS.
 ALL PIPE TO BE 1 1/2" GALV.
 [HOT DIP, ASTM A 120 GRADE "A" STEEL).
 ALL GATE FRAMES SHALL BE WELDED.
 ALL WELDING SHALL BE COATED WITH (3) COATS
 OF COLD GALV. (OR EQUAL).
- 5. ALL OPEN POSTS SHALL HAVE END-CAPS.
- 6. USE GALVANIZED HOG-RING WIRE TO MOUNT ALL SIGNS.
- 7. ALL SIGNS MUST BE MOUNTED ON INSIDE OF FENCE FABRIC.





DUNAWAY

7038 PINE FOREST ROAD PENSACOLA, FL 32526

LOCATION CODE: 279068


NO.	DATE	REVISIONS	BY
Α	04/16/20	PRELIM LE	JY
В	05/26/20	PRELIM LE	JY
C	07/28/20	PRELIM LE	JY
0	11/05/20	FINAL ZDs	JY
1	12/18/20	JDX COMMENTS	DA
2	12/24/20	JDX COMMENTS	DA
3	01/29/21	JDX COMMENTS	DA
4	02/03/21	SW COMMENTS	DA
5	03/26/21	ENVIRON. COMMENTS	DA
6	06/11/21	DRC COMMENTS	DA
7	06/24/21	DRC COMMENTS	DA




DESIGNED: JY DRAWN: JY CHECKED: DA

> JOB #; 20_V3N_041


FENCE DETAILS

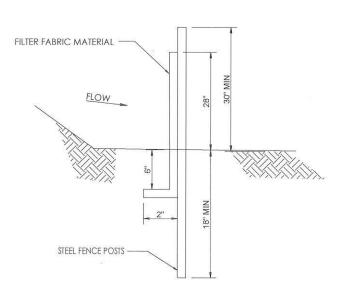

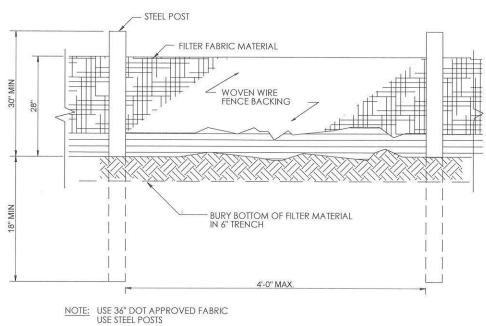


SILT FENCE, TYPE-C


L = THE DISTANCE SUCH THAT POINTS A AND B ARE OF EQUAL ELEVATION.

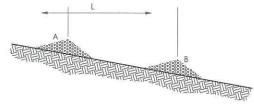

SPACING BETWEEN CHECK DAMS

STONE CHECK DAM

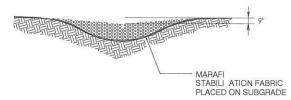

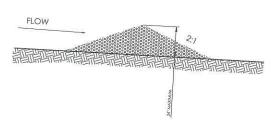


NOTES

CHECK DAMS TO BE CONSTRUCTED OF GRADED SIZE 2 - 10 INCH STONE. MECHANICAL OR HAND PLACEMENT SHALL BE REQUIRED TO INSURE COMPLETE COVERAGE OF ENTIRE WIDTH OF DITCH OR SWALE AND THAT CENTER OF DAM IS LOWER THAN EDGES.

SEDIMENT TO BE REMOVED WHEN A LEVEL OF 1/2 THE ORIGINAL DAM HEIGHT OR LESS IS REACHED. REMOVE CHECK DAMS AT COMPLETION OF PROJECT AND TREAT RESULTING DISTURBED AREAS AS REQUIRED.

CHECK DAM

NOT TO SCALE

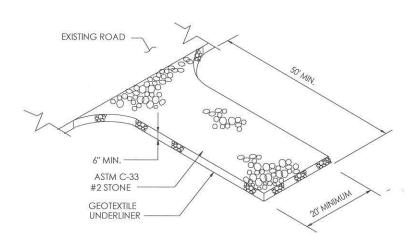

CONSTRUCTION EXIT





DUNAWAY

7038 PINE FOREST ROAD PENSACOLA, FL 32526

LOCATION CODE: 279068


NO.	DATE	REVISIONS	BY
Α	04/16/20	PRELIM LE	JY
В	05/26/20	PRELIM LE	JY
С	07/28/20	PRELIM LE	JY
0	11/05/20	FINAL ZDs	JY
1	12/18/20	JDX COMMENTS	DA
2	12/24/20	JDX COMMENTS	DA
3	01/29/21	JDX COMMENTS	DA
4	02/03/21	SW COMMENTS	DA
5	03/26/21	ENVIRON. COMMENTS	DA
6	06/11/21	DRC COMMENTS	DA
7	06/24/21	DRC COMMENTS	DA



DESIGNED: JY
DRAWN: JY
CHECKED: DA

JOB #: 20_V3N_041

GRADING, SEDIMENT & EROSION CONTROL DETAILS

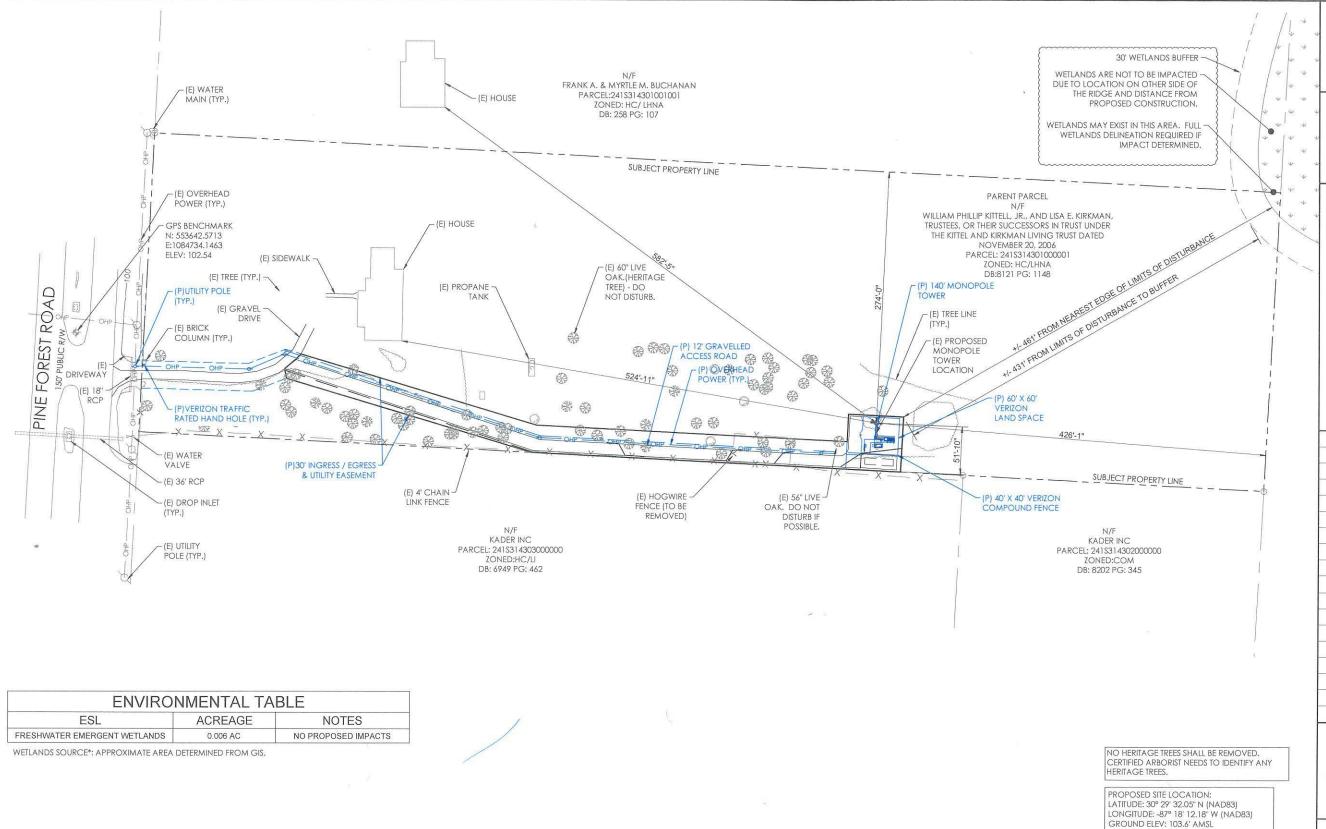

ENVIRONMENTAL SITE PLAN

1" = 50'-0" (FULL SIZE) 1" = 100'-0" (11x17)





DUNAWAY

7038 PINE FOREST ROAD PENSACOLA, FL 32526

279068

DATE	REVISIONS	BY
04/16/20	PRELIM LE	JY
05/26/20	PRELIM LE	JY
07/28/20	PRELIM LE	JY
11/05/20	FINAL ZDs	JY
12/18/20	JDX COMMENTS	DA
12/24/20	JDX COMMENTS	DA
01/29/21	JDX COMMENTS	DA
02/03/21	SW COMMENTS	DA
03/26/21	ENVIRON. COMMENTS	DA
06/11/21	DRC COMMENTS	DA
	04/16/20 05/26/20 07/28/20 11/05/20 12/18/20 12/24/20 01/29/21 02/03/21	04/16/20 PRELIM LE 05/26/20 PRELIM LE 07/28/20 PRELIM LE 11/05/20 FINAL ZDs 12/18/20 JDX COMMENTS 12/24/20 JDX COMMENTS 01/29/21 JDX COMMENTS 02/03/21 SW COMMENTS 03/26/21 ENVIRON. COMMENTS



FLOOD PLAIN NOTE:

THE SITE IS LOCATED WITHIN UNSHADED ZONE X AREA OF MINIMAL FLOOD HAZARD PER FEMA MAP 12033C0360G DATED 09/29/2006

THE GC SHALL CONTACT THE SURVEYOR PRIOR TO CONSTRUCTION STRAT TO COORDINATE


STAKING AND PINNING THE CORNERS, DRIVEWAY AND CENTER OF TOWER.

DESIGNED: JY
DRAWN: JY
CHECKED: DA

JOB #: 20_V3N_041

ENVIRONMENTAL SITE PLAN

EV-1

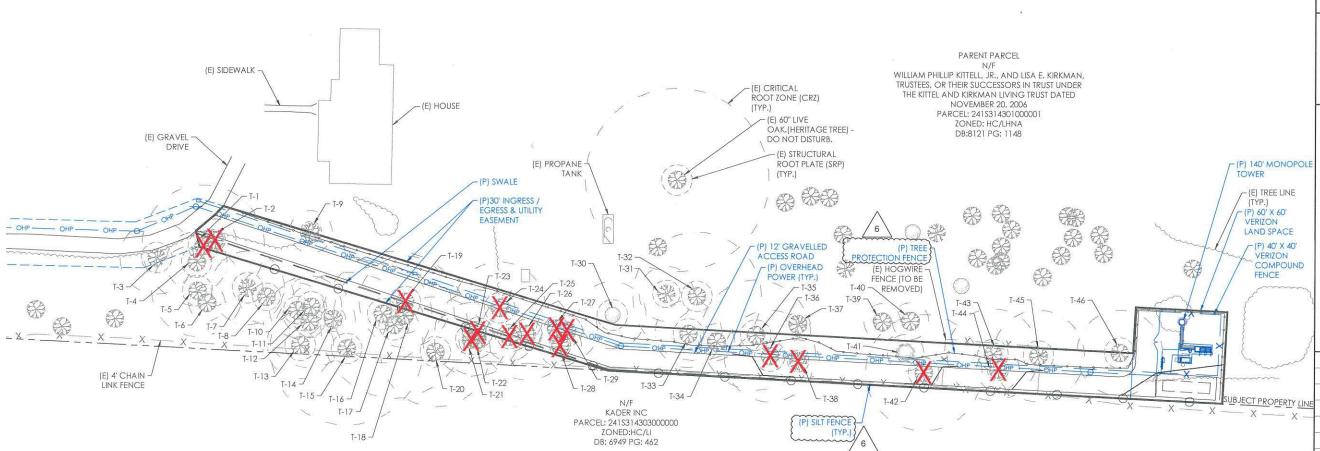

				T-18 J			ZONEI DB: 6949
-							
	TREE	INVE	NTORY		TREE	INVE	NTORY
LABEL	SPECIES	DBH	REMOVE / PRESERVE	LABEL	SPECIES	DBH	REMOVE / PRESERVE
T-1	OAK	40"	REMOVE	T-21	OAK	24"	REMOVE
T-2	OAK	14"	REMOVE	T-22	OAK	12"	PRESERVE
T-3	OAK	24"	PRESERVE	T-23	OAK	28"	REMOVE
T-4	OAK	20"	PRESERVE	T-24	OAK	30"	REMOVE
T-5	OAK	30"	PRESERVE	T-25	OAK	16"	REMOVE
T-6	OAK	12"	PRESERVE	T-26	OAK	30"	REMOVE
T-7	OAK	24"	PRESERVE	T-27	OAK	18"	REMOVE
T-8	OAK	18"	PRESERVE	T-28	OAK	16"	REMOVE
T-9	CYPRESS	18"	PRESERVE	T-29	OAK	20"	REMOVE
T-10	OAK	18"	PRESERVE	T-30	OAK	22"	DEAD
T-11	OAK	20"	PRESERVE	T-31	OAK	18"	PRESERVE
T-12	OAK	30"	PRESERVE	T-32	OAK	42"	PRESERVE
T-13	OAK	22"	PRESERVE	T-33	OAK	22"	PRESERVE
T-14	OAK	8"	PRESERVE	T-34	OAK	12"	PRESERVE
T-15	OAK	50"	PRESERVE	T-35	OAK	36"	PRESERVE
T-16	OAK	32"	PRESERVE	T-36	OAK	30"	REMOVE
T-17	OAK	48"	PRESERVE	T-37	OAK	8"	PRESERVE

OAK

OAK

OAK

14"

12"

12"

T-38

T-39

T-40

LABEL	SPECIES	DBH	REMOVE / PRESERVE
T-41	OAK	12"	DEAD
T-42	OAK	38"	REMOVE
T-43	OAK	30"	PRESERVE
T-44	OAK	14"	REMOVE
T-45	OAK	30"	PRESERVE
T-46	OAK	56"	PRESERVE

TOTAL DBH REMOVED: 352'

TOTAL DISTURBED ACREAGE: 0.508 AC

REQUIRED REPLACEMENT DBH: 352" X 0.5 = 176" HOWEVER, MAXIMUM

REPLACEMENT LIMIT:

25" DBH/AC = 25" * 0.508 AC = 12.7" DBH

IN LIEU OF PLANTING REPLACEMENT TREES, ALTERNATIVE PAYMENT TO THE TREE RESTORATION FUND IS PROPOSED AFTER SITE PLAN APPROVAL.

NOTE: THE DEVELOPMENT ORDER WILL INDICATE THAT ANY UNAUTHORIZED TREE REMOVAL, INCLUDING IRREPARABLE INJURY CAUSING UNNATURAL DECLINE (E.G. CANOPY REMOVAL 25%, STRUCTURE ROOT PLATE DAMAGE), WILL REQUIRE STANDARD MITIGATION BY FEE PAYMENT NOT LIMITED BY THE MITIGATION CAMP.

DISTURBING ACTIVITIES", INCLUDING THE PLACEMENT OF FILL/ FILL MATERIALS, GRADING, EXCAVATING, ETC. SHALL NOT OCCUR UNTIL SUCH TIME AS APPROPRIATE PERMIT(S) ARE ISSUED FOR SUCH SITE WORK.

NOTE: ALL TREES SHALL LABELED AS "PRESERVE" SHALL REMAIN ONSITE AND ANY PROPOSED LAND CLEARING/ "LAND

verizon

DUNAWAY

7038 PINE FOREST ROAD PENSACOLA, FL 32526

> LOCATION CODE: 279068

NO.	DATE	REVISIONS	BY
Α	04/16/20	PRELIM LE	JY
В	05/26/20	PRELIM LE	JY
С	07/28/20	PRELIM LE	JY
0	11/05/20	FINAL ZDs	JY
1	12/18/20	JDX COMMENTS	DA
2	12/24/20	JDX COMMENTS	DA
3	01/29/21	JDX COMMENTS	DA
4	02/03/21	SW COMMENTS	DA
5	03/26/21	ENVIRON. COMMENTS	DA
6	06/11/21	DRC COMMENTS	DA
7	06/24/21	DRC COMMENTS	DA



NO VEHICLES, CONSTRUCTION EQUIPMENT, OR

MATERIAL STOCKPILES MAY ENCROACH BEYOND THE FENCE/BARRIER.

NO HERITAGE TREES SHALL BE REMOVED.

ONGITUDE: -87° 18' 12.18" W (NAD83) GROUND ELEV: 103.6' AMSL

HE SITE IS LOCATED WITHIN UNSHADED ZONE X

AREA OF MINIMAL FLOOD HAZARD PER FEMA MAP 12033C0360G DATED 09/29/2006

THE GC SHALL CONTACT THE SURVEYOR PRIOR O CONSTRUCTION STRAT TO COORDINATE

STAKING AND PINNING THE CORNERS, DRIVEWAY AND CENTER OF TOWER.

PROPOSED SITE LOCATION: LATITUDE: 30° 29' 32.05' N (NAD83)

LOOD PLAIN NOTE:

CERTIFIED ARBORIST NEEDS TO IDENTIFY ANY HERITAGE TREES.

DESIGNED: JY DRAWN: JY CHECKED: DA

> JOB #: 20_V3N_041

TREE PLAN

EV-2

TREE PLAN 1" = 50'-0" (FULL SIZE) 1" = 100'-0" (11x17)

REMOVE

PRESERVE

PRESERVE

NOTE: TREES LABELED FOR WITHIN PROPOSED FOOTPRINT PER TREE SURVEY BY 360 SURVEYING SERVICES DATED 05/21/2020. REFER TO SURVEY FOR FULL TREE LIST. ALL TREES TO BE PRESERVED IF POSSIBLE BY MEANDERING ACCESS DRIVE AND LIMIT GRADING.

PRESERVE

REMOVE

PRESERVE

T-18

T-19

T-20

OAK

OAK

OAK

12"

20"

36"