LOCATION MAP

VICINITY MAP

Approved **ESCAMBIA COUNTY DRC PLAN REVIEW**

DRC Chairman Signatur Printed Name: Sennifer Development Services Director or Designee

This document has been reviewed in accordance with the requirements of applicable Escambia County Regulations and Ordinances, and does not in any way relieve the submitting Architect, Engineer, Surveyor or other signatory from responsibility of details as drawn. A Development Order (DO) must be obtained through the Development Review Process prior to the commencement of construction. This DO approval does not constitute approval by any other agency. All additional state/federal permits shall be provided to the county prior to approval of a final plat or the issuance of state/federal permits shall be provided to the county prior to approval of a final plat or the issuance of a building permit.

SITE NAME:

RIVERVIEW

LOCATION CODE:

508429

TOWER TYPE:

PROPOSED 180 FT **CONCEALED MONOPOLE TOWER**

(TOWER HEIGHT - 181' AGL; OVERALL APPURTENANCE HEIGHT - 191' AGL)

PREPARED FOR:



PREPARED BY:

6801 PORTWEST DRIVE #100 HOUSTON, TX 77024 713-677-0964

ZONING DRAWINGS



POWER & TELCO COORDINATION: POWER COMPANY: MAIN CONTACT NUMBER: **GULF POWER** 1-800-225-5797 PWR CO ENGINEER ENGINEER CONTACT INFO: TBD ESID NUMBER: METER ADDRESS: TBD

TBD

TRD

TEL. CONTACT NUMBER: FIBER PROVIDER NOTE - TBD:

TELEPHONE COMPANY

DRIVING DIRECTIONS:

TAKE 1-10 EAST FOR APPROXIMATELY 190MI. EXIT FL-291 N, TRAVEL 3.5 MI. TO SMITHS FISH CAMP RD. THIS IS JUST BEFORE THE BRDIGE, ON THE R-HAND SIDE OF THE RD. FOLLOW THE RD FOR LESS THAN 1 MI. UNTIL IT DEAD ENDS, YOU'VE ARRIVED

CONDITIONAL USE PERMIT:

CONDITIONAL USE APPROVED MARCH 18, 2021 BY THE ESCAMBIA COUNTY BOARD OF ADJUSTMENT TO ALLOW FOR A COMMERCIAL TELECOMMUNICATIONS TOWER GREATER THAN 150 FEET IN HEIGHT

CONTRACTORS: DO NOT PERFORM SITE WORK UNTIL PERMITS HAVE BEEN OBTAINED.

THE PROPOSED EQUIPMENT WILL NOT BE USED FOR EMERGENCY RESPONSE EQUIPMENT.

PROJECT INFORMATION

RIVERVIEW

3451 SMITHS FISH CAME

PENSACOLA, FL 32514

SITE NAME:

LATITUDE: LONGITUDE: 30° 32' 46.08" N (NAD 83) -87° 11' 39.38" W (NAD 83)

ELEVATION: 5.3' AMSI

HIRISDICTION: ESCAMBIA COUNTY

CLASSIFICATION: COUNTY:

COMMERCIAL **ESCAMBIA**

LAND USE CAT:

EXISTING: HIGH DENSITY MIXED-USE (HDMU)

LAND OWNER:

SMITHS FISH CAMP LLC 4005 MIDDLEBURY DR

PENSACOLA, FL 32514 850-554-7501

DEVELOPER:

VERIZON WIRELESS 14123 CICERO ROAD HOUSTON, TX 77095

CM: JEFF MCNARY; 850-572-7020

ENGINEER:

P. MARSHALL & ASSOCIATES 6801 PORTWEST DR. SUITE 100 HOUSTON, TX 77024 PATRICK W. MARSHALL, P.E.

678-280-2325

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OVERALL DRAINAGE PLAN

EQUIPMENT LAYOUT & CONDUIT STUB-UP PLAN

CALL FLORIDA ONE CALL (800) 432-4770 CALL 3 WORKING DAYS BEFORE YOU DIG!

verizon



RIVERVIEW

3451 SMITHS FISH CAMP PENSACOLA, FL 32514

LOCATION CODE:

REVISIONS

508429

NO. DATE

	W/\1L	11211010110	, 5.
0	10/30/20	ZONING DRAWINGS	DA
1	02/09/21	WETLAND DELINEATION	DA
2	05/12/21	DRC COMMENTS	DA
3	05/21/21	DRC COMMENTS	DA

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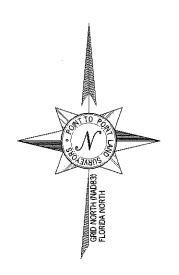


ESIGNED: AA DRAMM IY CHECKED: PWM

20 V3N-028

TITLE SHEET & **PROJECT INFORMATION** 

ZT-1



LEGEND

BFE BFO C/L CMF EG ELEC. EM EP ESMT FH GW ING-EGR IPS

BASE FLOOD ELEVATION BURIED FIBER OPTIC CENTERLINE

CONCRETE MONUMENT FOUND

CONCRETE MONUMEN
EDGE OF GRAVEL
ELECTRIC
ELECTRIC METER
EDGE OF PAVEMENT
EASEMENT
FIRE HYDRANT
GUY WIRE
I NIGRESS-EGRESS
INON PIN FOUND
IRON PIN SET

NOW OR FORMERLY
PANIEL
POINT OF BEGINNING
POINT OF COMMENCEMENT
RIGHT-OF-WAY
REBAR
TEMPORARY BENCHMARK
TRANSFORMER
UNDERGROUND GAS
UTILITY POL
WATER METER
WATER METER
WATER VALVE

### PARENT PARCEL

OWNER: SMITHS FISH CAMP, LLC.

SITE ADDRESS: 3509 SMITHS FISH CAMP ROAD, PENSACOLA, FL 32514

ACCOUNT NO. 010002500

AREA: 44,8922 (PER TAX ASSESSOR)

ZONED: HOMU / MDR (HIGH DENSITY MIXED USE DISTRICT / REDISENTIAL MEDIUM DENSITY)

ALL ZONING INFORMATION SHOULD BE VERIFIED WITH THE PROPER ZONING OFFICIALS

REFERENCE: OR BOOK 6162, PAGE 937

### SURVEYORS CERTIFICATE

I HEREBY CERTIFY THAT THIS MAP IS CORRECT AND WAS DRAWN UNDER MY DIRECT SUPERVISION. ANY VISIBLE ENCROACHMENTS ARE SHOWN HEREON.

DATE: 05/18/2020 G. DARRELL TAYLOR, FLORIDA PROFESSIONAL SURVEYOR & MAPPER

THIS MAP IS NOT A CERTIFIED SURVEY AND HAS NOT BEEN REVIEWED BY A LOCAL GOVERNMENT AGENCY FOR COMPLIANCE WITH ANY APPLICABLE LAND DEVELOPMENT REGULATIONS. THIS MAP IS ONLY INTENDED FOR THE PARTIES AND PURPOSES SHOWN. THIS MAP IS NOT FOR RECORDATION.


### ADJOINER INFORMATION

#	N/F	ACCOUNT NO.	REFERENCE	ZONED:
1.	LANWAY H. & SANDRA MAGILL LING	010004598	ORB. 4767, PG. 1364	MDR
2.	STEPHANIE R. & ROBERT K. GODFREY	010004566	ORB. 8100, PG. 274	MDR
3.	LANWAY & SANDRA B. LING	010004568	ORB. 5461, PG. 1645	MDR
4.	LANWAY & SANDRA B. LING	010004570	ORB. 5461, PG. 1642	MDR
5.	GEORGE L. & KAREN M, CRISCO	010004578	ORB. 4288, PG. 1026	MDR
6.	FRANCIS PHUC & LYNN LAM VO	010004580	ORB. 7355, PG. 940	MDR
7.	GREGORY L. & JANET L., GOODYEAR	010004582	ORB. 5336, PG. 74	MDR
8.	Donna Gail. Smith	010003000	ORB. 6081, PG. 232	HDR
9.	DAPHNE M. REBOULET	010003100	ORB. 6162, PG. 934	HDR

### **GPS NOTES**


THE FOLLOWING GPS STATISTICS UPON WHICH THIS SURVEY IS BASED HAVE BEEN PRODUCED AT THE 95%

POSITIONAL ACCURACY: 0.04 FEET (HORZ) 0.09 FEET (VERT)
TYPE OF EQUIPMENT: GEOMAX ZENITH35 PRO BASE AND ROVER, DUAL FREQUENCY
TYPE OF GPS FIELD PROCEDURE: ONLINE POSITION USER INTERFACE
DATES OF SURVEY: 02/05/2020
DATUM / EPOCH: NAD_83(2011)KEPOCH:2010.0000) PUBLISHED / FIXED CONTROL USE GEOID MODEL: 18 COMBINED GRID FACTOR(S): 0.99997441 CENTERED ON THE GPS BASE POINT AS SHOWN HEREON CONVERGENCE ANGLE: -01°21'14.87"

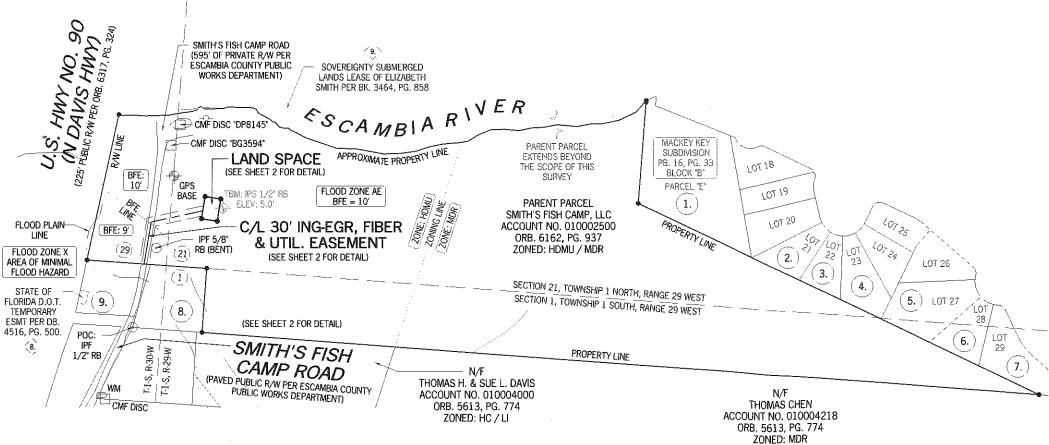

GRAPHIC SCALE IN FEET

SCALE: 1" = 300"

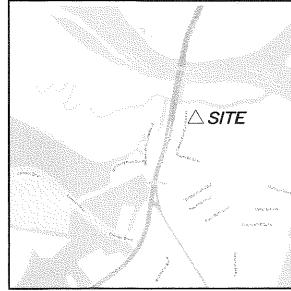

## VICINITY MAP

## GENERAL NOTES

THIS SPECIFIC PURPOSE SURVEY IS FOR THE LAND SPACE AND EASEMENTS ONLY. THIS SPECIFIC PURPOSE SURVEY WAS PREPARED FOR THE EXCLUSIVE USE OF VERIZON WIRELESS & U.S. TITLE SOLUTIONS AND EXCLUSIVELY FOR THE TRANSFERRAL OF THE LAND SPACE AND THE RIGHTS OF EASEMENT SHOWN HEREON AND SHALL NOT BE USED AS AN EXHIBIT OR EVIDENCE IN THE FEE SIMPLE TRANSFERRAL OF THE PARENT PARCEL NOR ANY PORTION OR PORTIONS THEREOF, BOUNDARY INFORMATION SHOWN HEREON HAS BEEN COMPILED FROM TAX MAPS AND DEED DESCRIPTIONS ONLY, NO BOUNDARY SURVEY OF THE PARENT PARCE

THIS DRAWING DOES NOT REPRESENT A BOUNDARY SURVEY.

EQUIPMENT USED FOR ANGULAR & LINEAR MEASUREMENTS: LEICA TPS 1200 ROBOTIC & GEOMAX ZENITH 35 [DATE OF LAST FIELD VISIT: 02/05/2020]

THE 1' CONTOURS AND SPOT ELEVATIONS SHOWN ON THIS SPECIFIC PURPOSE SURVEY ARE ADJUSTED TO NAVD 88 DATUM (COMPUTED USING GEOID18) AND HAVE A VERTICAL ACCURACY OF  $\pm$  0.5'. CONTOURS OUTSIDE THE IMMEDIATE SITE AREA ARE APPROXIMATE.

BEARINGS SHOWN ON THIS SPECIFIC PURPOSE SURVEY ARE BASED ON GRID NORTH (NAD 83)

BENCHMARKS USED: OPUS SOLUTION PER THE FOLLOWING CORS STATIONS:

DM2660 AL92 ALDOT 9 DIV DIS 2 CORS, DL7331 ALFO FOLEY CORS, DG4683 PCLA

PER THE FEMA FLOODPLAIN MAPS, THE SITE IS LOCATED IN AN AREA DESIGNATED AS ZONE AE (BFE: 10'). COMMUNITY PANEL NO. :12033C0315G DATED: 09/29/2006.


NO WETLAND AREAS HAVE BEEN INVESTIGATED BY THIS SPECIFIC PURPOSE SURVEY.

ALL ZONING INFORMATION SHOULD BE VERIFIED WITH THE PROPER ZONING OFFICIALS.

ANY UNDERGROUND UTILITIES SHOWN HAVE BEEN LOCATED FROM ABOVE GROUND FIELD SURVEY INFORMATION. THE SURVEYOR MAKES NO GUARANTEES THAT ANY UNDERGROUND UTILITIES SHOWN COMPRISE ALL SUCH UTILITIES IN THE AREA, EITHER INSERVICE OR ABANDONED. THE SURVEYOR FURTHER DOES NOT WARRANT THAT ANY UNDERGROUND UTILITIES SHOWN ARE IN THE EXACT LOCATION INDICATED ALTHOUGH THEY ARE LOCATED AS ACCURATELY AS POSSIBLE FROM INFORMATION AVAILABLE. THE SURVEYOR HAS NOT PHYSICALLY LOCATED ANY UNDERGROUND UTILITIES

ADDITIONS OR DELETIONS TO THIS SURVEY MAP BY OTHER THAN THE SIGNING PARTY IS PROHIBITED WITHOUT WRITTEN CONSENT OF THE SIGNING PARTY

ORIGINAL SURVEY IS KEPT ON FILE IN THE SURVEYOR'S OFFICE.

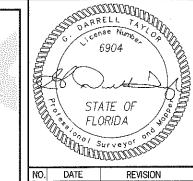

NO.	DATE	REVISION
1	5/14/2020	CLIENT COMMENTS
2	5/18/2020	TITLE REVIEW - JHC
3	9/1/2020	LAND SPACE -DMM
4	9/16/2020	1A LOCATION - DMM

Business License Number: LB8148 100 Governors Trace, Ste. 103 Peachtree City, GA 30269 (direct) 678.565.4440 (fax) 678.565.4497 (w) p2pls.com

2

SPECIFIC PURPOSE SURVEY PREPARED FOR:



**RIVERVIEW** 

SECTION 1, T-1-S, R-29-W, SECTION 21, T-1-N, R-29-W & SECTION 29, T-1-N, R-30-W ESCAMBIA COUNTY, FLORIDA

DRAWN BY: JHC


CHECKED BY: JKL

APPROVED: D. MILLER DATE: FEBRUARY 13, 2020

Call before you dig. P2P JOB #: 200181FL

Know what's below.

SURVEY NOT VALID WITHOUT SHEET 2 OF 2

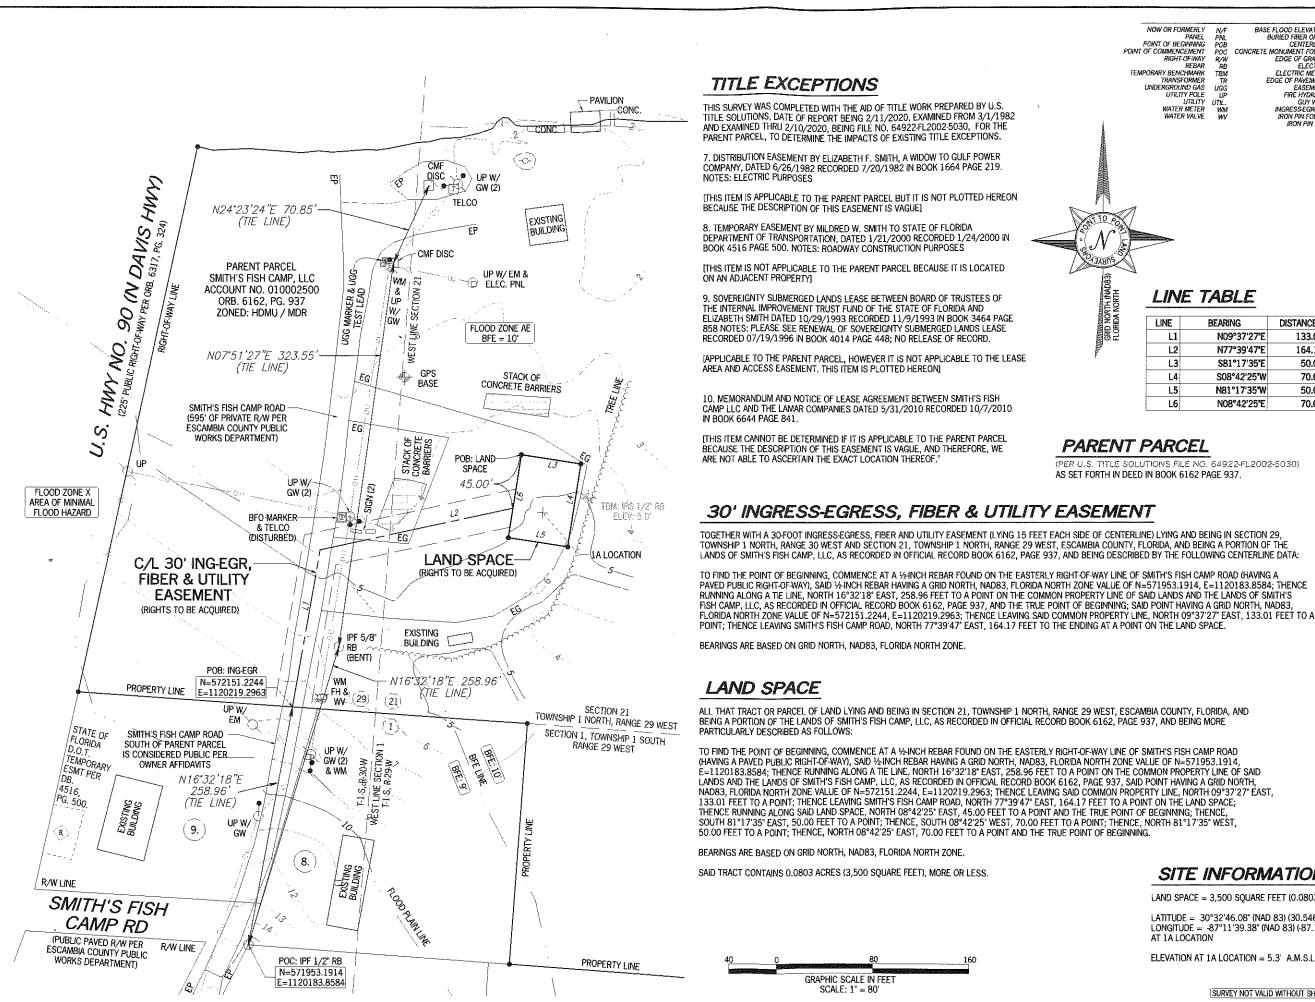

## TITLE EXCEPTIONS

TITLE SOLUTIONS, DATE OF REPORT BEING 2/11/2020, EXAMINED FROM 3/1/1982 AND EXAMINED THRU 2/10/2020, BEING FILE NO. 64922-FL2002-5030, FOR THE

(THIS ITEM IS APPLICABLE TO THE PARENT PARCEL BUT IT IS NOT PLOTTED HEREON BECAUSE THE DESCRIPTION OF THIS EASEMENT IS VAGUE)

8. TEMPORARY EASEMENT BY MILDRED W. SMITH TO STATE OF FLORIDA DEPARTMENT OF TRANSPORTATION, DATED 1/21/2000 RECORDED 1/24/2000 IN BOOK 4516 PAGE 500. NOTES: ROADWAY CONSTRUCTION PURPOSES

[THIS ITEM IS NOT APPLICABLE TO THE PARENT PARCEL BECAUSE IT IS LOCATED ON AN ADJACENT PROPERTY]

9. SOVEREIGNTY SUBMERGED LANDS LEASE BETWEEN BOARD OF TRUSTEES OF THE INTERNAL IMPROVEMENT TRUST FUND OF THE STATE OF FLORIDA AND ELIZABETH SMITH DATED 10/29/1993 RECORDED 11/9/1993 IN BOOK 3464 PAGE 858 NOTES: PLEASE SEE RENEWAL OF SOVEREIGNTY SUBMERGED LANDS LEASE RECORDED 07/19/1996 IN BOOK 4014 PAGE 448; NO RELEASE OF RECORD.

CAMP LLC AND THE LAMAR COMPANIES DATED 5/31/2010 RECORDED 10/7/2010 IN BOOK 6644 PAGE 841

ITHIS ITEM CANNOT BE DETERMINED IF IT IS APPLICABLE TO THE PARENT PARCEL BECAUSE THE DESCRIPTION OF THIS EASEMENT IS VAGUE, AND THEREFORE, WE ARE NOT ABLE TO ASCERTAIN THE EXACT LOCATION THEREOF."

GRAPHIC SCALE IN FEET

SCALE: 1" = 80'

THIS SURVEY WAS COMPLETED WITH THE AID OF TITLE WORK PREPARED BY U.S. PARENT PARCEL, TO DETERMINE THE IMPACTS OF EXISTING TITLE EXCEPTIONS.

7. DISTRIBUTION EASEMENT BY ELIZABETH F. SMITH, A WIDOW TO GULF POWER COMPANY, DATED 6/26/1982 RECORDED 7/20/1982 IN BOOK 1664 PAGE 219. NOTES: ELECTRIC PURPOSES

[APPLICABLE TO THE PARENT PARCEL, HOWEVER IT IS NOT APPLICABLE TO THE LEASE AREA AND ACCESS EASEMENT. THIS ITEM IS PLOTTED HEREON]

10. MEMORANDUM AND NOTICE OF LEASE AGREEMENT BETWEEN SMITH'S FISH

# UTILITY POLE UTILITY WATER METER

LINE TABLE

REARING

N09°37'27"E

N77°39'47"E

S81°17'35"E

S08°42'25'W

N81°17'35'W

N08°42'25"E

LINE

L3

L4

L5

L6

(PER U.S. TITLE SOLUTIONS FILE NO. 64922-FL2002-5030)


PARENT PARCEL

AS SET FORTH IN DEED IN BOOK 6162 PAGE 937.

NOW OR FORMERLY PANEL POINT OF BEGINNING

POINT OF COMMENCEMENT RIGHT-OF-WAY REBAR

TEMPORARY BENCHMARK TRANSFORMER UNDERGROUND GAS

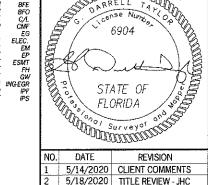

NO.	DATE	REVISION
1	5/14/2020	CLIENT COMMENTS
2	5/18/2020	TITLE REVIEW - JHC
3	9/1/2020	LAND SPACE DMM
4	9/16/2020	1A LOCATION - DMM

OARRELL TATALON 6904

LEGEND

BASE FLOOD ELEVATION BURIED FIBER OPTIC CENTERLINE

EDGE OF GRAVEL ELECTRIC ELECTRIC METER

EDGE OF PAVEMENT EASEMENT FIRE HYDRANT GUY WIRE

INGRESS-EGRESS IRON PIN FOUND IRON PIN SET

DISTANCE

133.01

164.17

70.00'


50.00

70.00'

LB8148 103

URVEYOR 

565.4440 (fax) 678.565 Number: I ace, Ste. 3

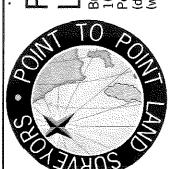

SPECIFIC PURPOSE SURVEY PREPARED FOR



### **RIVERVIEW**

SECTION 1, T-1-S, R-29-W, SECTION 21, T-1-N, R-29-W & SECTION 29, T-1-N, R-30-W ESCAMBIA COUNTY, FLORIDA

CHECKED BY: JKL

DATE: FEBRUARY 13, 2020

P2P JOB #: 200181FL

SITE INFORMATION

LAND SPACE = 3,500 SQUARE FEET (0.0803 ACRES)


LATITUDE = 30°32'46.08" (NAD 83) (30.546134°) LONGITUDE = -87°11'39.38" (NAD 83) (-87.194272°) AT 1A LOCATION


ELEVATION AT 1A LOCATION = 5.3' A.M.S.L.

SURVEY NOT VALID WITHOUT SHEET 1 OF 2

DRAWN BY: JHC

APPROVED: D. MILLER

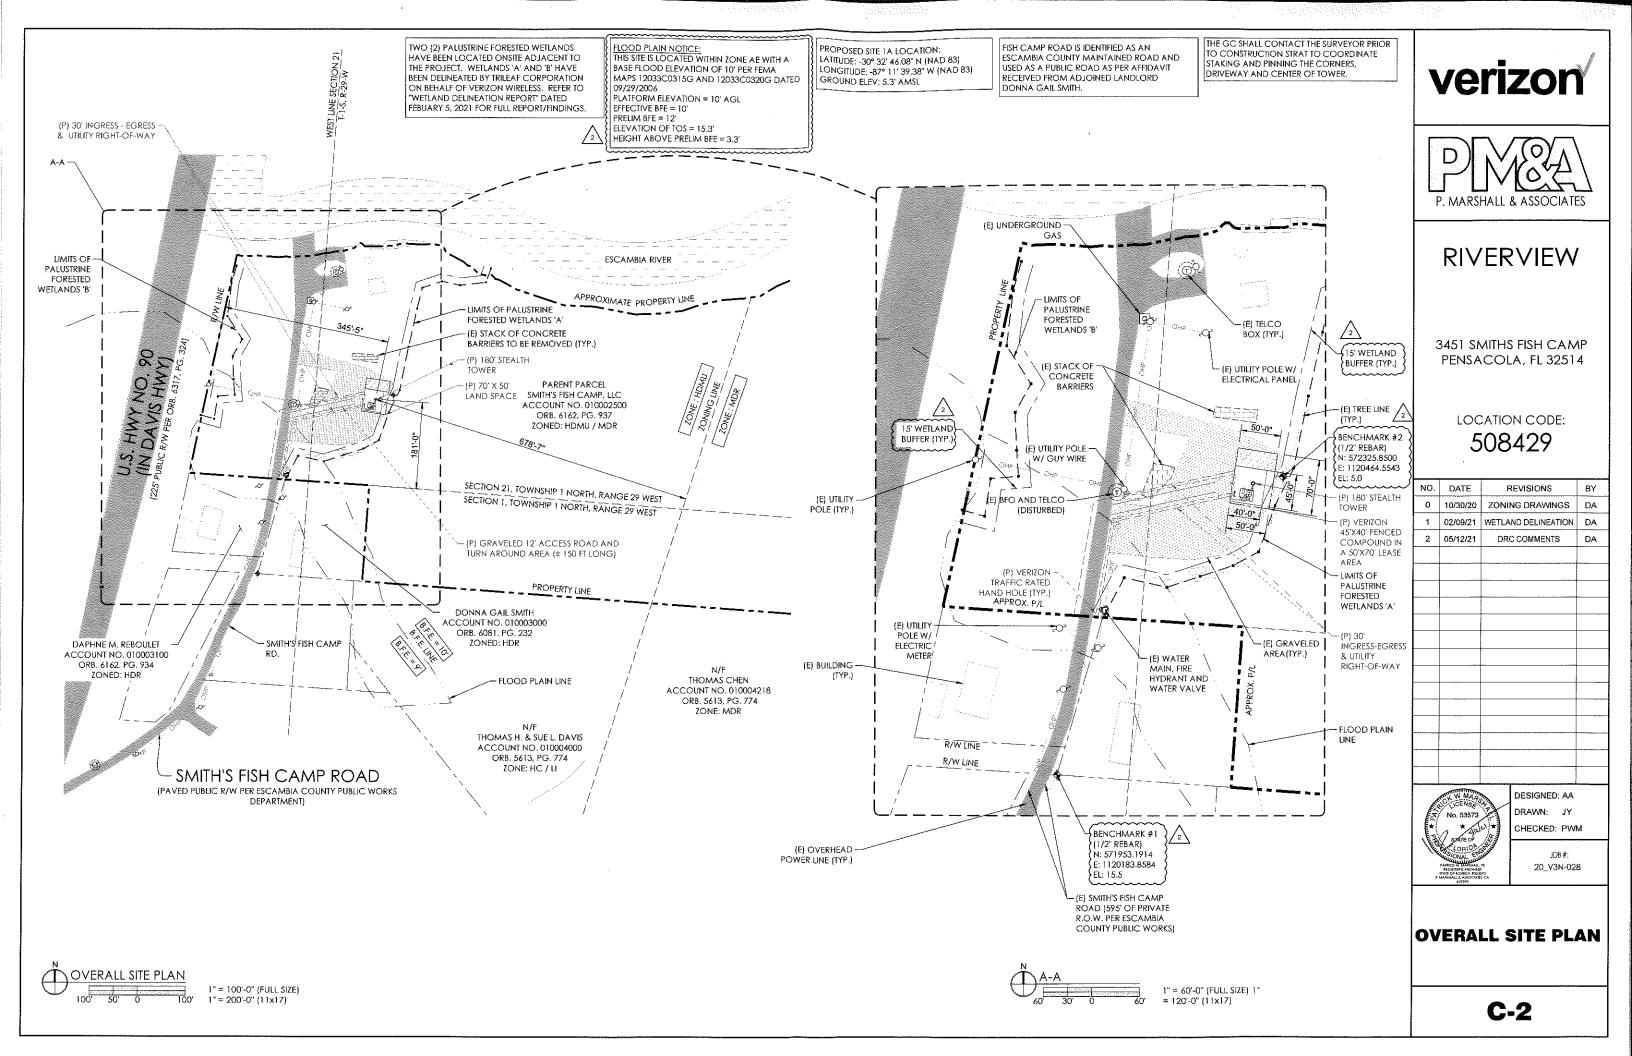

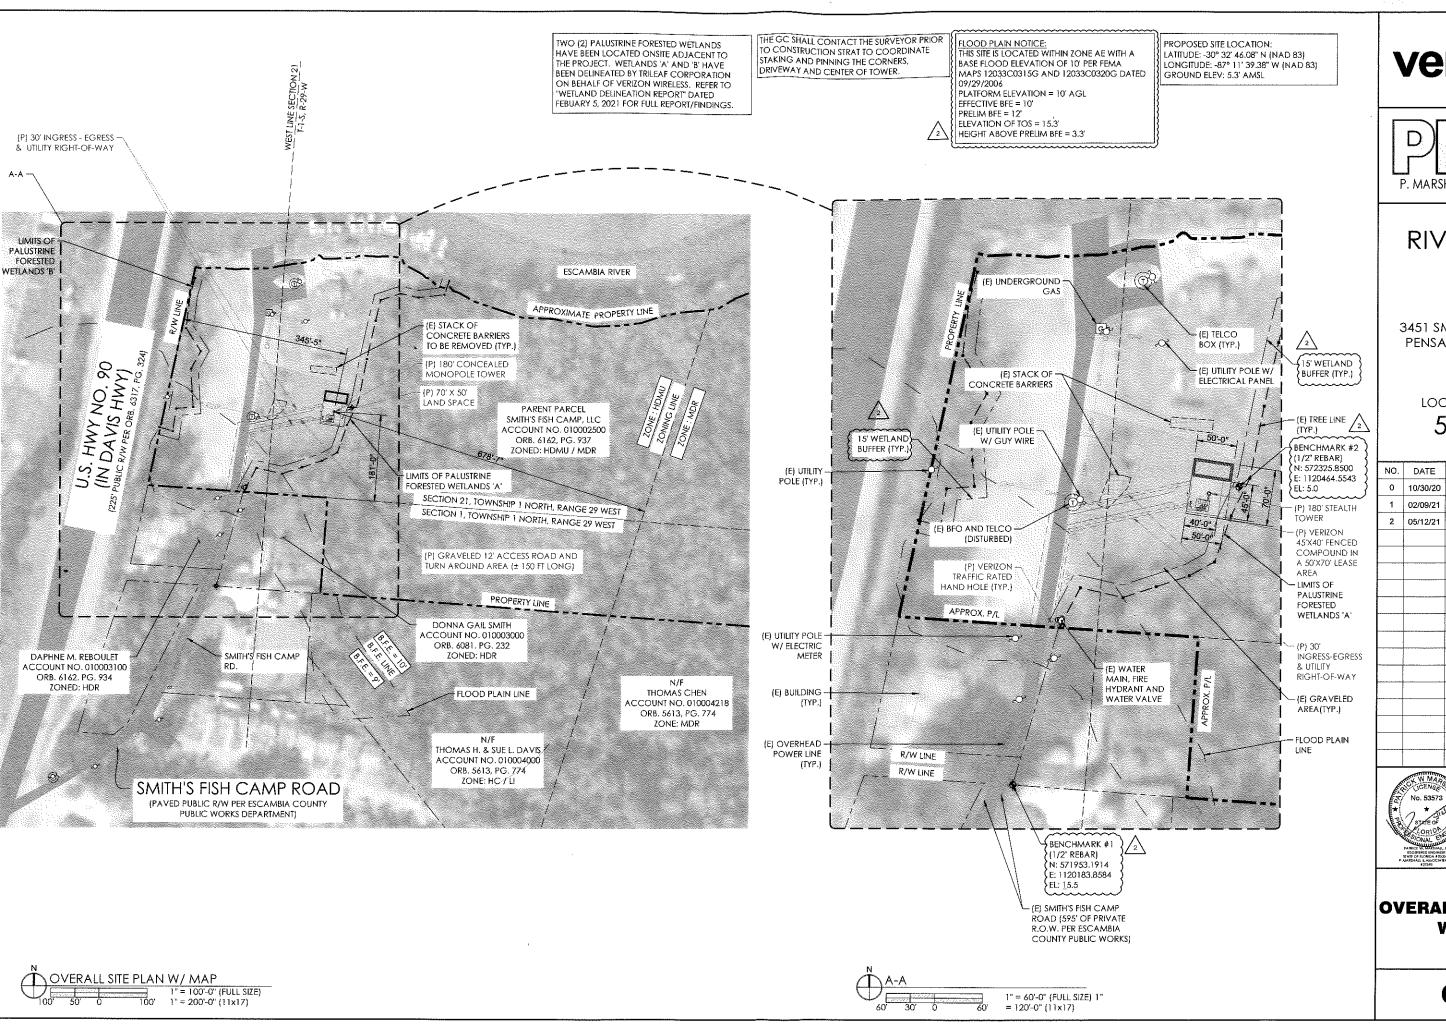

verizon



**RIVERVIEW** 

3451 SMITHS FISH CAMP PENSACOLA, FL 32514

LOCATION CODE:

508429

REVISIONS

BY

		l. '		
0	10/30/20	ZONI	NG DRAWING	S DA
1	02/09/21	WETLA	ND DELINEATION	ON DA
2	05/12/21	DR	C COMMENTS	DA
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	W MAG		DESIGNED:	ΔΔ





DRAWN: JY CHECKED: PWM

JOB#: 20_V3N-028

**OVERALL SITE PLAN** W/ MAP


C-2A

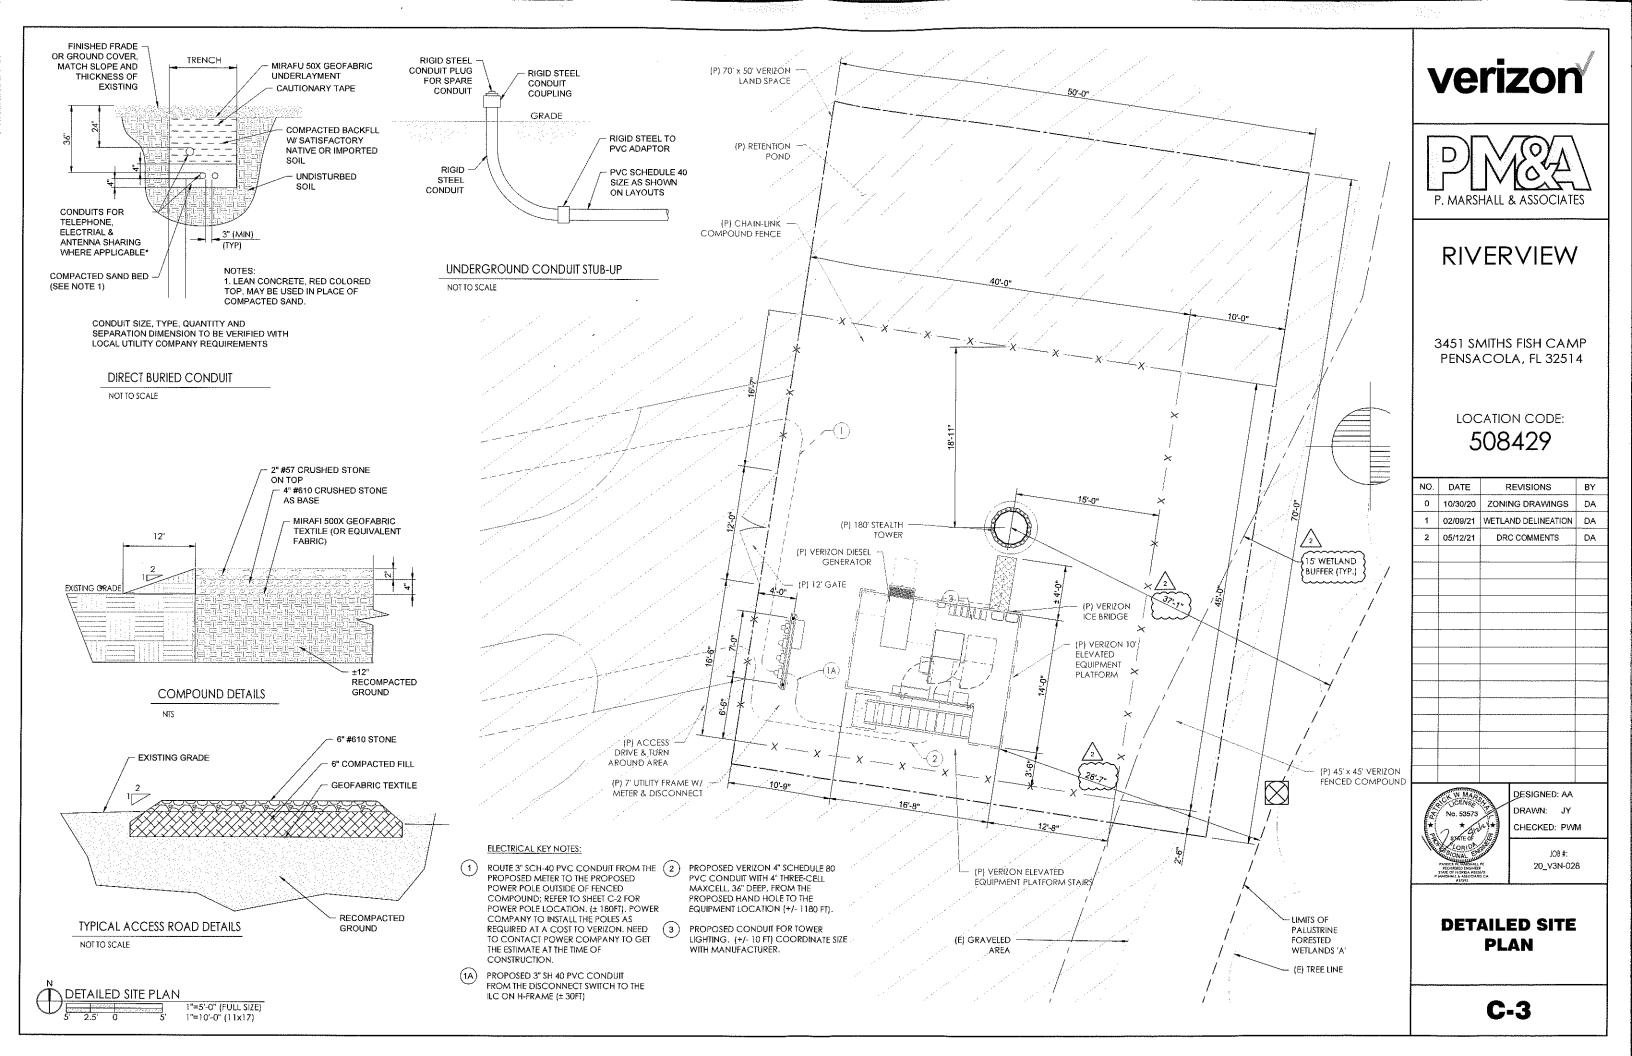

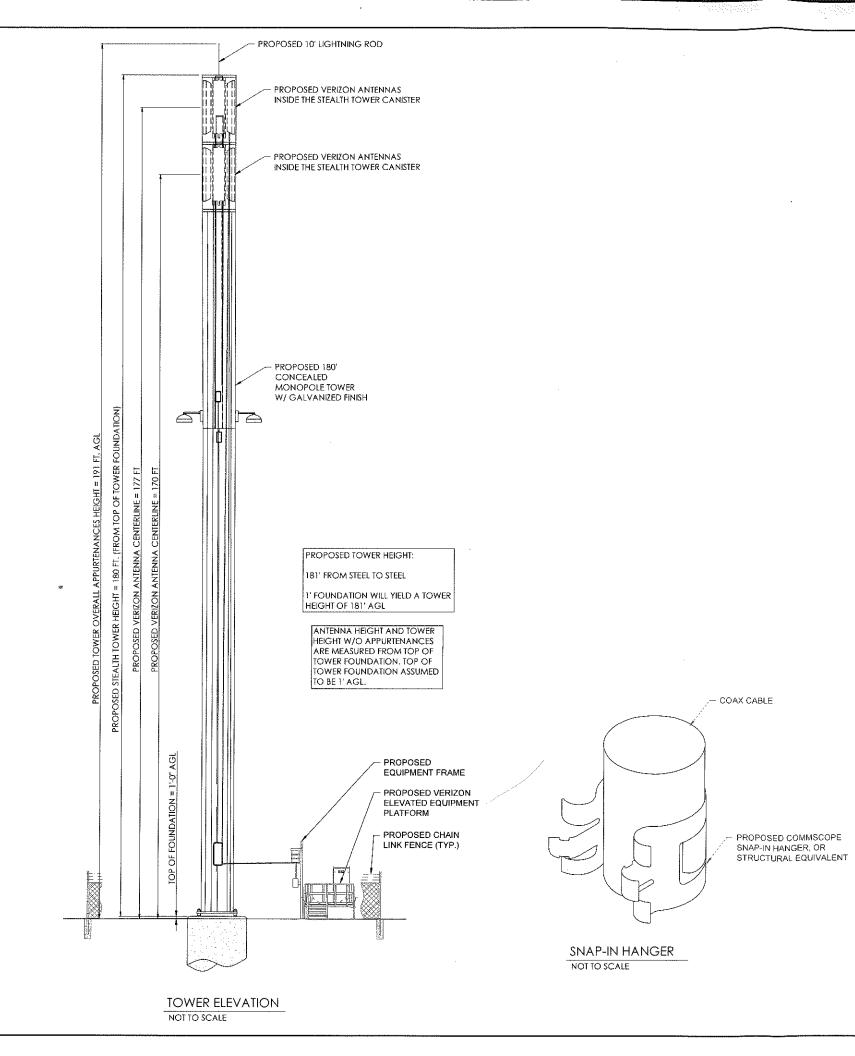

ANTENNAS & ANTENNA MOUNT SHOWN ONLY FOR REFERENCE. REFER TO FINAL ANTENNA ORIENTATION ON SHEET CS FOR ACTUAL ANTENNA LAYOUT & ORIENTATION.

ADJUST PLACEMENT OF RRH & OVP BOXES AS REQUIRED SO THAT THE CLIMBING LADDER WILL NOT BE IMPEDED.

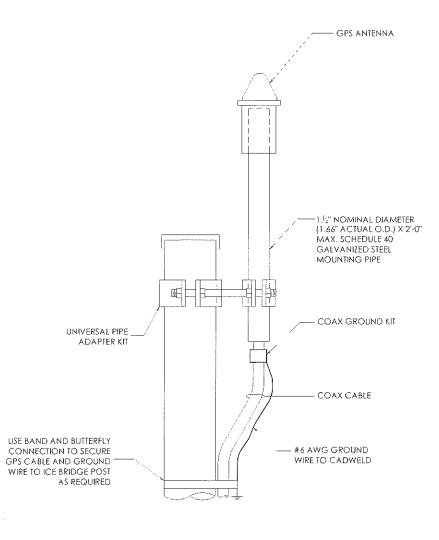

GPS ANTENNA MOUNTING DETAIL NOT TO SCALE

## verizon



## **RIVERVIEW**

3451 SMITHS FISH CAMP PENSACOLA, FL 32514

LOCATION CODE: 508429

NO. DATE REVISIONS BY

0 10/30/20 ZONING DRAWINGS DA

1 02/09/21 WETLAND DELINEATION DA

DESIGNED: AA

DRAWN: JY

## **TOWER ELEVATION**

CHECKED: PWM

JOB#:


20_V3N-028

			FII	nal antenna & Cable Conf	FIGURATION		
RAD CENTER	SECTOR	AZIMUTH (DEGREES)	QUANT.	AWS (2100 MHZ) ANTENNAS	MECHANICAL DOWNTILT	COAX CABLE	COAX JUMPER CABLE LENGTH
	1	1 100 1 SHAR		SHARED W/ 700 LTE & 850 LTE	0		
177'	2	210	1	SHARED W/ 700 LTE & 850 LTE	0	SHARED	(SHARED) COAX JUMPERS
	3	360	1	SHARED W/ 700 LTE & 850 LTE	0		
RAD CENTER	SECTOR	AŽIMUTH (DEGREES)	QUANT.	LTE (700 MHZ) ANTENNAS	MECHANICAL DOWNTILT	COAX CABLE	COAX JUMPER LENGTH
1 10		100	1	PROPOSED CSS FLG-X7CAP-665-2C	0	(12) 7/8" COAX	(1) COAX JUMPER +/-11'
177'	2	210	1	PROPOSED CSS FLG-X7CAP-665-2C	0	CABLES LENGTH OF CABLE	(1) COAX JUMPER +/-12'
3 360		1	PROPOSED CSS FLG-X7CAP-665-2C	0	* LENGTH: ±200' *	(1) COAX JUMPER +/-7	
RAD CENTER	SECTOR	AZIMUTH (DEGREES)	QUANT.	PCS (1900 MHZ) ANTENNAS	MECHANICAL DOWNTLT	COAX CABLE	COAX JUMPER CABLE LENGTH
	1	100	1	SHARED W/ 700 LTE & 850 LTE	0		
170'	2	210	1	SHARED W/ 700 LTE & 850 LTE	0	SHARED	(SHARED)
	3	360	1	Shared W/ 700 lte & 850 lte	0		
RAD CENTER	SECTOR	azimuth (degrees)	QUANT,	850 LTE ANTENNAS	MECHANICAL DOWNTILT	COAX CABLE	COAX JUMPER LENGTH
	1	100	1	PROPOSED CSS FLG-X7CAP-665-2C	0	1101 710" COAY	(1) COAX JUMPER +/-11'
170'	2	210	1	PROPOSED CSS FLG-X7CAP-665-2C	0	(12) 7/8" COAX CABLES LENGTH OF CABLE	(1) COAX JUMPER +/-12'
	3	360	1	PROPOSED CSS FLG-X7CAP-665-2C	0	" LENGTH: ±190' *	(1) COAX JUMPER +/-7'

QUANTITY	antenna mounts
3	PROPOSED PERFECT VISION ANTENNA MOUNTS
QUANTITY	OVPs
1	PROPOSED RAYCAP RV2DC-6627-PF48 OVP (GROUND LEVEL)
QUANTITY	RRHs
3	PROPOSED SAMSUNG B2/B66A RRH BR049 (RFV01U-D1A)
3	PROPOSED SAMSUNG B5/B13 RRH-BR04C (RFV01U-D2A)
QUANTITY	DIPLEXERS
3	PROPOSED JMA CSS WIRELESS DBC-A-P-2SF


CONTRACTOR TO MATCH THE LENGTHS OF 1x2 HYBRID JUMPERS WITH THE CORRECT SECTORS AS REQUIRED. RRH'S & OVP'S TO BE MOUNTED IN A MANNER NOT TO INTERFERE WITH THE TOWER CLIMBING APPARATUS

VERIZON APPROVED PERFECT VISION ANTENNA MOUNT TO BE USED

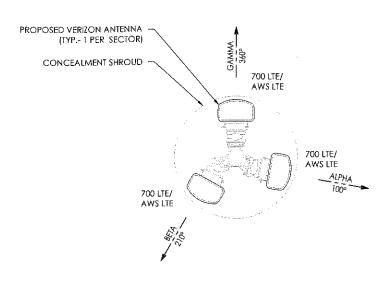

### ANTENNA ORIENTATION (177' RAD CENTER)

NOTTO SCALE

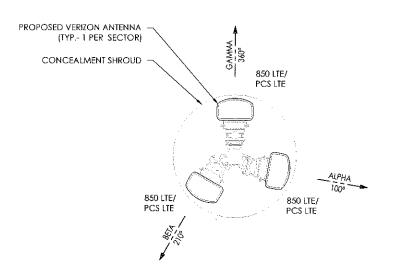

ANTENNA ORIENTATION (170' RAD CENTER) NOT TO SCALE

## verizon



## **RIVERVIEW**

3451 SMITHS FISH CAMP PENSACOLA, FL 32514

> LOCATION CODE: 508429


NO.	DATE	REVISIONS	BY
0	10/30/20	ZONING DRAWINGS	DA
1	02/09/21	WETLAND DELINEATION	DA
			***************************************
***************************************			
***************************************			
		***************************************	



DESIGNED: AA DRAWN: JY CHECKED: PWM

> JOB #: 20_V3N-028

**ANTENNA ORIENTATION** 

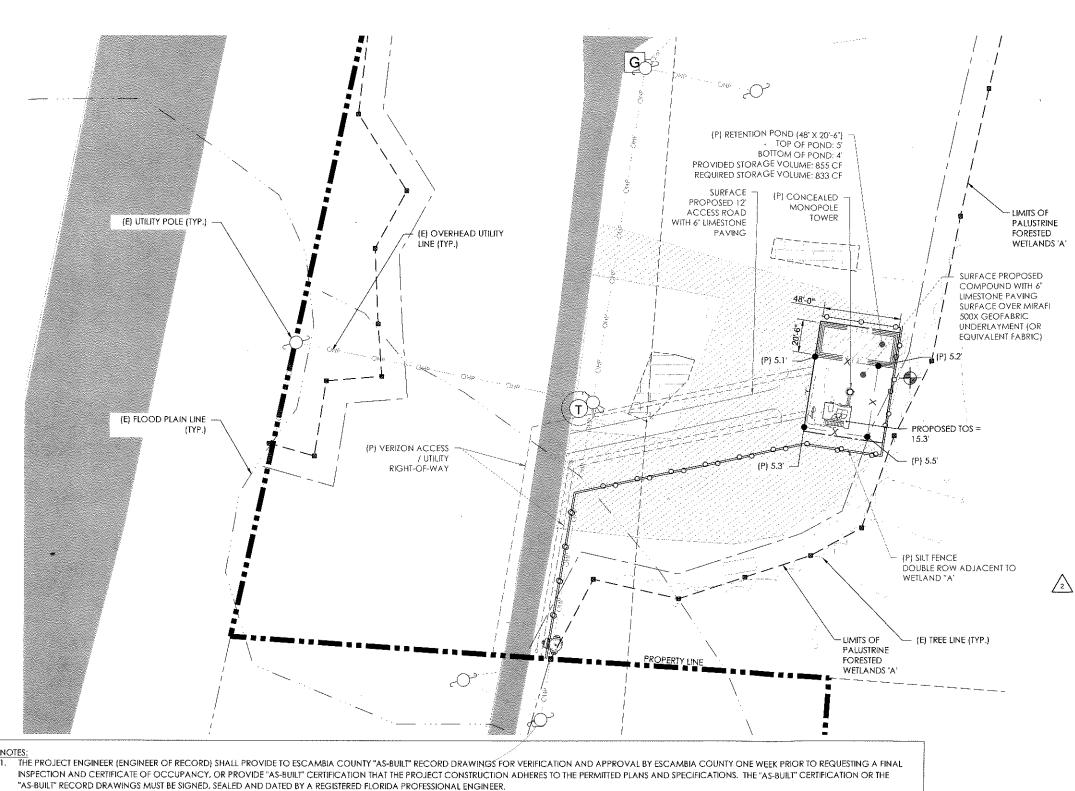

CONSTRUCTION EXIT - TO REDUCE OR ELIMINATE THE TRANSPORT OF MUD FROM THE CONSTRUCTION AREA ONTO PUBLIC RIGHT-OF-WAYS, STREETS, ALLEYS, SIDEWALKS, OR PARKING AREAS.

TYPE C SEDIMENT BARRIER - TO PREVENT ANY SEDIMENT CARRIED BY SHEET FLOW FROM LEAVING THE SITE AND ENTERING NATURAL DRAINAGE WAYS

DISTURBED AREA STABILIZATION (TEMPORARY) - TO ESTABLISH A TEMPORARY VEGETATIVE COVER WITH FAST GROWING SEEDINGS ON DISTURBED AREAS.

DISTURBED AREA STABILIZATION (PERMANENT) - TO ESTABLISH A PERMANENT VEGETATIVE COVER SUCH AS TREES, SHRUBS, VINES, GRASSES, SOD, OR LEGUMES ON DISTURBED AREAS.

DISTURBED AREA DUST CONTROL - TO CONTROL THE SURFACE AND AIR MOVEMENT OF DUST ON CONSTRUCTION SITES, ROADWAYS, AND SIMILAR

DISTURBED AREAS LEFT IDLE SHALL BE STABILIZED WITH TEMPORARY VEGETATION AFTER 14 DAYS; AFTER 30 DAYS PERMANENT VEGETATION SHALL BE

MAINTENANCE STATEMENT EROSION CONTROL MEASURES WILL BE INSPECTED AT LEAST WEEKLY, AFTER EACH RAIN AND REPAIRED BY THE GENERAL CONTARACTOR

ADDITIONAL EROSION CONTROL MEASURES WILL BE INSTALLED IF DEEMED NECESSARY BY ON-SITE INSPECTION

PROPOSED SITE LOCATION: LATITUDE: -30° 32' 46.08" N (NAD 83) LONGITUDE: -87° 11' 39.38" W (NAD 83) GROUND ELEV: 5.3' AMSL

FLOOD PLAIN NOTICE: THIS SITE IS LOCATED WITHIN ZONE AE WITH A BASE FLOOD ELEVATION OF 10' PER FEMA MAPS 12033C0315G AND 12033C0320G DATED 09/29/2006 PLATFORM ELEVATION = 10' AGL EFFECTIVE BFE = 10'
PRELIM BFE = 12' ELEVATION OF TOS = 15.3' HEIGHT ABOVE PRELIM BFE = 3.3'

#### DRAINAGE COMMENTARY:

RUNOFF FROM THE SITE DRAINS INTO A PROPOSED RETENTION POND NORTH OF THE COMPOUND (SEE SHEET C-7 FOR CALCULATIONS). THE POND IS SIZED TO RETAIN AND INFILTRATE THE FIRST 0.5" OF RUNOFF. THE REMAINING RUNOFF WILL CONTINUE AS SHEET FLOW FLOWING NORTH, EVENTUALLY DRAINING INTO THE ESCAMBIA RIVER.

TWO (2) PALUSTRINE FORESTED WETLANDS HAVE BEEN LOCATED ONSITE ADJACENT TO THE PROJECT. WETLANDS 'A' AND 'B' HAVE BEEN DELINEATED BY TRILEAF CORPORATION ON BEHALF OF VERIZON WIRELESS. REFER TO

"WETLAND DELINEATION REPORT" DATED FEBUARY 5, 2021 FOR FULL REPORT/FINDINGS

## verizon



## **RIVERVIEW**

3451 SMITHS FISH CAMP PENSACOLA, FL 32514

> LOCATION CODE: 508429

NO.	DATE	REVISIONS	BY
0	10/30/20	ZONING DRAWINGS	DA
1	02/09/21	WETLAND DELINEATION	DA
2	05/12/21	DRC COMMENTS	DA
	·····		




DESIGNED: AA DRAWN: JY CHECKED: PWM

> JOB#: 20_V3N-028

GRADING, **SEDIMENT & EROSION CONTROL PLAN** 

**C-6** 

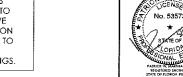

GRADING, SEDIMENT & EROSION CONTROL PLAN

ANY DAMAGE TO EXISTING ROADS DURING CONSTRUCTION WILL BE REPAIRED BY THE DEVELOPER PRIOR TO FINAL "AS-BUILT" SIGN OFF FROM THE COUNTY, THERE WILL BE NO IMPACT TO THE ADJACENT PROPERTIES OR DRAINAGE SYSTEMS FOR THE POST DEVELOPMENT CONDITIONS.

DIMENSIONS, ELEVATIONS, GRADING ETC. RECORD DRAWINGS SHALL BE PROVIDED TO THE ENGINEER OF RECORD PRIOR TO REQUESTING FINAL INSPECTION.

ALL ASPECTS OF THE STORMWATER/DRAINAGE COMPONENTS AND/OR TRANSPORTATION COMPONENTS SHALL BE COMPLETED PRIOR TO ISSUANCE OF A FINAL CERTIFICATE OF OCCUPANCY.

NO DEVIATIONS OR REVISIONS FROM THESE PLANS BY THE CONTRACTOR SHALL BE ALLOWED WITHOUT PRIOR APPROVAL FROM BOTH THE DESIGN ENGINEER AND THE ESCAMBIA COUNTY. ANY DEVIATIONS MAY RESULT IN

RETENTION/DETENTION AREAS SHALL BE SUBSTANTIALLY COMPLETE PRIOR TO ANY CONSTRUCTION ACTIVITIES THAT MAY INCREASE STORMWATER RUNOFF RATES. THE CONTRACTOR SHALL CONTROL STORMWATER DURING ALL

DEVELOPER/CONTRACTOR SHALL RESHAPE PER PLAN SPECIFICATIONS, CLEAN OUT ACCUMULATED SILT, AND STABILIZE RETENTION/DETENTION POND(S) AT THE END OF CONSTRUCTION WHEN ALL DISTURBED AREAS HAVE BEEN

THE OWNER OR HIS AGENT SHALL ARRANGE/SCHEDULE WITH THE COUNTY A FINAL INSPECTION OF THE DEVELOPMENT UPON COMPLETION AND ANY INTERMEDIATE INSPECTIONS AT (850) 595-3472. AS-BUILT CERTIFICATION (S

THE CONTRACTOR SHALL INSTALL PRIOR TO THE START OF CONSTRUCTION AND MAINTAIN DURING CONSTRUCTION ALL SEDIMENT CONTROL MEASURES AS REQUIRED TO RETAIN ALL SEDIMENTS ON THE SITE. IMPROPER

CONTRACTOR SHALL MAINTAIN RECORD DRAWINGS DURING CONSTRUCTION WHICH SHOW "AS-BUILT" CONDITIONS OF ALL WORK INCLUDING PIPING, DRAINAGE STRUCTURES, TOPO OF POND(S), OUTLET STRUCTURES,

THE CONTRACTOR SHALL NOTIFY FDOT 48 HOURS IN ADVANCE PRIOR TO INITIATING ANY WORK IN THE STATE RIGHT-OF-WAY.

PHASES OF CONSTRUCTION AND TAKE ADEQUATE MEASURES TO PREVENT THE EXCAVATED POND FROM BLINDING DUE TO SEDIMENTS.

ALL DISTURBED AREAS WHICH ARE NOT PAVED SHALL BE STABILIZED WITH SEEDING, FERTILIZER AND MULCH, HYDROSEED AND/OR SOD.


(13.) NOTIFY SUNSHINE UTILITIES 48 HOURS IN ADVANCE PRIOR TO DIGGING WITHIN R/W; 1-800-432-4770.

SEDIMENT CONTROL MEASURES MAY RESULT IN CODE ENFORCEMENT VIOLATION.

DELAYS IN OBTAINING A CERTIFICATE OF OCCUPANCY

STABILIZED AND PRIOR TO REQUEST FOR INSPECTION

REQUIRED PRIOR TO REQUEST FOR FINAL INSPECTION/APPROVAL.

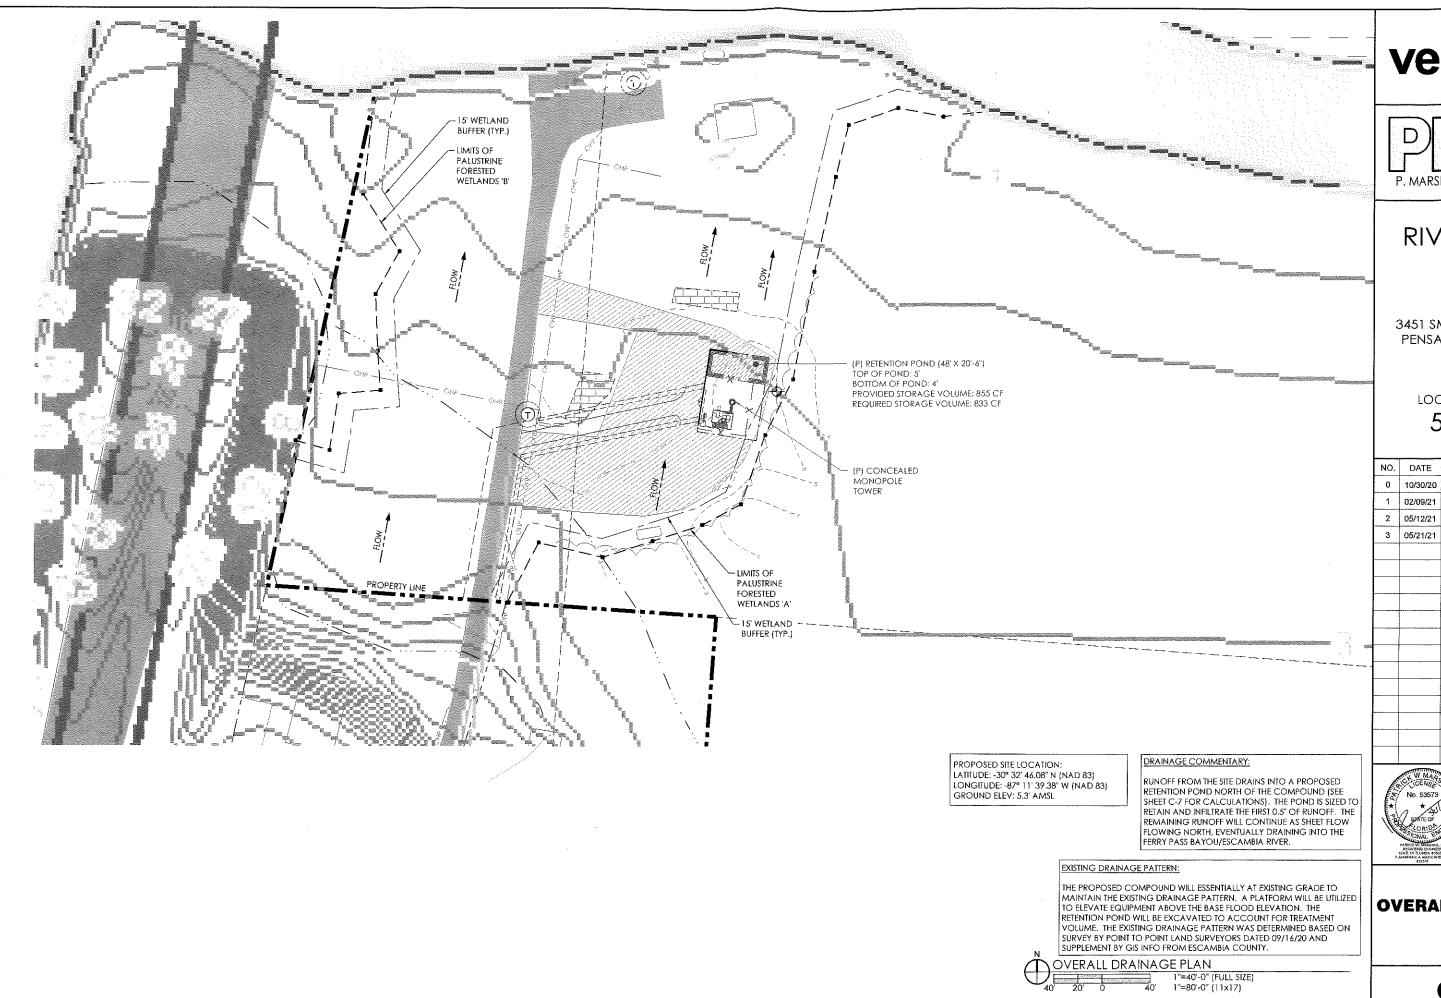

## verizon



## **RIVERVIEW**

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508429

NO.	DATE	REVISIONS	BY
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2	05/12/21	DRC COMMENTS	DA
3	05/21/21	DRC COMMENTS	DA
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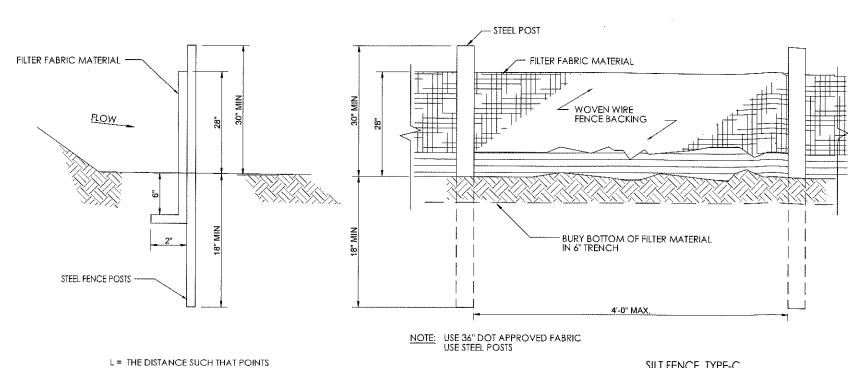


DESIGNED: AA DRAWN: JY CHECKED: PWM

20_V3N-028

**OVERALL DRAINAGE PLAN** 


C-6A




A AND B ARE OF EQUAL ELEVATION.

9" SPACING BETWEEN CHECK DAMS

#### STONE CHECK DAM

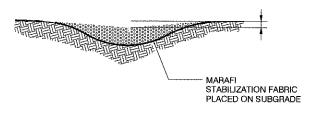

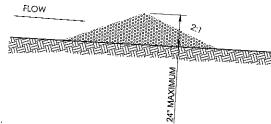

NOTES:


CHECK DAMS TO BE CONSTRUCTED OF GRADED SIZE 2 - 10 INCH STONE.

MECHANICAL OR HAND PLACEMENT SHALL BE REQUIRED TO INSURE

COMPLETE COVERAGE OF ENTIRE WIDTH OF DITCH OR SWALE AND THAT CENTER OF DAM IS LOWER THAN EDGES.


SEDIMENT TO BE REMOVED WHEN A LEVEL OF 1/2 THE ORIGINAL DAM HEIGHT OR LESS IS REACHED. REMOVE CHECK DAMS AT COMPLETION OF PROJECT AND TREAT RESULTING DISTURBED AREAS AS REQUIRED.

CHECK DAM NOT TO SCALE

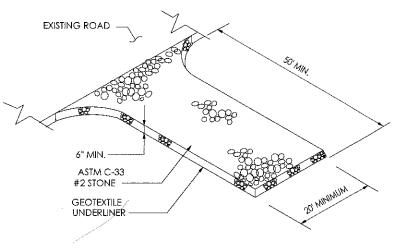

SILT FENCE, TYPE-C

**CONSTRUCTION EXIT** 

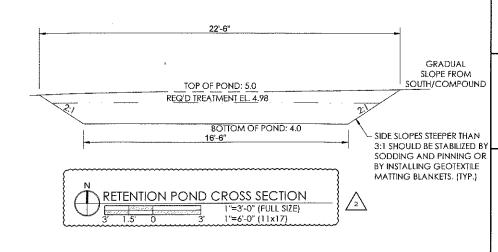

PMEA	Recovery Time and Treatment Volume			Proj Name: Riverview Proj No: 20V3N-028 Rev: 1 Date: 05/12/21
		Site Data		
Drainage Area	=	0.54	AC	
Impervious Area	=	0.54	AC	
Percent Impervious	=	100	%	
Offsite drainage area	=	0.00	AC	
f	=	0.30		
K _{trs}	=	1.14	ft/day	See Note 1.
FS .	*	2.00		
l _d	=	0.57	ft/day	
	*			
		Proposed Retention	basin	-
	*			
Stage (ft)	Area (ft²)	Storage (ft³)		
4	727.7	0		
4.5	852.8	395.13		
5	985,8	854.78		
	For 0.5	5" of runoff (Off Line	Retention)	
Runoff	=	0.50	in	
Total treatment volume	<b>=</b>	833,09	ft³	Based on Rational Method
Treatment Volume Elevation	=	4,976	ft	
Treatment volume depth, h _v	=	0.976	ft	
Height of water table to basin bottom	=	3.50	ft	
Height of water to saturate the soil, hu	=	1.0500	ft	
h _v <h<sub>u</h<sub>	<b>→</b>	No Saturated La	teral Flow	
	:	Stage One (V _u ) Infilt	ration	
Pond Bottom Area	=	727.70	ft ²	
Stage One Treatment Volume (V _u )	=	764.09	ft³	
Kve	=	0.760	ft/day	
la	<b>#</b>	0.380	ft/day	
Csat	<b>#</b>	1.579	daγ	
			-	
		Recovery Time		
Stage One Recovery Time	=	1.579	ft	
Total Recovery Time	=	1.58	days	

1. From NRCS Soil Survey

POND CALCULATIONS NOT TO SCALE

verizon



## **RIVERVIEW**

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1	02/09/21	WETLA	ND DELINEATI	ON I	DΑ
2	05/12/21	DR	COMMENTS		DΑ
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	W MAS	».	DESIGNED:	AA	



DRAWN: JY CHECKED: PWM

> JOB #: 20_V3N-028

GRADING, **SEDIMENT & EROSION CONTROL DETAILS** 

#### PIEDMONT VEGETATIVE COVERS

CALENDAR MONTH	TEMPORARY SEED	APPLICATION RATE/ACRE	PERMANENT SEED	APPLICATION RATE/ACRE
1. January	RYE GRASS	40-50 LB.	UNHULLED BERMUDA SERICEA LESPEDEZA	2 8-10 LB. 1 30-40 LB. 1
2. FEBRUARY			UNHULLED BERMUDA SERICEA LESPEDEZA FESCUE	2 8-10 LB. 30-40 LB. 30-50 LB.
3. MARCH	RYE ANNUAL LESPEDEZA WEEPING LOVE GRASS	2-3 BU. 20-25 LB. 4-6 LB.	UNHULLED BERMUDA SERICEA LESPEDEZA FESCUE	8-10 LB. 30-40 LB. 30-50 LB.
4. APRIL	RYE BROWN TOP MILLET ANNUAL LESPEDEZA SUDAN ANNUAL	2-3 BU. 30-40 LB. 20-25 LB. 35 LB.	WEEPING LOVE GRASS HULLED BERMUDA BAHIA	4-6 LB. 5-6 LB. 40-60 LB.
5. MAY	WEEPING LOVE GRASS SUDAN GRASS BROWN TOP MILLET	4-6 LB. 35 LB. 30-40 LB.	WEEPING LOVE GRASS HULLED BERMUDA BAHIA	4-6 LB. 5-6 LB. 40-60 LB.
6. JUNE	WEEPING LOVE GRASS SUDAN GRASS BROWN TOP MILLET	4-6 LB. 35 LB. 30-40 LB.	WEEPING LOVE GRASS HULLED BERMUDA BAHIA	4-6 LB. 5-6 LB. 40-60 LB.
7. JULY	WEEPING LOVE GRASS SUDAN GRASS BROWN TOP MILLET	4-6 LB. 35 LB. 30-40 LB.		
8. AUGUST	RYE GRASS WEEPING LOVE GRASS	40-50 LB. 4-6 LB.		
9. SEPTEMBER	,		TALL FESCUE	30-50 LB.
10. OCTOBER	WHEAT	2-3 BU.	UNHULLED BERMUDA SERICEA LESPEDEZA FESCUE	8-10 LB. 30-40 LB. 30-50 LB.
11. NOVEMBER	WHEAT	2-3 BU.	UNHULLED BERMUDA SERICEA LESPEDEZA FESCUE	8-10 LB. 30-40 LB. 30-50 LB.
12. DECEMBER	RYE RYE GRASS WHEAT	2-3 BU. 40-50 LB. 2-3 BU.	UNHULLED BERMUDA SERICEA LESPEDEZA FESCUE	8-10 LB. 30-40 LB. 30-50 LB.

USE A MINIMUM OF 40 LBS. SCARIFIED SEED. THE REMAINDER MAY BE UNSCARIFIED, CLEAN HULLED SEED.

DISTURBED AREA STABILIZATION (WITH TEMPORARY SEEDING)

DISTURBED AREA STABILIZATION (WITH PERMANENT VEGETATION)

#### GENERAL

THIS VEGETATIVE PLAN WILL BE CARRIED OUT ON ROAD CUT AND FILL SLOPES, SHOULDERS, AND OTHER CRITICAL AREAS CREATED BY CONSTRUCTION. SEEDING WILL BE DONE AS SOON AS CONSTRUCTION IN AN AREA IS COMPLETED. PLANTINGS WILL BE MADE TO CONTROL EROSION, TO REDUCE DAMAGE FROM SEDIMENT AND RUNOFF TO DOWNSTREAM AREAS AND TO IMPROVE THE SAFETY AND BEAUTY OF THE DEVELOPMENT AREA.

#### SOIL CONDITIONS

DUE TO GRADING AND CONSTRUCTION, THE AREAS TO BE TREATED ARE MAINLY SUBSOIL AND SUBSTRATES. FERTILITY IS LOW AND THE PHYSICAL CHARACTERISTICS OF THE EXPOSED MATERIAL ARE UNFAVORABLE TO ALL BUT THE MOST HARDY PLANTS.

#### TREATMENT SPECIFICATIONS

HYDRAULIC SEEDING EQUIPMENT: WHEN HYDRAULIC SEEDING AND FERTILIZING EQUIPMENT IS USED, NO GRADING AND SHAPING OR SEEDBED PREPARATION WILL BE REQUIRED. THE FERTILIZER, SEED AND WOOD CELLULOSE FIBER MULCH WILL BE MIXED WITH WATER AND APPLIED IN A SLURRY. ALL SLURRY INGREDIENTS MUST BE COMBINED TO FORM A HOMOGENOUS MIXTURE, AND SPREAD UNIFORMLY OVER THE AREA WITHIN ONE HOUR AFTER MIXTURE IS MADE. STRAW OR HAY MULCH AND ASPHALT EMULSION WILL BE APPLIED WITH BLOWER-TYPE MULCH SPREADING EQUIPMENT WITHIN 24 HOURS AFTER SEEDING. THE MULCH WILL BE SPREAD UNIFORMLY OVER THE AREA, LEAVING ABOUT 25 PERCENT OF THE GROUND SURFACE EXPOSED. THE PER ACRE APPLICATION RATES ARE AS FOLLOWS:

A. SEEDING WITH MULCH: (HYDRAULIC SEEDING EQUIPMENT ON SLOPES 3:1 AND STEEPER)

AGRICULTURAL LIMESTONE #75	4000 LBS./ACRI
FERTILIZER, 5-10-15	1500 LBS./ACRI
MULCH (STRAW OR HAY) OR	5000 LBS./ACRI
MULCH (STRAW OR HAY) OR	5000 LBS./ACRI
WOOD CELLULOSE FIBER MULCH	1000 LBS./ACRI

SEED Species	APPLICATION RATE/ACRE	Planting Dates
SERICEA LESPEDEZA, SCARIFIED	60 LBS.	
WEEPING LOVE GRASS, OR	4 LBS.	3/1 - 6/15
COMMON BERMUDA, HULLED	6 LBS.	-,,
FESCUE	40 LBS.	
SERICEA LESPEDEZA, UNSCARIFIED	60 LBS.	9/1 - 10/31
FESCUE	40 LBS.	
SERICEA LESPEDEZA, UNSCARIFIED	75 LBS.	11/1 - 2/28
RYE	50 LB\$.	,
HAY MULCH FOR TEMPORARY COVER	5000 LBS.	6/15-8/31

B. TOP DRESSING; APPLY WHEN PLANTS ARE 2 TO 4 INCHES TALL

FERTILIZER (AMMONIUM NITRATE 33.5%) 300 LBS./ACRE

C. SECOND-YEAR TREATMENT:

FERTILIZER (0-20-20 OR EQUIVALENT) 500 LBS./ACRÉ

#### GENERAL

THIS VEGETATIVE PLAN WILL BE CARRIED OUT ON ROAD CUT AND FILL SLOPES, SHOULDERS, AND OTHER CRITICAL AREAS CREATED BY CONSTRUCTION. SEEDING WILL BE DONE AS SOON AS CONSTRUCTION IN AN AREA IS COMPLETED. PLANTINGS WILL BE MADE TO CONTROL EROSION, TO REDUCE DAMAGE FROM SEDIMENT AND RUNOFF TO DOWNSTREAM AREAS AND TO IMPROVE THE SAFETY AND BEAUTY OF THE DEVELOPMENT AREA.

#### SOIL CONDITIONS

DUE TO GRADING AND CONSTRUCTION, THE AREAS TO BE TREATED ARE MAINLY SUBSOIL AND SUBSTRATES. FERTILITY IS LOW AND THE PHYSICAL CHARACTERISTICS OF THE EXPOSED MATERIAL ARE UNFAVORABLE TO ALL BUT THE MOST HARDY PLANTS.

#### TREATMENT SPECIFICATIONS

CONVENTIONAL SEEDING EQUIPMENT: GRADE, SHAPE, AND SMOOTH WHERE NEEDED TO PROVIDE FOR SAFE EQUIPMENT OPERATION AT SEEDING TIME AND FOR MAINTENANCE PURPOSES. THE LIME AND FERTILIZER IN DRY FORM WILL BE SPREAD UNIFORMLY OVER THE AREA IMMEDIATELY BEFORE SEEDBED PREPARATION. A SEEDBED WILL BE PREPARED BY SCARIFYING TO A DEPTH OF 1 TO 4 INCHES AS DETERMINED ON SITE. THE SEEDBED MUST BE WELL PULVERIZED, SMOOTHED, AND FIRMED. SEEDING WILL BE DONE WITH A CULTIPACKER-SEEDER, DRILL. ROTARY SEEDER, OR OTHER MECHANICAL OR HAND SEEDER. SEED WILL BE DISTRIBUTED UNIFORMLY OVER A FRESHLY PREPARED SEEDBED AND COVERED LIGHTLY. WITHIN 24 HOURS AFTER SEEDING, STRAW OR HAY MULCH WILL BE SPREAD UNIFORMLY OVER THE AREA, LEAVING ABOUT 25 PERCENT OF THE GROUND SURFACE EXPOSED. MULCH WILL BE SPREAD WITH BLOWER-TYPE MULCH EQUIPMENT OR BY HAND AND ANCHORED IMMEDIATELY AFTER IT IS SPREAD. A DISK HARROW WITH THE DISK SET STRAIGHT OR A SPECIAL PACKER DISK MAY BE USED TO PRESS THE MULCH INTO THE SOIL. THE PER ACRE APPLICATION RATES ARE AS FOLLOWS:

A. SEEDING WITH MULCH: (CONVENTIONAL SEEDING EQUIPMENT ON SLOPES LESS THAN 3:1)

AGRICULTURAL LIMESTONE #75 4000 LBS./ACRE FERTILIZER, 5-10-15 1500 LBS./ACRE MULCH (STRAW OR HAY) 5000 LBS./ACRE

SEED SPECIES	APPLICATION RATE/ACRE	PLANTING DATES
HULLED COMMON BERMUDA GRASS	10 LBS.	3/1 - 6/15
FESCUE	50 LBS.	9/1 - 10/31
FESCUE RYE GRASS	50 LBS. 50 LBS.	11/1 - 2/28
HAY MULCH FOR TEMPORARY COVER	5000 LBS.	6/15 - 8/31

B. TOP DRESSING: APPLY WHEN PLANTS ARE 2 TO 4 INCHES TALL

FERTILIZER (AMMONIUM NITRATE 33.5%)

300 LBS./ACRE

C. SECOND-YEAR TREATMENT:

FERTILIZER (5-10-15 OR EQUIVALENT)

800 LBS./ACRE

DISTURBED AREA STABILIZATION (WITH TEMPORARY SEEDING)

DISTURBED AREA STABILIZATION (WITH PERMANENT VEGETATION)

## verizon



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DRAWN: JY
CHECKED: PWM

.108 #: 20_V3N-028


GRADING, SEDIMENT & EROSION CONTROL NOTES

² USE EITHER COMMON SERALA OR INTERSTATE SERICEA LESPEDEZA.

### LEGEND


- 1 PRIMARY CABINET
- 2) BATTERY CABINET
- ③ GROWTH CABINET
- ④ OVP (PROPOSED AND FUTURE AS NEEDED)
- (5) (RESERVE SPACE FOR FUTURE GROUND RADIOS)
- (6) ILC CABINET
- DARK FIBER JUNCTION BOX
   (RESERVE SPACE FOR CHARLES TELCO
   CABINET IF NECESSARY)
- 8 RESERVE PLACE FOR CHARLES TELCO
- 9 DIESEL GENERATOR
- 10 TOWER LIGHT CONTROLLER BOX

		UNDERGROUND CONDUIT S			
NO.	O. SIZE FROM		TO	FOR	
Α	4"	METER / DISCONNECT	ILC	POWER	
В	1 1/2"	ILC	GENERATOR MAIN SWITCH	POWER	
С	1"	ILC	GENERATOR	POWER, HEATER & BATT	
D	1"	ILC	GENERATOR	CONTROL / ALARMS	
E	1"	ILC	PRIMARY CABINET	GEN. ILC ALARMS	
F	1"	ILC	GFCI / LIGHT	POWER	
G	4"	TELCO FIBER PROVIDER	TELCO DEMARC BOX	TELCO	
H	2"	TELCO BOX	EQUIPMENT CABINETS	TELCO	
	N/A	N/A	N/A	N/A	
J	N/A	N/A	N/A	N/A	
K	N/A	N/A	N/A	N/A	
L	2"	OVP	PRIMARY CABINET	POWER	
M	1-1/2	OVP	PRIMARY CABINET	TELCO	
N	3/4"	TOWER LIGHT CONTROL BOX	TOWER	TOWER LIGHTS	
0	3/4"	TOWER LIGHT CONTROL BOX	TELCO DEMARK	ALARMS	
Р	Τ"	ILC	TOWER LIGHT CONTROL BOX	POWER	

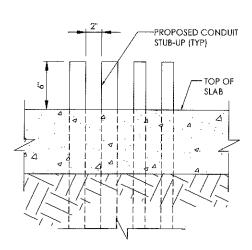

CONDUIT STUB-UP DETAIL

NTS

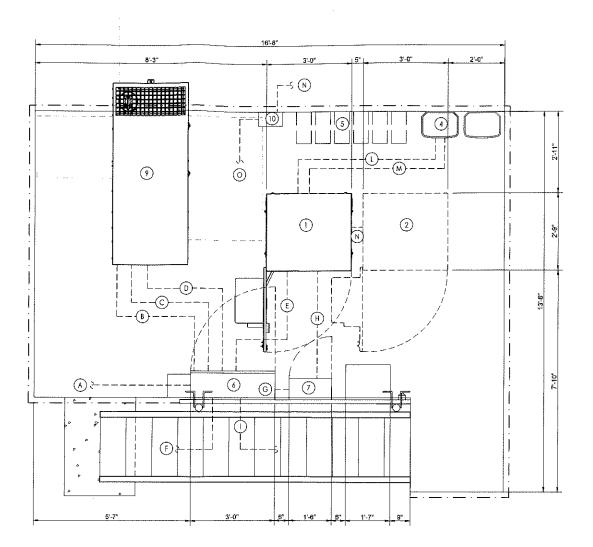

EQUIPMENT LAYOUT & CONDUIT STUB-UP PLAN

NTS

## verizon



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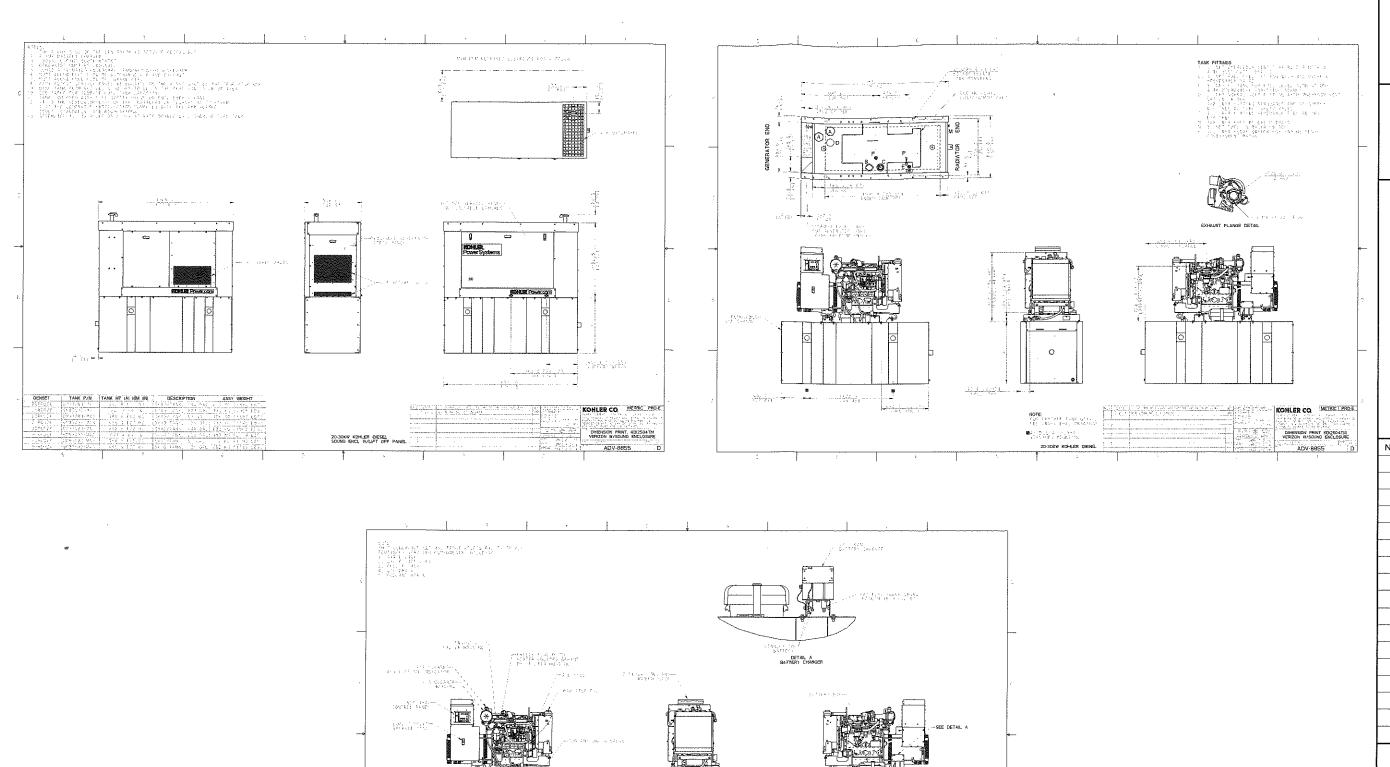
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DESIGNED: AA
DRAWN: JY
CHECKED: PWM

JOB#: 20_V3N-028

EQUIPMENT LAYOUT & CONDUIT STUB-UP PLAN



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KOHLER CO METRIC PROE

1.15 11. 14-2

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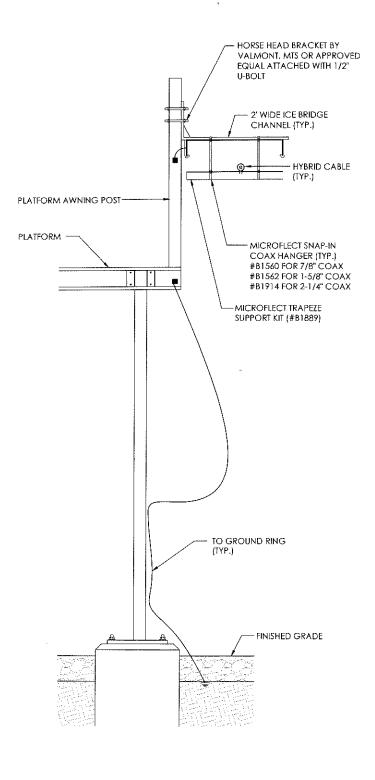


DESIGNED: AA DRAWN: JY CHECKED: PWM

> JOB#: 20_V3N-028

GENERATOR SPECIFICATIONS

# (1) PROPOSED HYBRID FIBER / DC-CABLES ROUTED UP MONOPOLE TOWER (P) MONOPOLE TOWER— - 2' WIDE ICE BRIDGE CHANNEL (TYP.) PROPOSED VERIZON — ICE BRIDGE PROPOSED EQUIPMENT CABINET ----- HYBRID CABLES (TYP.) ---- MINIMUM 2' BEND RADIUS FOR HYBRID CABLE - PROPOSED --- ICE BRIDGE POST FINISH GRADE



ICE BRIDGE SECTION NOT TO SCALE

verizon



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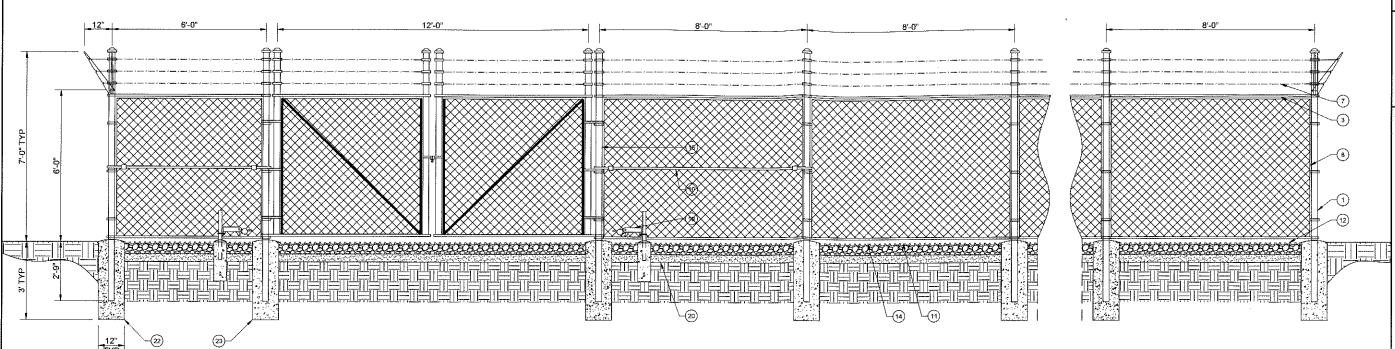
DESIGNED: AA DRAWN: JY CHECKED: PWM

> JOB#: 20_V3N-028

ICE BRIDGE DETAILS

C-11

ICE BRIDGE ELEVATION DETAILS
NOT TO SCALE



#### REFERENCE NOTES:

- CORNER, END OR PULL POST 3" NOMINAL SCHEDULE 40 PIPE.
- ② LINE POST: 2 1/2" SCHEDULE 40 PIPE, PER ASTM-F1083. LINE POSTS SHALL BE EQUALLY SPACED AT MAXIMUM 8'-0" O.C.
- 3 TOP RAIL & BRACE RAIL: 1 1/2" PIPE, PER ASTM-F1083.
- (4) FABRIC: 9 GA CORE WIRE SIZE 2" MESH, CONFORMING TO ASTM-A392.
- TIE WIRE: MINIMUM 11 GA GALVANIZED STEEL AT POSTS AND RAILS

  3 A SINGLE WRAP OF FABRIC TIE AND AT TENSION WIRE BY HOG RINGS SPACED MAX. 24" INTERVALS.
- (6) TENSION WIRE: 9 GA, GALVANIZED STEEL.
- ② BARBED WIRE: DOUBLE STRAND 12-1/2" O.D. TWISTED WIRE TO MATCH WITH FABRIC 14 GA. 4 PT. BARBS SPACED ON APPROXIMATELY 5" CENTERS.
- STRETCHER BAR.
- 3/8" DIAGONAL ROD WITH GALVANIZED STEEL TURNBUCKLE
   OR DIAGONAL THREADED ROD.
- FENCE CORNER POST BRACE: 1 5/8" DIA. EACH CORNER EACH WAY.
- 1 1/2" MAXIMUM CLEARANCE FROM GRADE.

- 2" FINISH OR AS DETERMINED BY CONSTRUCTION MANAGER DURING BID WALK.
- 4" COMPACTED 95% BASE MATERIAL OR AS DETERMINED BY CONSTRUCTION MANAGER DURING BID WALK.
- (4) FINISH GRADE SHALL BE UNIFORM AND LEVEL.
- GATE POST 4". SCHEDULE 40 PIPE, FOR GATE

  WIDTHS UP THRU 7 FEET OR 14 FEET FOR
  DOUBLE SWING GATE, PER ASTM-F1083.
- (6) GATE FRAME: 1 1/2" PIPE, PER ASTM-F1083.
- (7) GATE FRAME; 1 5/8" DIAMETER PIPE, PER ASTM-F1083
- (B) GATE DIAGONAL GALVANIZED STEEL 1 1/2" PIPE.
- ① DUCK BILL OPEN GATE HOLDER. VERIFY LOCATION IN FIELD PRIOR TO INSTALLATION.
- ② GEOTEXTILE FABRIC
- LINE POST: CONCRETE FOUNDATION (2000 PSI)
- @ CORNER POST: CONCRETE FOUNDATION (2000 PSI)
- GATE POST: CONCRETE FOUNDATION (2000 PSI)

#### **GENERAL NOTES:**

- 1. INSTALL FENCING PER ASTM F-567
- 2. INSTALL SWING GATES PER ASTM F-900
- LOCAL ORDINANCE OF BARBED WIRE PERMIT REQUIREMENT SHALL BE COMPLIED IF REQUIRED.
- 4. POST & GATE PIPE SIZES ARE INDUSTRY STANDARDS.
  ALL PIPE TO BE 1 1/2" GALV.
  [HOT DIP, ASTM A 120 GRADE "A" STEEL).
  ALL GATE FRAMES SHALL BE WELDED.
  ALL WELDING SHALL BE COATED WITH (3) COATS
  OF COLD GALV. [OR EQUAL].
- 5. ALL OPEN POSTS SHALL HAVE END-CAPS.
- 6. USE GALVANIZED HOG-RING WIRE TO MOUNT ALL SIGNS.
- 7. ALL SIGNS MUST BE MOUNTED ON INSIDE OF FENCE FABRIC.

## verizon



## **RIVERVIEW**

3451 SMITHS FISH CAMP PENSACOLA, FL 32514

LOCATION CODE:

508429

DATE			
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10/30/20	ZONI	NG DRAWINGS	DA
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DESIGNED: AA DRAWN: JY CHECKED: PWM

> JOB#: 20_V3N-028

FENCE DETAILS