



GENERAL NOTES

- 1. THE PROJECT ENGINEER (ENGINEER OF RECORD) SHALL PROVIDE TO ESCAMBIA COUNTY AS-BUILT RECORD DRAWINGS FOR VERIFICATION AND APPROVAL BY ESCAMBIA COUNTY ONE WEEK PRIOR TO REQUESTING A FINAL INSPECTION AND CERTIFICATE OF OCCUPANCY, OR PROVIDE AS-BUILT CERTIFICATION THAT THE PROJECT CONSTRUCTION ADHERES TO THE PERMITTED PLANS AND SPECIFICATIONS. THE AS-BUILT CERTIFICATION OR THE AS-BUILT RECORD DRAWINGS MUST BE SIGNED, SEALED AND DATED BY A REGISTERED FLORIDA PROFESSIONAL ENGINEER.
- 2. ALL ASPECTS OF THE STORMWATER/DRAINAGE COMPONENTS AND/OR TRANSPORTATION COMPONENTS SHALL BE COMPLETED PRIOR TO ISSUANCE OF A FINAL CERTIFICATE OF OCCUPANCY.
- 3. NO DEVIATIONS OR REVISIONS FROM THESE PLANS BY THE CONTRACTOR SHALL BE ALLOWED WITHOUT PRIOR APPROVAL FROM BOTH THE DESIGN ENGINEER AND THE ESCAMBIA COUNTY. ANY DEVIATIONS MAY RESULT IN DELAYS IN OBTAINING A CERTIFICATE OF OCCUPANCY.
- 4. THE CONTRACTOR SHALL INSTALL PRIOR TO THE START OF CONSTRUCTION AND MAINTAIN DURING CONSTRUCTION ALL SEDIMENT CONTROL MEASURES AS REQUIRED TO RETAIN ALL SEDIMENTS ON THE SITE. IMPROPER SEDIMENT CONTROL MEASURES MAY RESULT IN CODE ENFORCEMENT VIOLATION.
- 5. RETENTION/DETENTION AREAS SHALL BE SUBSTANTIALLY COMPLETE PRIOR TO ANY CONSTRUCTION ACTIVITIES THAT MAY INCREASE STORMWATER RUNOFF RATES. THE CONTRACTOR SHALL CONTROL STORMWATER DURING ALL PHASES OF CONSTRUCTION AND TAKE ADEQUATE MEASURES TO PREVENT THE EXCAVATED POND FROM BLINDING DUE TO SEDIMENTS.
- 6. ALL DISTURBED AREAS WHICH ARE NOT PAVED SHALL BE STABILIZED WITH SEEDING, FERTILIZER AND MULCH, HYDROSEED
- 7. ALL NEW BUILDING ROOF DRAINS, DOWN SPOUTS, OR GUTTERS SHALL BE ROUTED TO CARRY ALL STORMWATER TO
- RETENTION/DETENTION AREAS.
- 8. DEVELOPER/CONTRACTOR SHALL RESHAPE PER PLAN SPECIFICATIONS, CLEAN OUT ACCUMULATED SILT, AND STABILIZE RETENTION/DETENTION POND(S) AT THE END OF CONSTRUCTION WHEN ALL DISTURBED AREAS HAVE BEEN STABILIZED AND PRIOR TO REQUEST FOR INSPECTION.

GL GUTTER LINE

- 9. CONTRACTOR SHALL MAINTAIN RECORD DRAWINGS DURING CONSTRUCTION WHICH SHOW AS-BUILT CONDITIONS OF ALL WORK INCLUDING PIPING, DRAINAGE STRUCTURES, TOPO OF POND(S), OUTLET STRUCTURES, DIMENSIONS, ELEVATIONS, GRADING ETC. RECORD DRAWINGS SHALL BE PROVIDED TO THE ENGINEER OF RECORD PRIOR TO REQUESTING FINAL
- 10. THE OWNER OR HIS AGENT SHALL ARRANGE/SCHEDULE WITH THE COUNTY A FINAL INSPECTION OF THE DEVELOPMENT UPON COMPLETION AND ANY INTERMEDIATE INSPECTIONS AT (850) 595-3472. AS-BUILT CERTIFICATION IS REQUIRED PRIOR TO REQUEST FOR FINAL INSPECTION/APPROVAL.
- 11. CONTRACTOR SHALL OBTAIN BUILDING INSPECTION DEPARTMENT PERMIT(S) FOR ANY RETAINING WALL HIGHER THAN 2
- 12. NOTIFY SUNSHINE UTILITIES 48 HOURS IN ADVANCE PRIOR TO DIGGING WITHIN R/W; 1-800-432-4770.
- 13. ANY DAMAGE TO EXISTING ROADS DURING CONSTRUCTION WILL BE REPAIRED BY THE DEVELOPER PRIOR TO FINAL AS-BUILT" SIGN OFF FROM THE COUNTY."
- 14. THE CONTRACTOR SHALL NOTIFY FDOT 48 HOURS IN ADVANCE PRIOR TO INITIATING ANY WORK IN THE STATE
- 15. FDOT WILL REVIEW ALL LANE/SIDEWALK CLOSURE, DETOUR, AND LANE SHIFT REQUESTS SEPARATELY FROM THE PERMIT PROCESS. FDOT APPROVAL IS REQUIRED BEFORE COMMENCEMENT OF WORK INVOLVING THE CLOSURE, DETOUR, OR LANE SHIFT FOR WORK ALONG THE STATE HIGHWAY SYSTEM.

REBAR REINFORCING BAR

TRANS TRANSFORMER

TIMON	TOTILGOLOTTOTAL	
CIVIL PLAN	ABBREVIATIONS:	

CIPC CAST IN PLACE CONCRETE ELEV ELEVATION

_	CIVIL	L FLAN ADDITE	17 1 1 1		FOF	EMERGENCY OVERFLOW	GPM	GALLONS PER MINUTE	J-BOX	JUNCTION BOX	OC	ON CENTER		REINI ORCING BAR	T\/	TELEVISION
	AC	ACRE	CJ	CONTROL JOINT	EUF		GV	GATE VALVE	JT	JOINT	OCEW	ON CENTER EACH WAY	REM	REMOVE	T // A/	
	ADA	AMERICANS WITH DISABILITIES ACT	CL	CENTERLINE	EQ	EQUAL		HIGH DENSITY POLYETHYLENE	LF	LINEAR FEET	OH	OVERHEAD	ROW	RIGHT OF WAY	T/W	TOP OF WALL
		ADDENDUM	CMP	CORRUGATED METAL PIPE	EX	EXISTING			LIN	LINEAR	OHD	OVERHEAD DOOR	R/W	RIGHT OF WAY	TYP	TYPICAL
		ABOVE FINISHED FLOOR	CO	CLEANOUT	FDC	FIRE DEPARTMENT CONNECTION	HD	HEAVY DUTY		LOW PRESSURE STEAM	OZ	OUNCE	SAN	SANITARY	LIT	UTILITY, UNDERGROUND
		AGGREGATE		CONCRETE	FDN	FOUNDATION	HH	HANDHOLE	LPS			PEDESTAL, PEDESTRIAN	SCH	SCHEDULE	UI	TELEPHONE
					FFE	FINISHED FLOOR ELEVATION	HORIZ	HORIZONTAL	LS	LUMP SUM			SE	SQUARE FOOT	VCP	VITRIFIED CLAY PIPE
		APPROXIMATE		CONTINUOUS	FPM	FEET PER MINUTE	HR	HOUR	LSO	LOWEST STRUCTURAL OPENING		PERFORATED	SPEC	SPECIFICATION	W/O	WITHOUT
		ARCHITECT, ARCHITECTURAL	CONT	* * * * * * * * * * * * * * * * * * * *		FEET PER SECOND	HWL	HIGH WATER LEVEL	MAX	MAXIMUM	PL	PROPERTY LINE	SPEC		W/	WITH
	BFE	BASEMENT FLOOR ELEVATION	CY	CUBIC YARD		FOOT, FEET	HWY	HIGHWAY	MB	MAIL BOX	PP	POLYPROPYLENE	SQ	SQUARE	VD	YARD
	BIT	BITUMINOUS	C&G	CURB AND GUTTER	FT		HYD	HYDRANT	MECH	MECHANICAL	PSI	POUNDS PER SQUARE INCH	STA	STATION	YD	
	CAD	COMPUTER-AIDED DESIGN	DEMO	DEMOLITION	FTG	FOOTING	עוח		MH	MANHOLE	PVC	POLYVINYL CHLORIDE	SY	SQUARE YARD	YR	YEAR
		CATCH BASIN	DIA	DIAMETER	GA	GAUGE	1	INVERT	MIN	MINIMUM	PVMT	PAVEMENT	T/C	TOP OF CURB		
		CUBIC FEET PER SECOND	DIM	DIMENSION	GAL	GALLON	ID	INSIDE DIAMETER		MISCELLANEOUS	OTY	QUANTITY	TEL	TELEPHONE		
	CE	CUBIC FOOT	DS	DOWNSPOUT	GALV	GALVANIZED	IN	INCH	MISC		RAD	RADIUS	TEMP	TEMPORARY		
	Cr		ΕΛ	EACH	GC	GENERAL CONTRACTOR	INV	INVERT	NO	NUMBER		REINFORCED CONCRETE PIPE	THRU	THROUGH		
	CI	CAST IRON	LLC	ELECTRICAL	GFF	GARAGE FLOOR ELEVATION	IP	IRON PIPE	NTS	NOT TO SCALE	RCP		TNFH	TOP NUT OF FIRE HYDRANT		
	CIP	CAST IRON PIPE	ELEC	ELECTRICAL	CI	CHITTED LINE	IDC	IRON PIPE SIZE	NWL	NORMAL WATER LEVEL	RD	ROOF DRAIN	IINEL	TOP NOT OF TIME ITTO MANY		

IRON PIPE SIZE

IPS

PROJECT ADDRESS / LOCATION: **4830 MOBILE HIGHWAY**

S15, T2S, R30W PENSACOLA, FLORIDA **ESCAMBI COUNTY**

S	ITE SUM	MARY					
ZONING:	COMMERCIAL, HEAV (FLU - COMMERCIAL	/Y COMMERCIAL, & LI .)	GHT INDUSTRIAL				
SITE/LOT AREA:	93,748 SF / 2.15 AC.	93,748 SF / 2.15 AC.					
IMPERVIOUS AREA:	66,006 SQ. FT / 1.515	5 AC. (70%)					
GREENSPACE PROVIDED:	27,742 SQ. FT / 0.63	7 AC. (30%)					
PARKING RE							
TYPE	UNIT / AREA	STALLS REQUIRED	STALLS PROVIDE				
9'x18"	4 / 1,000 SF	77	90				
ADA ACCESIBLE		4	4				
	TOTAL:	81	94				
	SETBA	CKS					
	SETBA	CKS PARKING	BUILDING				
FRONT YARD	SETBA		BUILDING 15				
FRONT YARD SIDE YARD	SETBA						

PROJECT GENERAL NOTES

- ALL WORK SHALL CONFORM TO THE CONTRACT DOCUMENTS, WHICH INCLUDE, BUT ARE NOT LIMITED TO, THE OWNER - CONTRACTOR AGREEMENT, THE PROJECT MANUAL (WHICH INCLUDES GENERAL SUPPLEMENTARY CONDITIONS AND SPECIFICATIONS), DRAWINGS OF ALL DISCIPLINES AND ALL ADDENDA, MODIFICATIONS AND CLARIFICATIONS ISSUED BY THE ARCHITECT/ENGINEER.
- 2. CONTRACT DOCUMENTS SHALL BE ISSUED TO ALL SUBCONTRACTORS BY THE GENERAL CONTRACTOR IN COMPLETE SETS IN ORDER TO ACHIEVE THE FULL EXTENT AND
- 3. WRITTEN DIMENSIONS TAKE PRECEDENCE OVER SCALED DIMENSIONS. NOTIFY ARCHITECT/ENGINEER OF ANY DISCREPANCIES OR CONDITIONS REQUIRING INFORMATION OR CLARIFICATION BEFORE PROCEEDING WITH THE WORK.
- 4. FIELD VERIFY ALL EXISTING CONDITIONS AND DIMENSIONS. NOTIFY ARCHITECT/ENGINEER OF ANY DISCREPANCIES OR CONDITIONS REQUIRING INFORMATION OR CLARIFICATION BEFORE PROCEEDING WITH THE WORK.
- DETAILS SHOWN ARE INTENDED TO BE INDICATIVE OF THE PROFILES AND TYPE OF DETAILING REQUIRED THROUGHOUT THE WORK. DETAILS NOT SHOWN ARE SIMILAR IN CHARACTER TO DETAILS SHOWN. WHERE SPECIFIC DIMENSIONS, DETAILS OR DESIGN INTENT CANNOT BE DETERMINED, NOTIFY ARCHITECT/ENGINEER BEFORE PROCEEDING WITH THE WORK.
- 6. ALL MANUFACTURED ARTICLES, MATERIALS AND EQUIPMENT SHALL BE APPLIED, INSTALLED, CONNECTED, ERECTED, CLEANED AND CONDITIONED ACCORDING TO MANUFACTURERS' INSTRUCTIONS. IN CASE OF DISCREPANCIES BETWEEN MANUFACTURERS' INSTRUCTIONS AND THE CONTRACT DOCUMENTS, NOTIFY ARCHITECT/ENGINEER BEFORE PROCEEDING WITH THE WORK.
- 7. ALL DISSIMILAR METALS SHALL BE EFFECTIVELY ISOLATED FROM EACH OTHER TO AVOID GALVANIC CORROSION.
- 8. THE LOCATION AND TYPE OF ALL INPLACE UTILITIES SHOWN ON THE PLANS ARE FOR GENERAL INFORMATION ONLY AND ARE ACCURATE AND COMPLETE TO THE BEST OF THE KNOWLEDGE OF I & S GROUP, INC. (ISG). NO WARRANTY OR GUARANTEE IS IMPLIED. THE CONTRACTOR SHALL VERIFY THE SIZES, LOCATIONS AND ELEVATIONS OF ALL INPLACE UTILITIES PRIOR TO CONSTRUCTION. CONTRACTOR SHALL IMMEDIATELY NOTIFY ENGINEER OF ANY DISCREPANCIES OR VARIATIONS FROM PLAN.
- 9. THE CONTRACTOR IS TO CONTACT "SUNSHINE 811" FOR UTILITY LOCATIONS, MINIMUM 2 BUSINESS DAYS PRIOR TO ANY EXCAVATION / CONSTRUCTION (811 OR SUNSHINE811.COM).

SPECIFICATIONS REFERENCE

ALL CONSTRUCTION SHALL COMPLY WITH ESCAMBIA COUNTY REQUIREMENTS, ECUA, FLORIDA DESIGN MANUAL, AND FDOT 2021-22 STANDARD PLANS FOR CONSTRUCTION INDEX DETAILS.

PROJECT DATUM

HORIZONTAL COORDINATES HAVE BEEN REFERENCED TO THE NORTH AMERICAN DATUM OF 1983 (NAD83), 1996 ADJUSTMENT (NAD83(1996)) ON THE ESCAMBIA COUNTY COORDINATE SYSTEM, IN U.S. SURVEY FEET. ELEVATIONS HAVE BEEN REFERENCED TO THE NORTH AMERICAN VERTICAL DATUM OF 1988 (NAVD 88).

TOPOGRAPHIC SURVEY

THIS PROJECT'S TOPOGRAPHIC SURVEY CONSISTS OF DATA COLLECTED IN 2021 BY BUTLER AND ASSOCIATES.

FLOODPLAIN MANAGEMENT

THE SUBJECT PROPERTY AS SHOWN HEREON IS LOCATED IN FLOOD ZONE X, (MINIMAL RISK AREAS OUTSIDE THE 1-PERCENT AND .2-PERCENT-ANNUAL-CHANCE FLOODPLAINS. NO BFES OR BASE FLOOD DEPTHS ARE SHOWN WITHIN THESE ZONES), AS DETERMINED FROM THE FEDERAL EMERGENCY MANAGEMENT AGENCY FLOOD INSURANCE RATE MAP OF ESCAMBIA COUNTY, FLORIDA, COMMUNITY 120080, FIRM MAP PANEL NUMBERS 12033C0360G, MAP REVISION DATED SEPTEMBER 29, 2006.

LEGEND

____ SECTION LINE _____ QUARTER SECTION LINE _____ RIGHT OF WAY LINE _____ EASEMENT LINE _____ ACCESS CONTROL _____ _ _ _ _ _ W _ _ _ WATER EDGE _ _ WET _ _ WETLAND BOUNDARY METLAND / MARSH ___x___x___x FENCE LINE >--- << --- CULVERT _____ _ _ << __ _ _ STORM SEWER _____ _ _ < __ _ _ SANITARY SEWER _____ _ _ < II _ _ _ SANITARY SEWER FORCEMAIN _____ WATER _____ GAS _____ OE ___ OE ___ OVERHEAD ELECTRIC _____ UNDERGROUND ELECTRIC _____ UT __ UT __ UNDERGROUND TELEPHONE _____ _ _ _ UTV _ _ _ UNDERGROUND TV ——— — OHL — — OVERHEAD UTILITY _____ _ _ UTL _ _ UNDERGROUND UTILITY _____ _ FBO — — UNDERGROUND FIBER OPTIC _____ 990 ---- CONTOUR (MAJOR) 989 — CONTOUR (MINOR) **DECIDUOUS TREE CONIFEROUS TREE** TREE LINE MANHOLE/STRUCTURE **CATCH BASIN HYDRANT** VALVE **CURB STOP** POWER POLE UTILITY PEDESTAL / CABINET

	LOT LINE
	RIGHT OF WAY
	EASEMENT
<<	CULVERT
	STORM SEWER
	STORM SEWER (PIPE WIDTH)
<	SANITARY SEWER
	SANITARY SEWER (PIPE WIDTH)
	WATER
G	GAS
OE	OVERHEAD ELECTRIC
UE	UNDERGROUND ELECTRIC
UTV	UNDERGROUND TV
1015	CONTOUR
	MANHOLE
	CATCH BASIN

PROPOSED

CIVIL SHEET INDEX


C-010 SITE DATA C-020 SITE DETAILS C-021 SITE DETAILS C-022 SITE DETAILS C-023 SITE DETAILS C-024 SITE DETAILS C-025 SITE DETAILS C-026 PYLON SIGN DETAIL C-110 SITE EROSION CONTROL PLAN C-120 SITE EROSION CONTROL DETAILS C-121 SITE EROSION CONTROL DETAILS C-122 SITE EROSION CONTROL NOTES C-210 EXISTING SITE & REMOVAL PLAN C-310 SITE PLAN C-320 SITE UTILITY PLAN C-410 SITE GRADING PLAN C-510 SITE RESTORATION & PLANTING PLAN

C-520 SITE PLANTING NOTES & DETAILS

C-610 SITE LIGHTING PHOTMETRIC PLAN

C-620 SIGHT LIGHTING CATALOGUE PAGES

Issued:	Date
SITE PLAN REVIEW #1	05/18/2
SITE PLAN REVIEW #2	06/24/2
PERMIT/BID SET	07/28/2
FOR CONSTRUCTION	09/10/2
Revisions:	Date
CCD #01	09/10/2

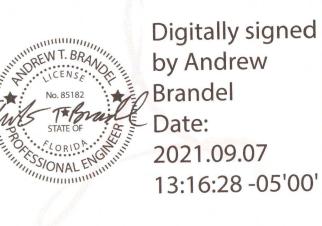

B.M. ELEVATION = 72.38'

CUT 'X' LOCATED IN SIDEWALK AT THE NE CORNER OF THE INTERSECTION OF MOBILE HWY AND EDISION DRIVE.



MANAGING LOCATION: MINNEAPOLIS / ST. PAUL OFFICE 7900 INTERNATIONAL DRIVE INTERNATIONAL PLAZA, SUITE 550 MINNEAPOLIS, MN 55425 PHONE: 952.426.0699



Store #: 156 PENSACOLA, FLORIDA 4830 MOBILE HIGHWAY PENSACOLA, FLORIDA 32506 ESCAMBIA COUNTY

SITE DATA

Project Name & Location:


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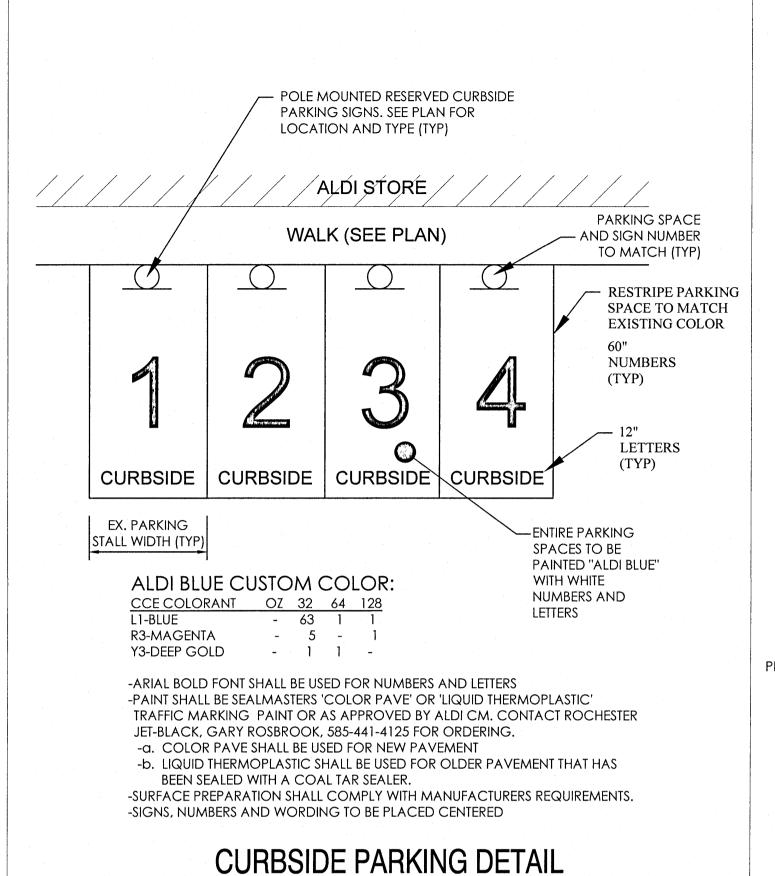
Drawn By:

JMF


Reviewed By: RJA | Drawing No.

Designed By: JMF



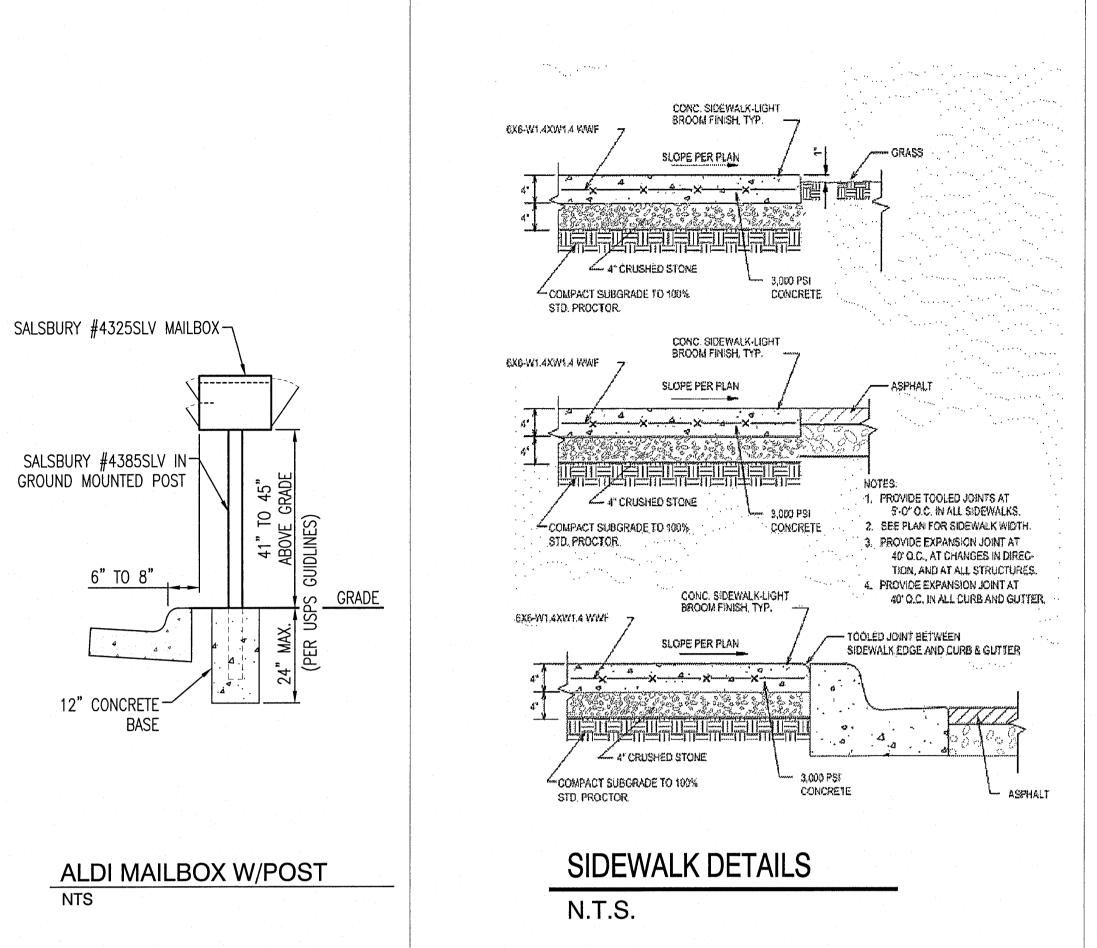

N.T.S.

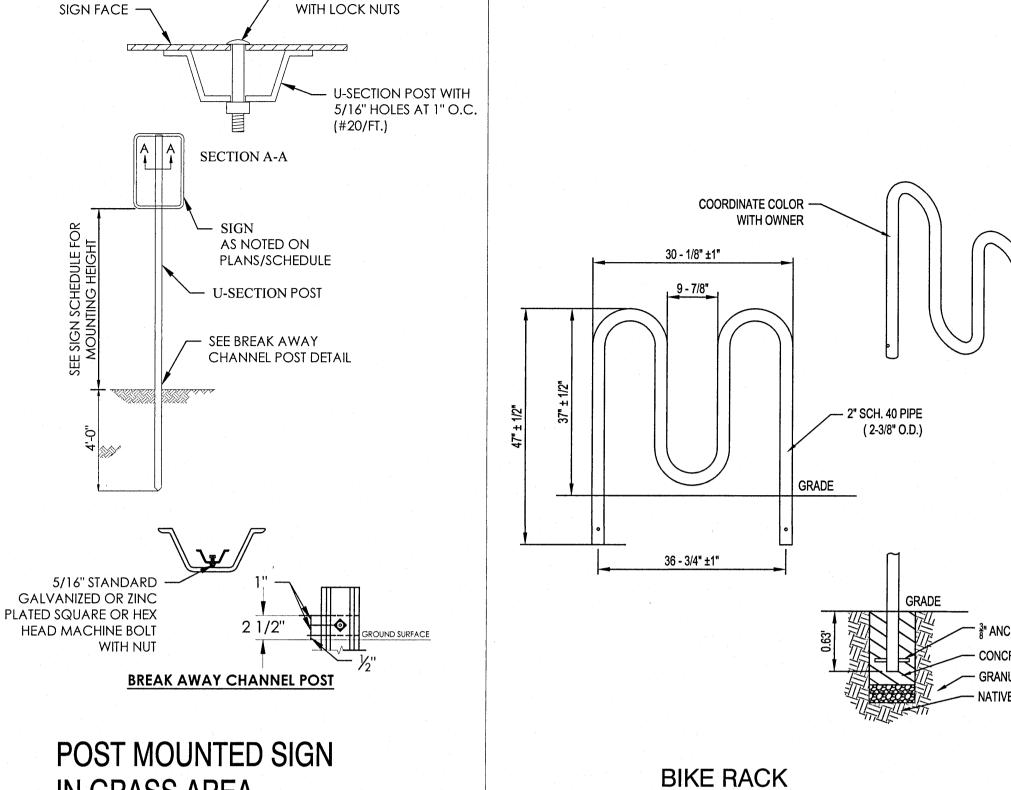


(3 LOOPS, 5 BIKES)

/ 1/4" ALUMINUM BOLTS

IN GRASS AREA

N.T.S.

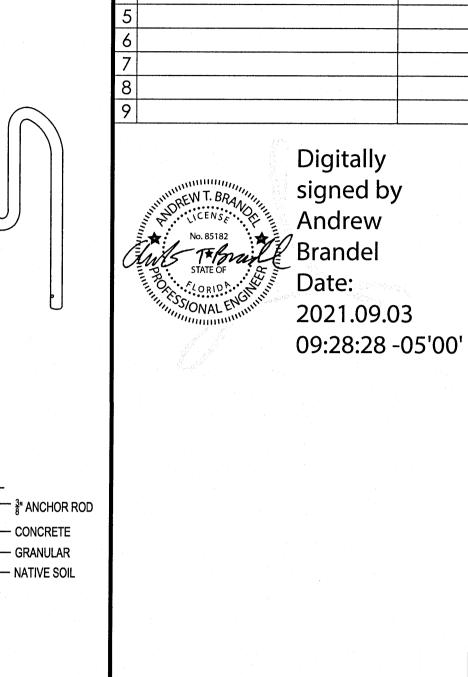

B.M. ELEVATION=72.38'

CUT 'X' LOCATED IN SIDEWALK AT THE NE CORNER OF THE INTERSECTION OF MOBILE HWY AND EDISION DRIVE.

MANAGING LOCATION:

Reviewed By: RJA

2080 ALDI Blvd Mt. Juliet, TN 37122 (615) 449-8840 (615) 443-8595 fax

Store #: 156

ISG Project No.

21-25050

C-020

Drawing No.

Issued:

SITE PLAN REVIEW #1

PERMIT/BID SET

Revisions:

SITE PLAN REVIEW #2

FOR CONSTRUCTION

Date:


05/18/21

06/24/21


07/28/21


09/10/21


Date:

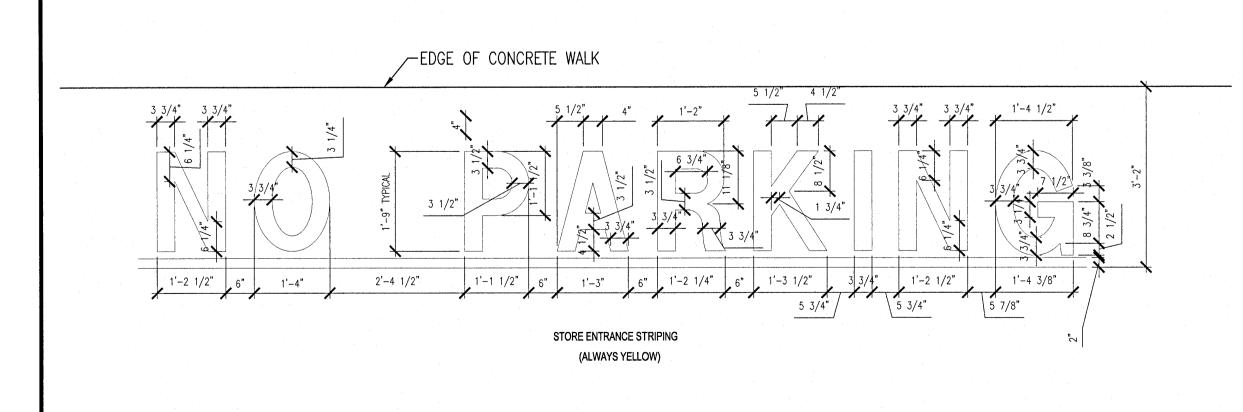

STORE ENTRANCE NO PARKING STRIPING DETAIL

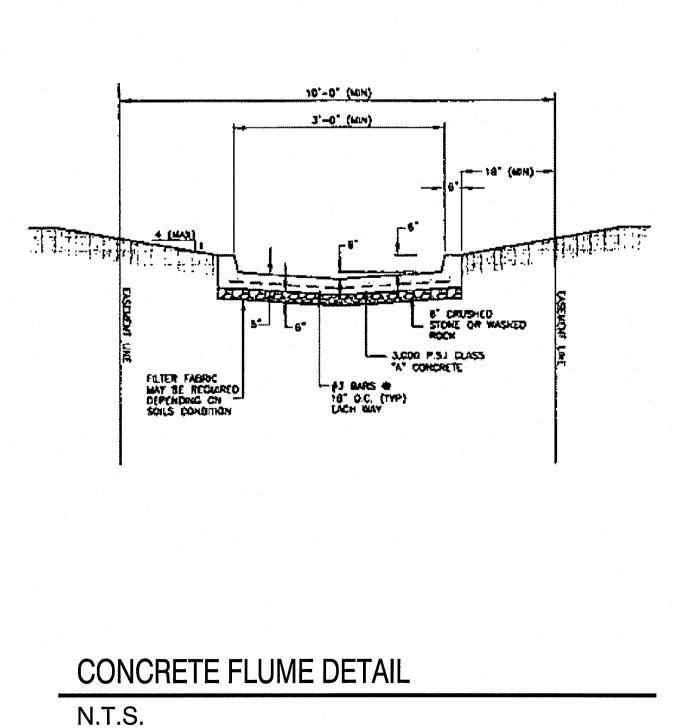

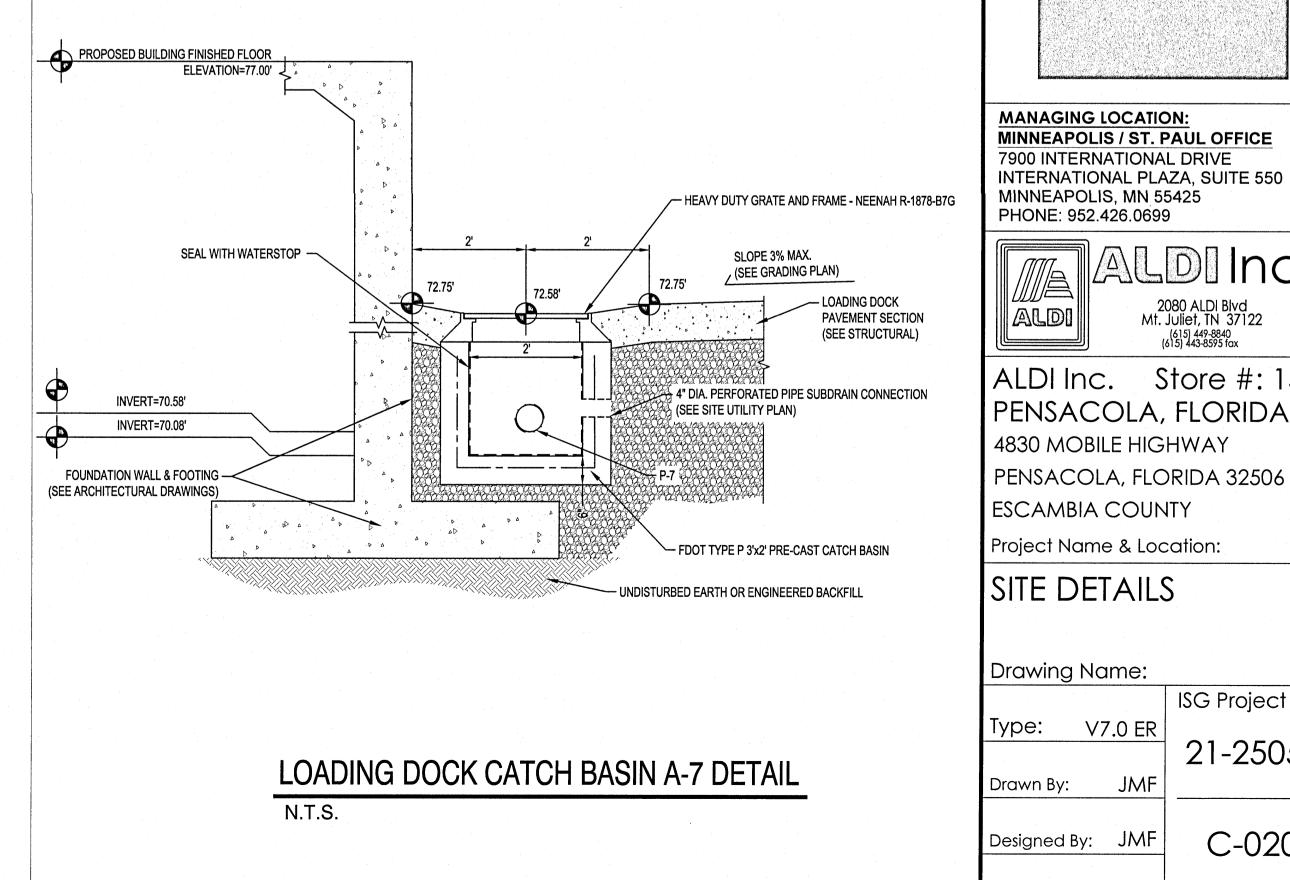

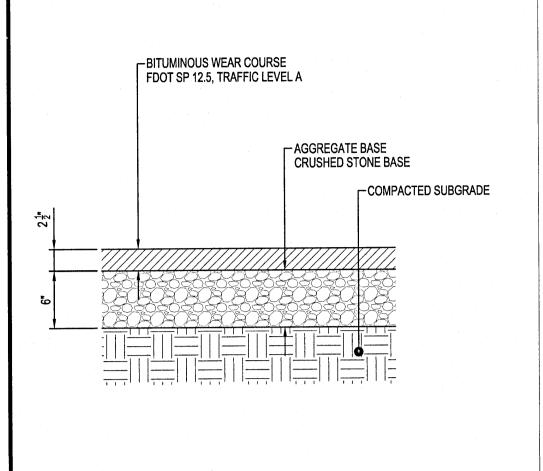

BITUMINOUS WEAR COURSE FDOT SP 12.5, TRAFFIC LEVEL A

AGGREGATE BASE CRUSHED STONE BASE

COMPACTED SUBGRADE

HEAVY DUTY

STANDARD
BITUMINOUS PAVEMENT
NTS ST110

HEAVY DUTY
BITUMINOUS PAVEMENT
NTS ST115

SP-1: DUPLEX GRINDER SUMP PUMP SYSTEM - (2) LIBERTY SUBMERSIBLE SINGLE STAGE GRINDER PUMPS MODEL LSG203M, EACH RATED AT 2 HP, 208/230V, 60 HZ., 3 PHASE, 10.6 FLA. AT 3450 RPM. EACH UNIT SHALL PRODUCE 40 GPM AT 64 FEET OF DYNAMIC HEAD. PUMPS SHALL INCLUDE 1½" DISCHARGE CONNECTION, NEMA-4X INDOOR DUPLEX CONTROL PANEL WITH FOUR FLOAT SWITCHES AND HIGH WATER ALARM AND WITH INTEGRAL OVERLOAD PROTECTION, STAINLESS STEEL GUIDE RAIL SYSTEM WITH QUICK DISCONNECTS AND PIPING TO INCLUDE AN INTERNAL BALL CHECK VALVE. DISCHARGE PIPING TO BE SCHEDULE 80 PVC AND FURNISHED WITH A PVC SHUT-OFF BALL VALVE. PUMPS SHALL BE OF CLASS 25 CAST IRON CONSTRUCTION WITH OIL FILLED MOTOR HOUSING, BUNA-N MOLDED DOUBLE LIP SEALS AND O-RINGS, CAST STAINLESS STEEL IMPELLER AND 440 STAINLESS STEEL ROTARY CUTTER AND PLATE WITH (4) BLADES, 25 FT. 3-PHASE SEOOW MULTICONDUCTOR CORD. PUMPS EXTERIOR CASTING SHALL BE PAINTED AND PROTECTED WITH

SUMP BASIN SHALL BE SUPPLIED BY G.C. AND SHALL BE 36 INCHES MINIMUM DIAMETER. DUPLEX PUMP CONTROL PANEL SHALL BE MOUNTED 48" MIN. ABOVE FINISHED FLOOR ON WALL NEAR SUMP.


DUPLEX ALTERNATING PUMP CONTROL PANEL WEIL MODEL 8158-T-063 WITH 8230 FLOATS OR APPROVED EQUAL, MOUNT ON WALL ADJACENT TO PUMP @ 4'-0" A.F.F., WITH (4) - SOLID C.I. MANHOLE COVER, SEALED AND GASKETED FLOATS (TETHERED), TYPE 1 ENCLOSURE, WITH RECESSED LIFTING HANDLES. TOP OF COVER TO ALARM HORN AND RED FLASHING LIGHT, BE FLUSH WITH FINISHED GRADE. LOCKABLE PANEL DISCONNECT, LIGHT INDICATORS FOR EACH PUMP, PUMP TROUBLE ALARM-INDICATOR, 3-POSITION T-O-A PUMP SWITCH FOR EACH PUMP, ELECTRIC ALTERNATOR, & PUMP MOTOR OVERLOAD, CIRCUIT PROTECTION. -1½" x 2" REDUCER FITTING. FIBERGLASS SUMP APPROVED EQUAL, BY G.C. - UNION 1½" SPRING LOADED FULL FLOW CHECK VALVE (TYP). — "HIGH LEVEL ALARM" FLOAT — 1 1/2" DISCHARGE PIPING - "LAG PUMP ON/STANDBY" FLOAT — "LEAD PUMP ON" FLOAT

CONSTRUCTION OF PIT SHALL MEET ALL LOCAL AND STATE CODES HAVING JURISDICTION, INCLUDING PUMP LIFT DEVICES WHERE REQUIRED FOR REMOVAL OF PUMP FOR MAINTENANCE OR REPLACEMENT.


SUMP PIT & PUMP A-5 DETAIL

N.T.S.

COMPACTED BASE -

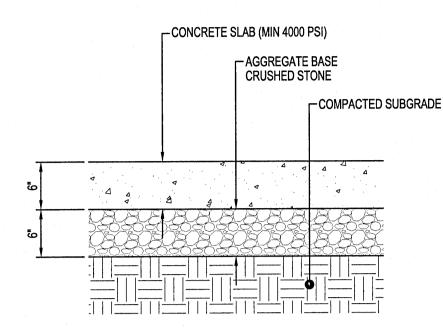


CONCRETE PAVEMENT

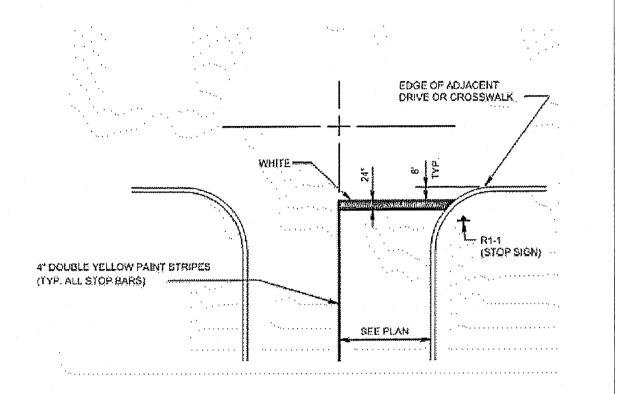


STOPE

STOP BAR LAYOUT DETAIL

N.T.S.

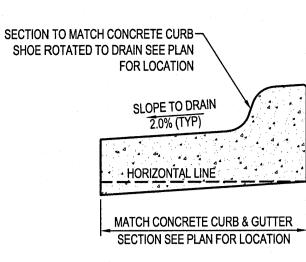

REVERSE PITCH
CONCRETE CURB & GUTTER
NTS ST250

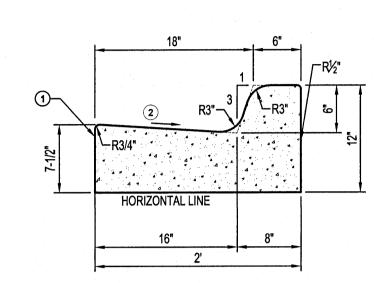

NOTES:

- ① LONGITUDINAL JOINT WHEN ADJACENT TO RIGID PAVEMENT OR BASE.
- SLOPE 0.06FT/FT NORMAL, UNLESS OTHERWISE SPECIFIED. IF A DIFFERENT GUTTER SLOPE IS PERMITTED, THE FORM MAY BE TILTED.

TYPE F
CONCRETE CURB & GUTTER

Issued:

A SITE PLAN REVIEW #1

B SITE PLAN REVIEW #2

C PERMIT/BID SET

FOR CONSTRUCTION


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Revisions:

Date:


Date:

Digitally signed

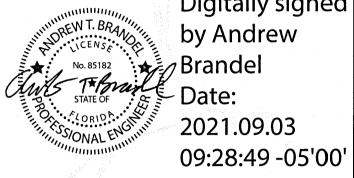

B.M. ELEVATION=72.38'

CUT 'X' LOCATED IN SIDEWALK AT THE NE CORNER OF THE INTERSECTION OF MOBILE HWY AND EDISION DRIVE.

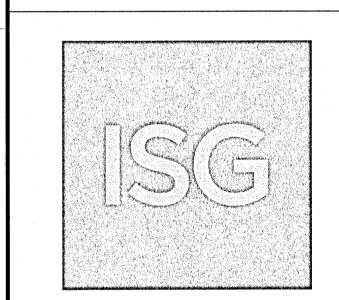

MANAGING LOCATION:
MINNEAPOLIS / ST. PAUL OFFICE
7900 INTERNATIONAL DRIVE
INTERNATIONAL PLAZA, SUITE 550
MINNEAPOLIS, MN 55425
PHONE: 952.426.0699



2080 ALDI BIVD Mt. Juliet, TN 37122 (615) 449-8840

ALDI Inc. Store #: 156
PENSACOLA, FLORIDA
4830 MOBILE HIGHWAY
PENSACOLA, FLORIDA 32506
ESCAMBIA COUNTY


Project Name & Location:

SITE DETAILS


Reviewed By: RJA | Drawing No.

GP-1: SIMPLEX GRINDER PUMP SYSTEM GP-1 SIMPLEX GRINDER SUMP PUMP SYSTEM - (1) LIBERTY SUBMERSIBLE SINGLE STAGE GRINDER PUMP MODEL 2460LSG202, RATED AT 2 HP, 208/230V,60 HZ., 1 PHASE, 15 FLA. AT 3450 RPM. EACH UNIT SHALL PRODUCE 40 GPM AT 64 FEET OF DYNAMIC HEAD. PUMPS SHALL INCLUDE 11 4" DISCHARGE CONNECTION, NEMA-4X INDOOR SIMPLEX CONTROL PANEL WITH THREE FLOAT SWITCHES AND HIGH WATER ALARM AND WITH INTEGRAL OVERLOAD PROTECTION, STAINLESS STEEL GUIDE RAIL SYSTEM WITH QUICK DISCONNECTS AND PIPING TO INCLUDE AN INTERNAL BALL CHECK VALVE. DISCHARGE PIPING TO BE SCHEDULE 80 PVC AND FURNISHED WITH A PVC SHUT-OFF BALL VALVE. PUMP SHALL BE OF CLASS 25 CAST IRON CONSTRUCTION WITH OIL FILLED MOTOR HOUSING, BUNA-N MOLDED DOUBLE LIP SEALS AND O-RINGS, CAST STAINLESS STEEL IMPELLER AND 440 STAINLESS STEEL ROTARY CUTTER AND PLATE WITH (4) BLADES, 25 FT. 1-PHASE SEOOW MULTICONDUCTOR CORD. PUMP EXTERIOR CASTING SHALL BE PAINTED AND PROTECTED WITH POWDER COAT PAINT.


SUMP BASIN SHALL BE SUPPLIED BY G.C. AND SHALL BE 26 INCHES MINIMUM DIAMETER. SIMPLEX PUMP CONTROL PANEL SHALL BE MOUNTED 48" MIN. ABOVE FINISHED FLOOR ON WALL NEAR BASIN.

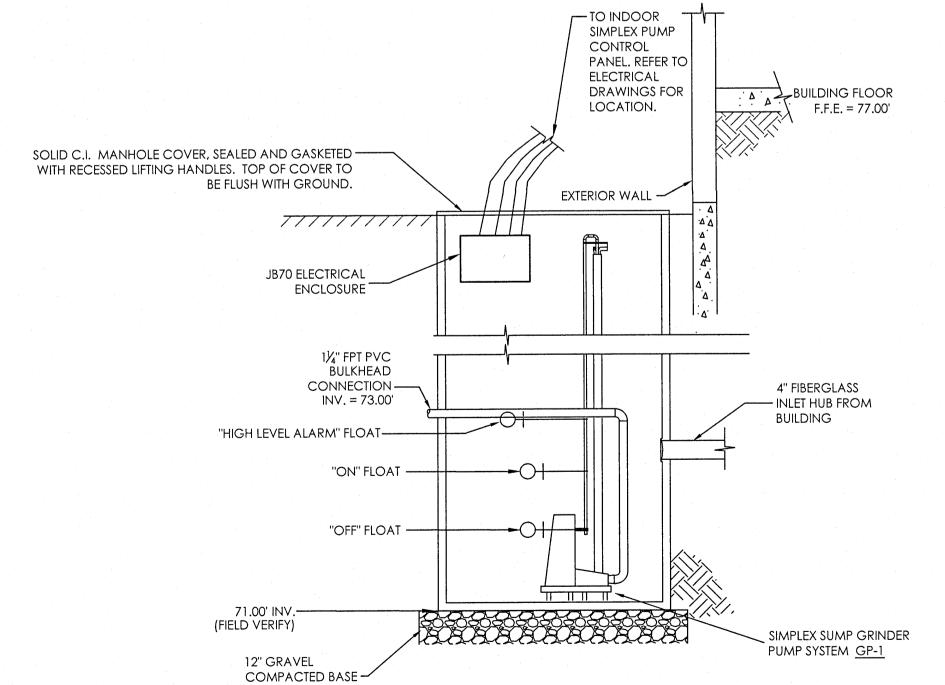

SANITARY SUMP PIT & PUMP DETAIL

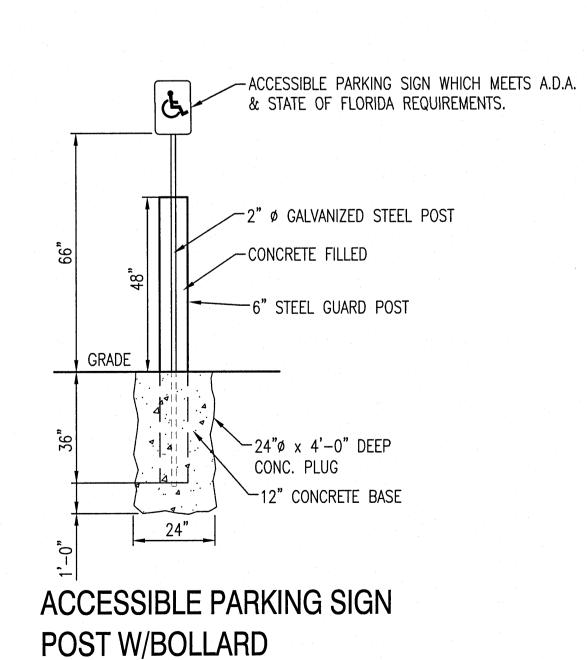

N.T.S.

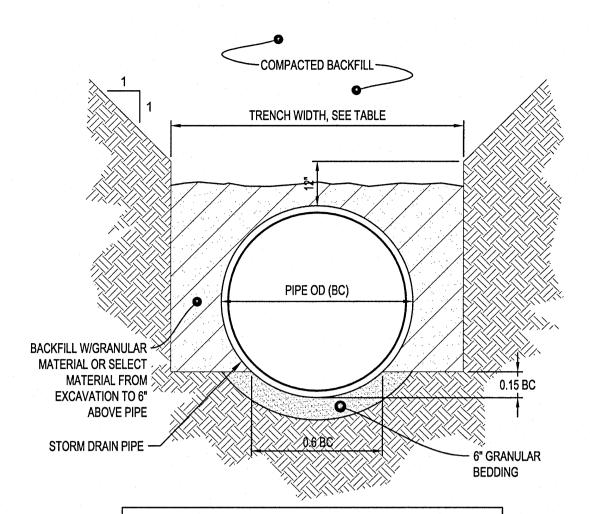


TRENCH WIDTH					
PIPE Ø	TRENCH WIDTH				
36" OR LESS	BC + 24"				
42" TO 54"	1.5 x BC				
60" OR OVER	BC + 36"				

NOTES:

GRANULAR BEDDING AND BACKFILL FOR STORM DRAIN PIPES SHALL BE INCIDENTAL TO STORM DRAIN CONSTRUCTION


NON-CONCRETE STORM DRAIN PIPE BEDDING NTS

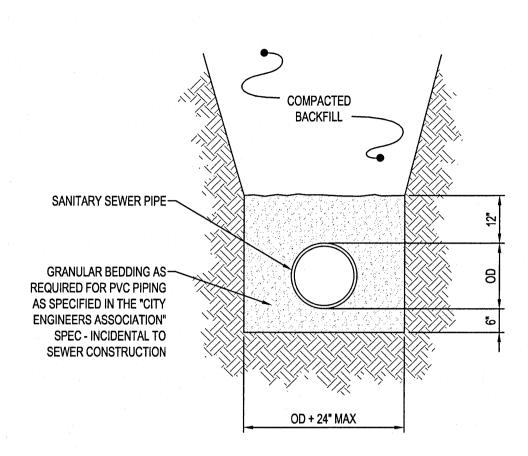


NOTES:

GRANULAR BEDDING AND ENCASEMENT FOR SANITARY SEWER PIPES SHALL BE INCIDENTAL TO CONSTRUCTION

> PIPE BEDDING SANITARY SEWER

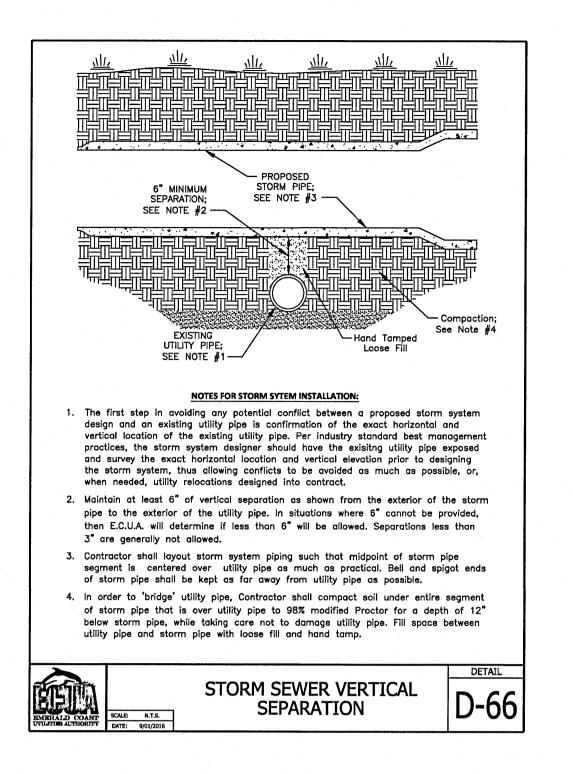

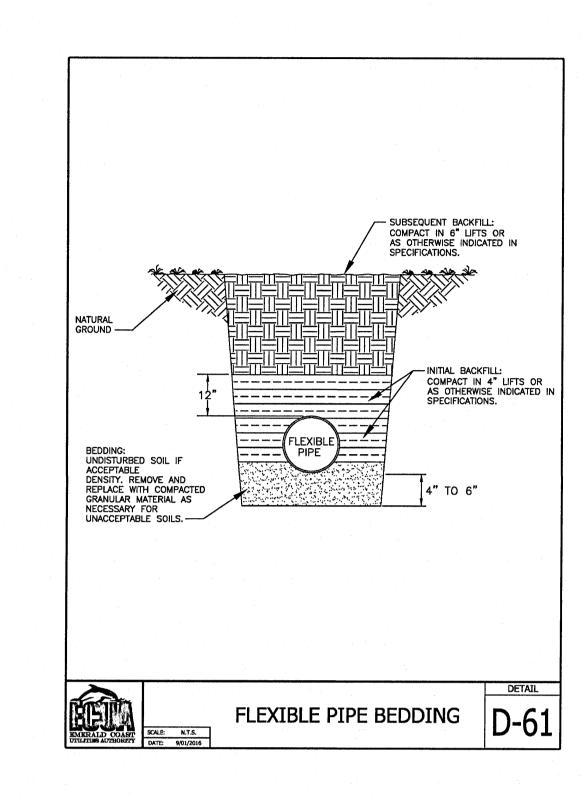

- COVER: SEE NOTE 2

24" PRE-CAST VALVE PAD 2" 4" -

- DENOTES COMPACTED BACKFILL

TRACER WIRE
(#12 AWG W/BLUE INSULATION
FOR WATER & GREEN INSULATION
FOR WASTEWATER)

CAST-IN-PLACE COLLAR

NATURAL GROUND-

CAST IRON VALVE BOX

(ADJUSTABLE SLIDE/SLIP TYPE) -

WATER MAIN

CONCRETE PAD OR SAKCRETE (12" AND LARGER VALVES)


1/2" ABOVE NATURAL GROUND LEVEL.


. VALVE BOX AND BOOT SHALL BE CAST IRON. . VALVE COVER SHALL BE MARKED "WATER" OR "SEWER" AS APPLICABLE . VALVE BOX TOP & COLLAR SHALL BE FLUSH WITH FINISHED GRADE OR

GATE VALVE SHALL BE RESILIENT SEAT WITH MECHANICAL JOINT ENDS.
EARTH UNDER FLANGE OF VALVE BOX & COLLAR TO BE FIRM AND WELL TAMPED TO ENSURE AGAINST VALVE BOX SETTLING.

TYPICAL VALVE & BOX


INSTALLATION

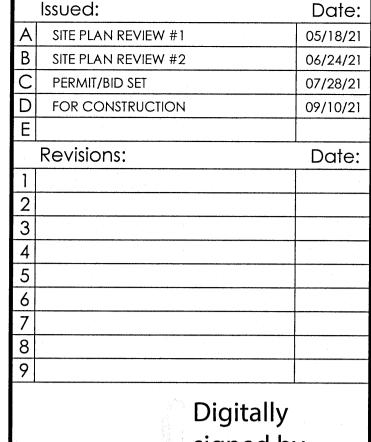

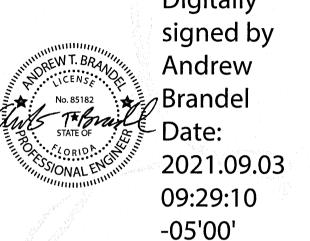

B.M. ELEVATION = 72.38' CUT 'X' LOCATED IN SIDEWALK AT THE NE CORNER OF THE INTERSECTION

OF MOBILE HWY AND EDISION DRIVE.

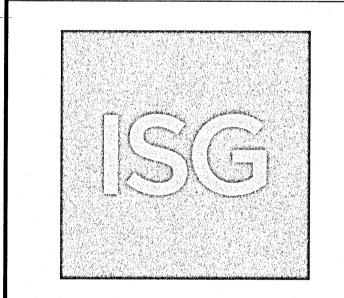

MANAGING LOCATION: MINNEAPOLIS / ST. PAUL OFFICE 7900 INTERNATIONAL DRIVE INTERNATIONAL PLAZA, SUITE 550 MINNEAPOLIS, MN 55425 PHONE: 952.426.0699



2080 ALDI Blvd Mt. Juliet, TN 37122

Store #: 156 PENSACOLA, FLORIDA 4830 MOBILE HIGHWAY PENSACOLA, FLORIDA 32506 ESCAMBIA COUNTY

Project Name & Location:

SITE DETAILS


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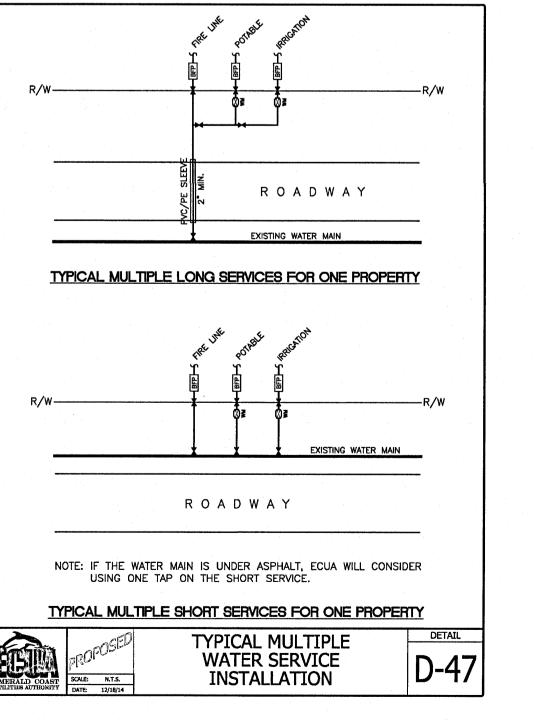
ISG Project No. Type: V7.0 ER 21-25050 Drawn By:


Designed By: JMF

Reviewed By: RJA Drawing No.

8" INSULATED DOUBLE DETECTOR CHECK VALVE BACKFLOW PREVENTER WATTS 757 DCDA ON FIRE LINE (SIZE PER PLAN) -GATE VALVES-(N.R.S.) -90' ELBOW 90' ELBOW-CLEARANCE PROVIDE SUPPORTS UNDER BACKFOW PREVENTER AS 30" REQUIRED The FLOW -90° ELBOW 90° ELBOW -



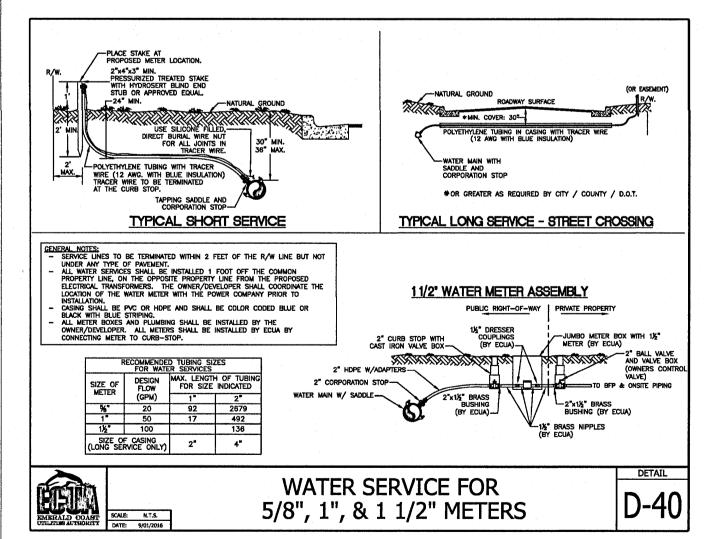


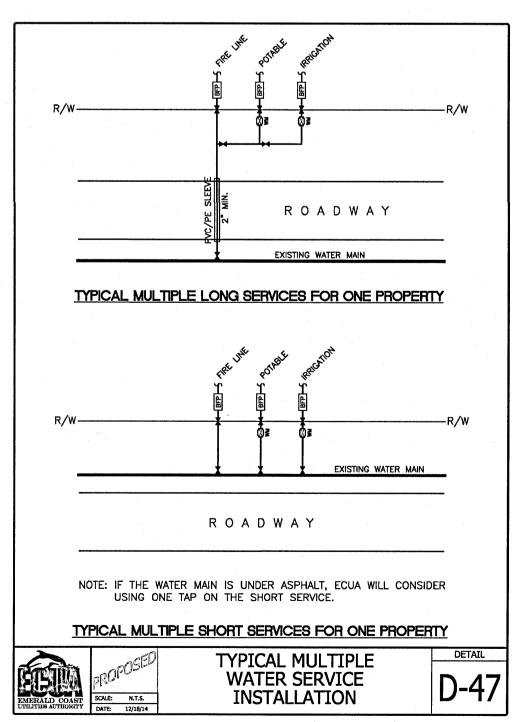



BACKFLOW PREVENTER DOUBLE CHECK DETECTOR DETAIL


N.T.S. NOTE: 1. ALL FITTINGS SHALL BE CAST OR DUCTILE IRON. PROVIDE THRUST BLOCKS FOR BELOW GROUND FITTINGS. SEE THRUST BLOCK


DETAIL, THIS SHEET. 2. DEVICE TO BE INSULATED FOR FREEZE PROTECTION WITH APPROVED MATERIALS.

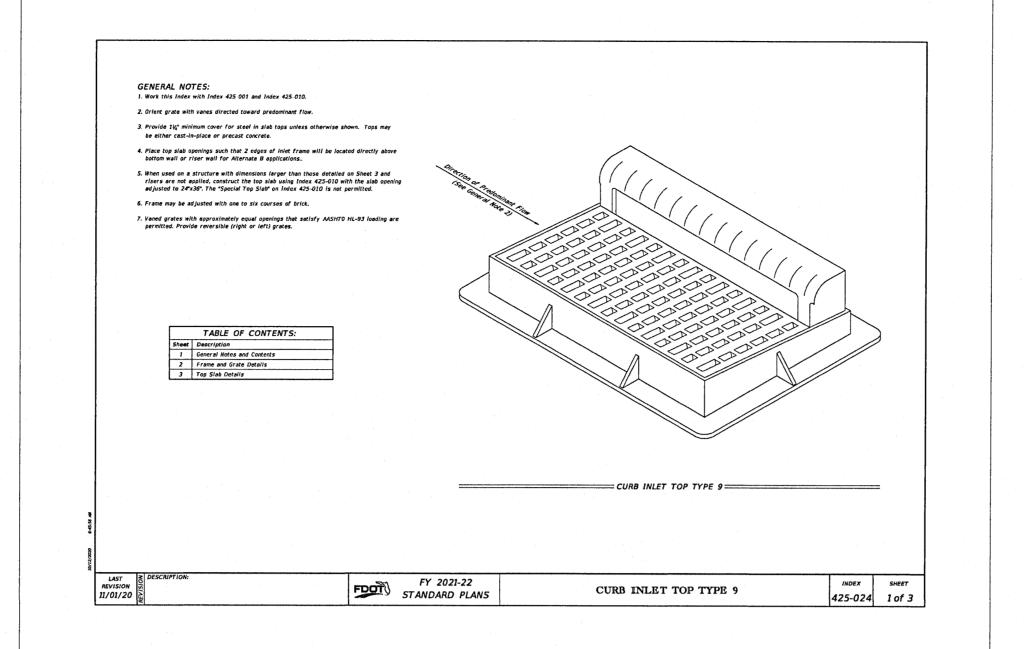


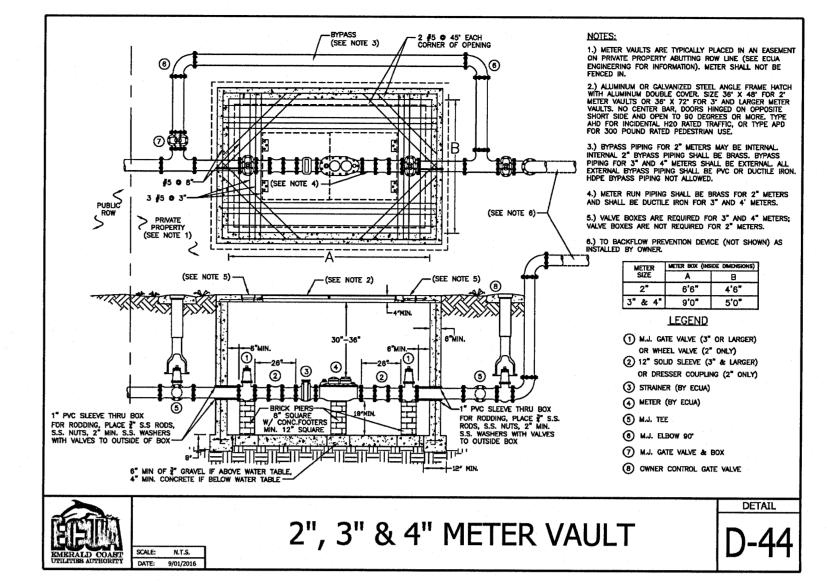


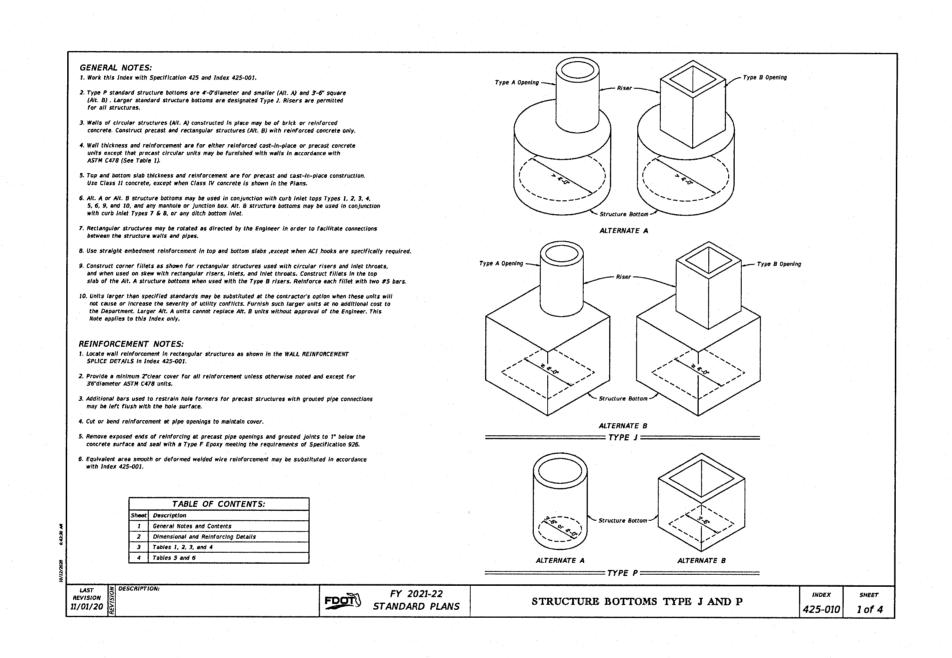

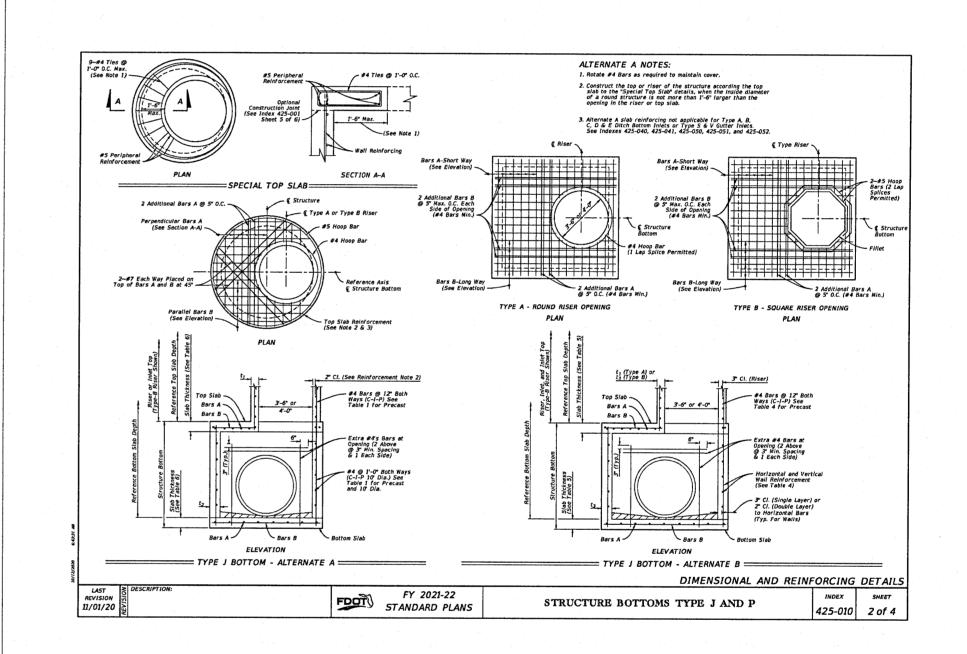

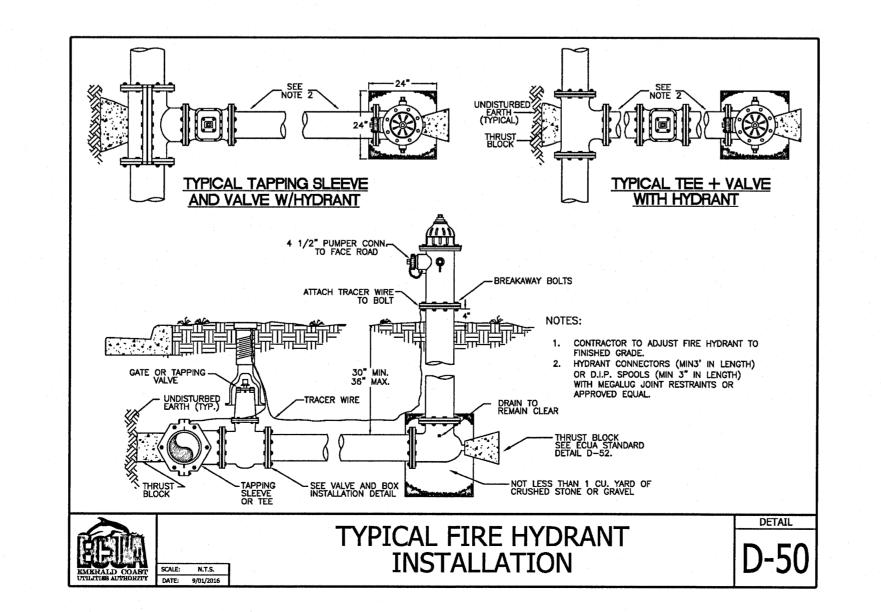

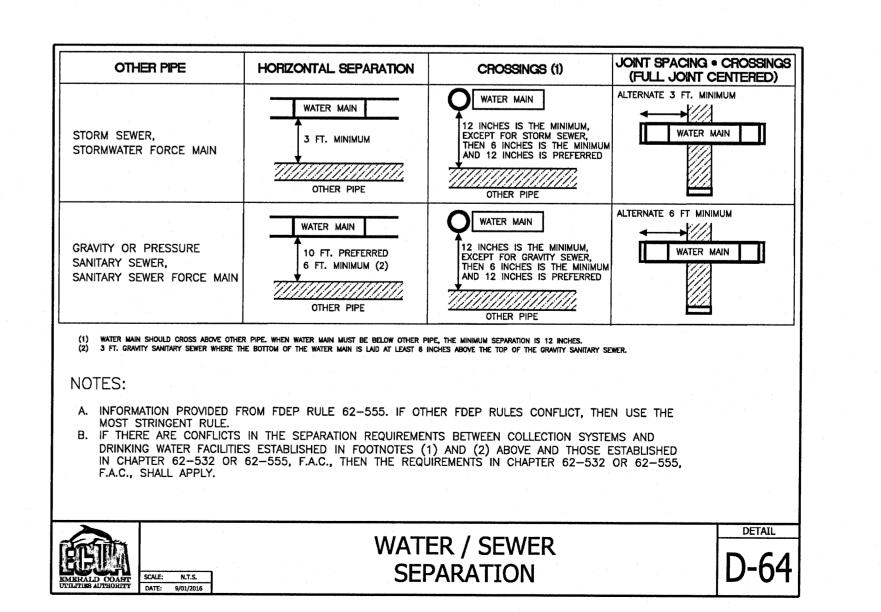


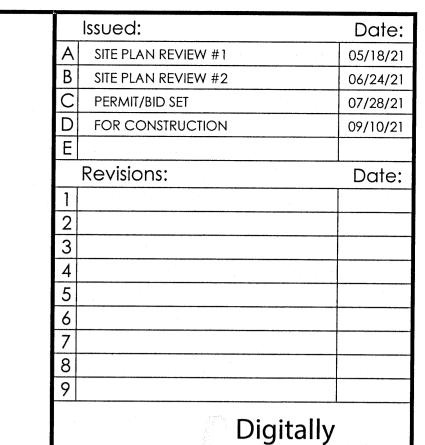


signed by
Andrew
Brandel
Date:
2021.09.03
09:29:31
-05'00'

B.M. ELEVATION = 72.38'
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OF MOBILE HWY AND EDISION DRIVE.

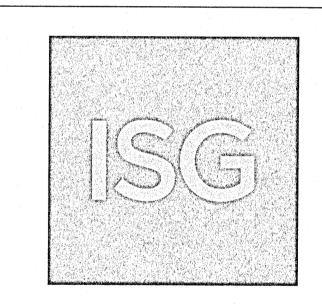

MANAGING LOCATION:
MINNEAPOLIS / ST. PAUL OFFICE
7900 INTERNATIONAL DRIVE
INTERNATIONAL PLAZA, SUITE 550
MINNEAPOLIS, MN 55425
PHONE: 952.426.0699

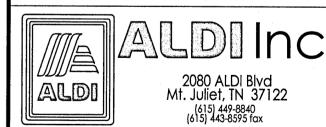

ALDI Inc. Store #: 156
PENSACOLA, FLORIDA
4830 MOBILE HIGHWAY
PENSACOLA, FLORIDA 32506
ESCAMBIA COUNTY

Project Name & Location:

SITE DETAILS


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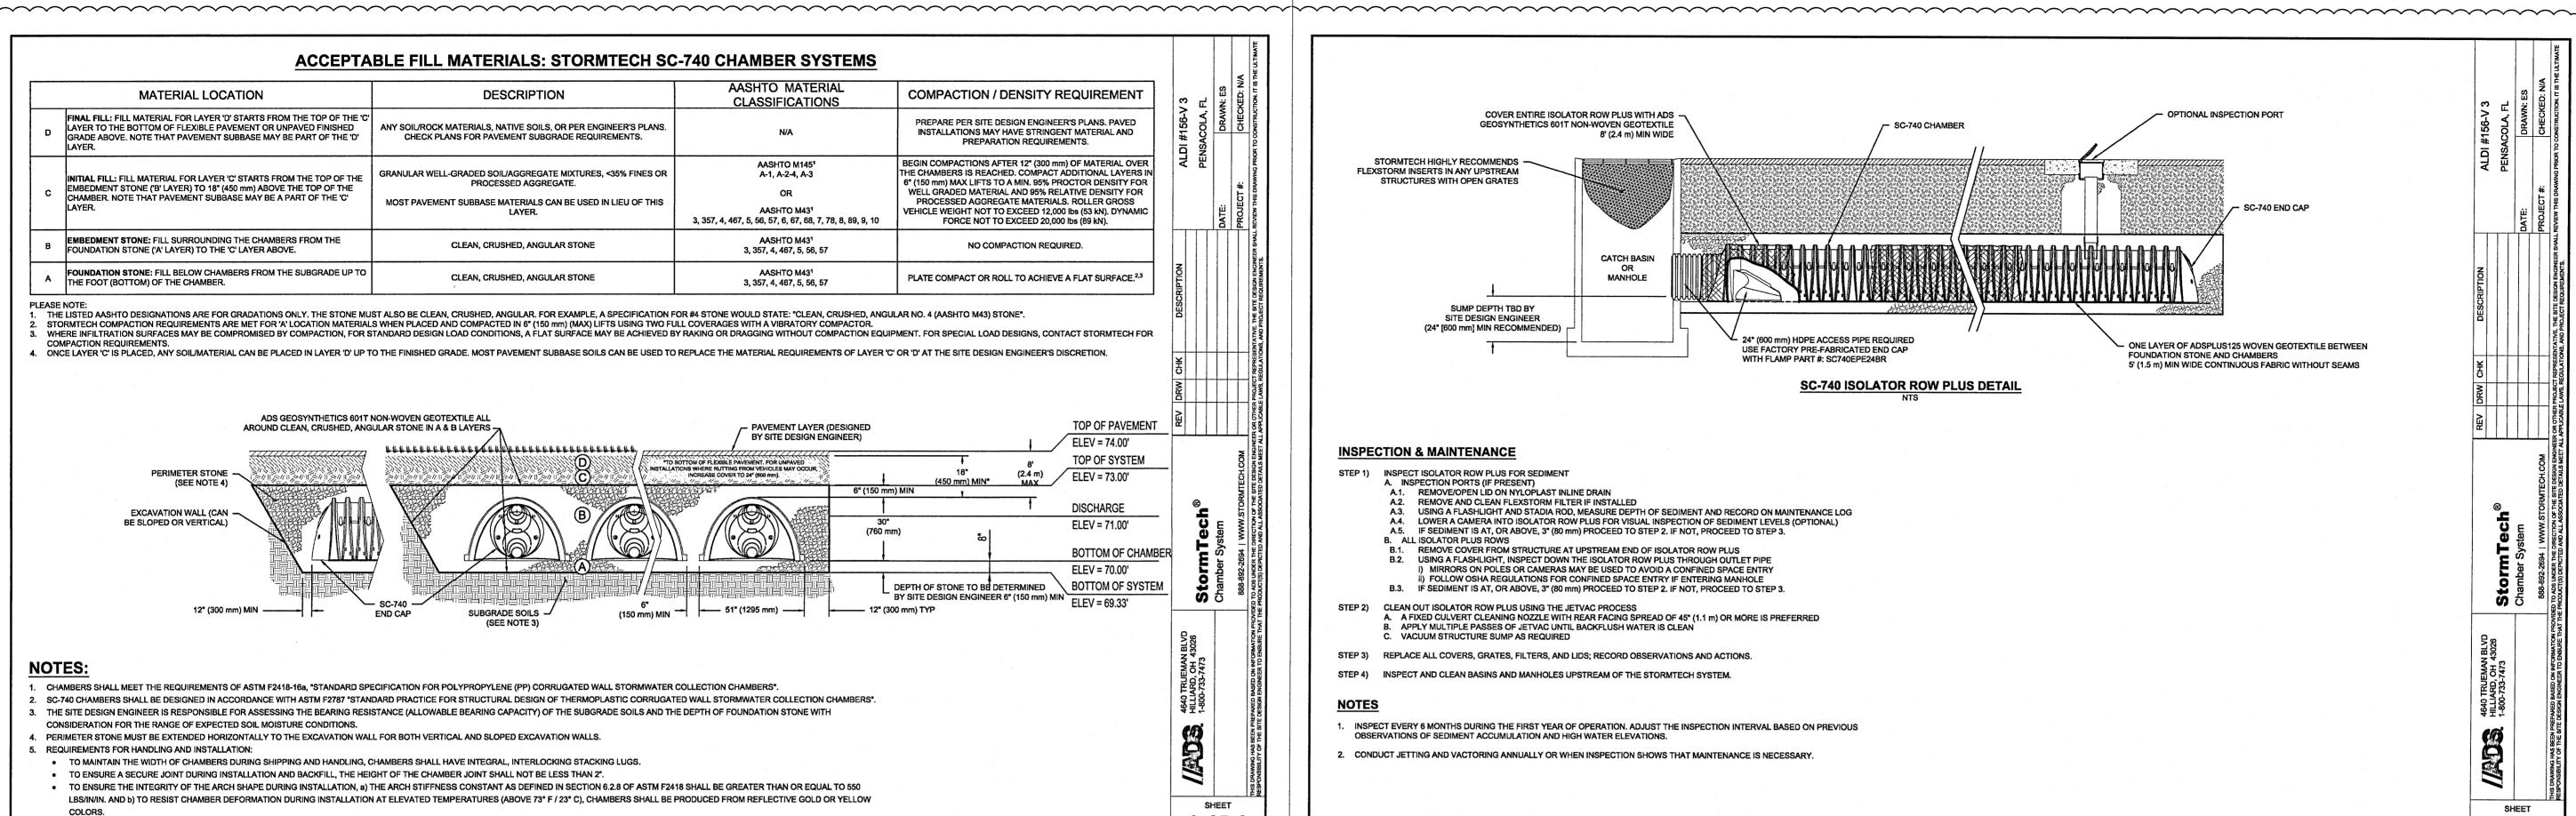
ISG Project No.
Type: V7.0 ER

Drawn By: JMF 21-25050

Designed By: JMF C-023

Reviewed By: RJA Drawing No.




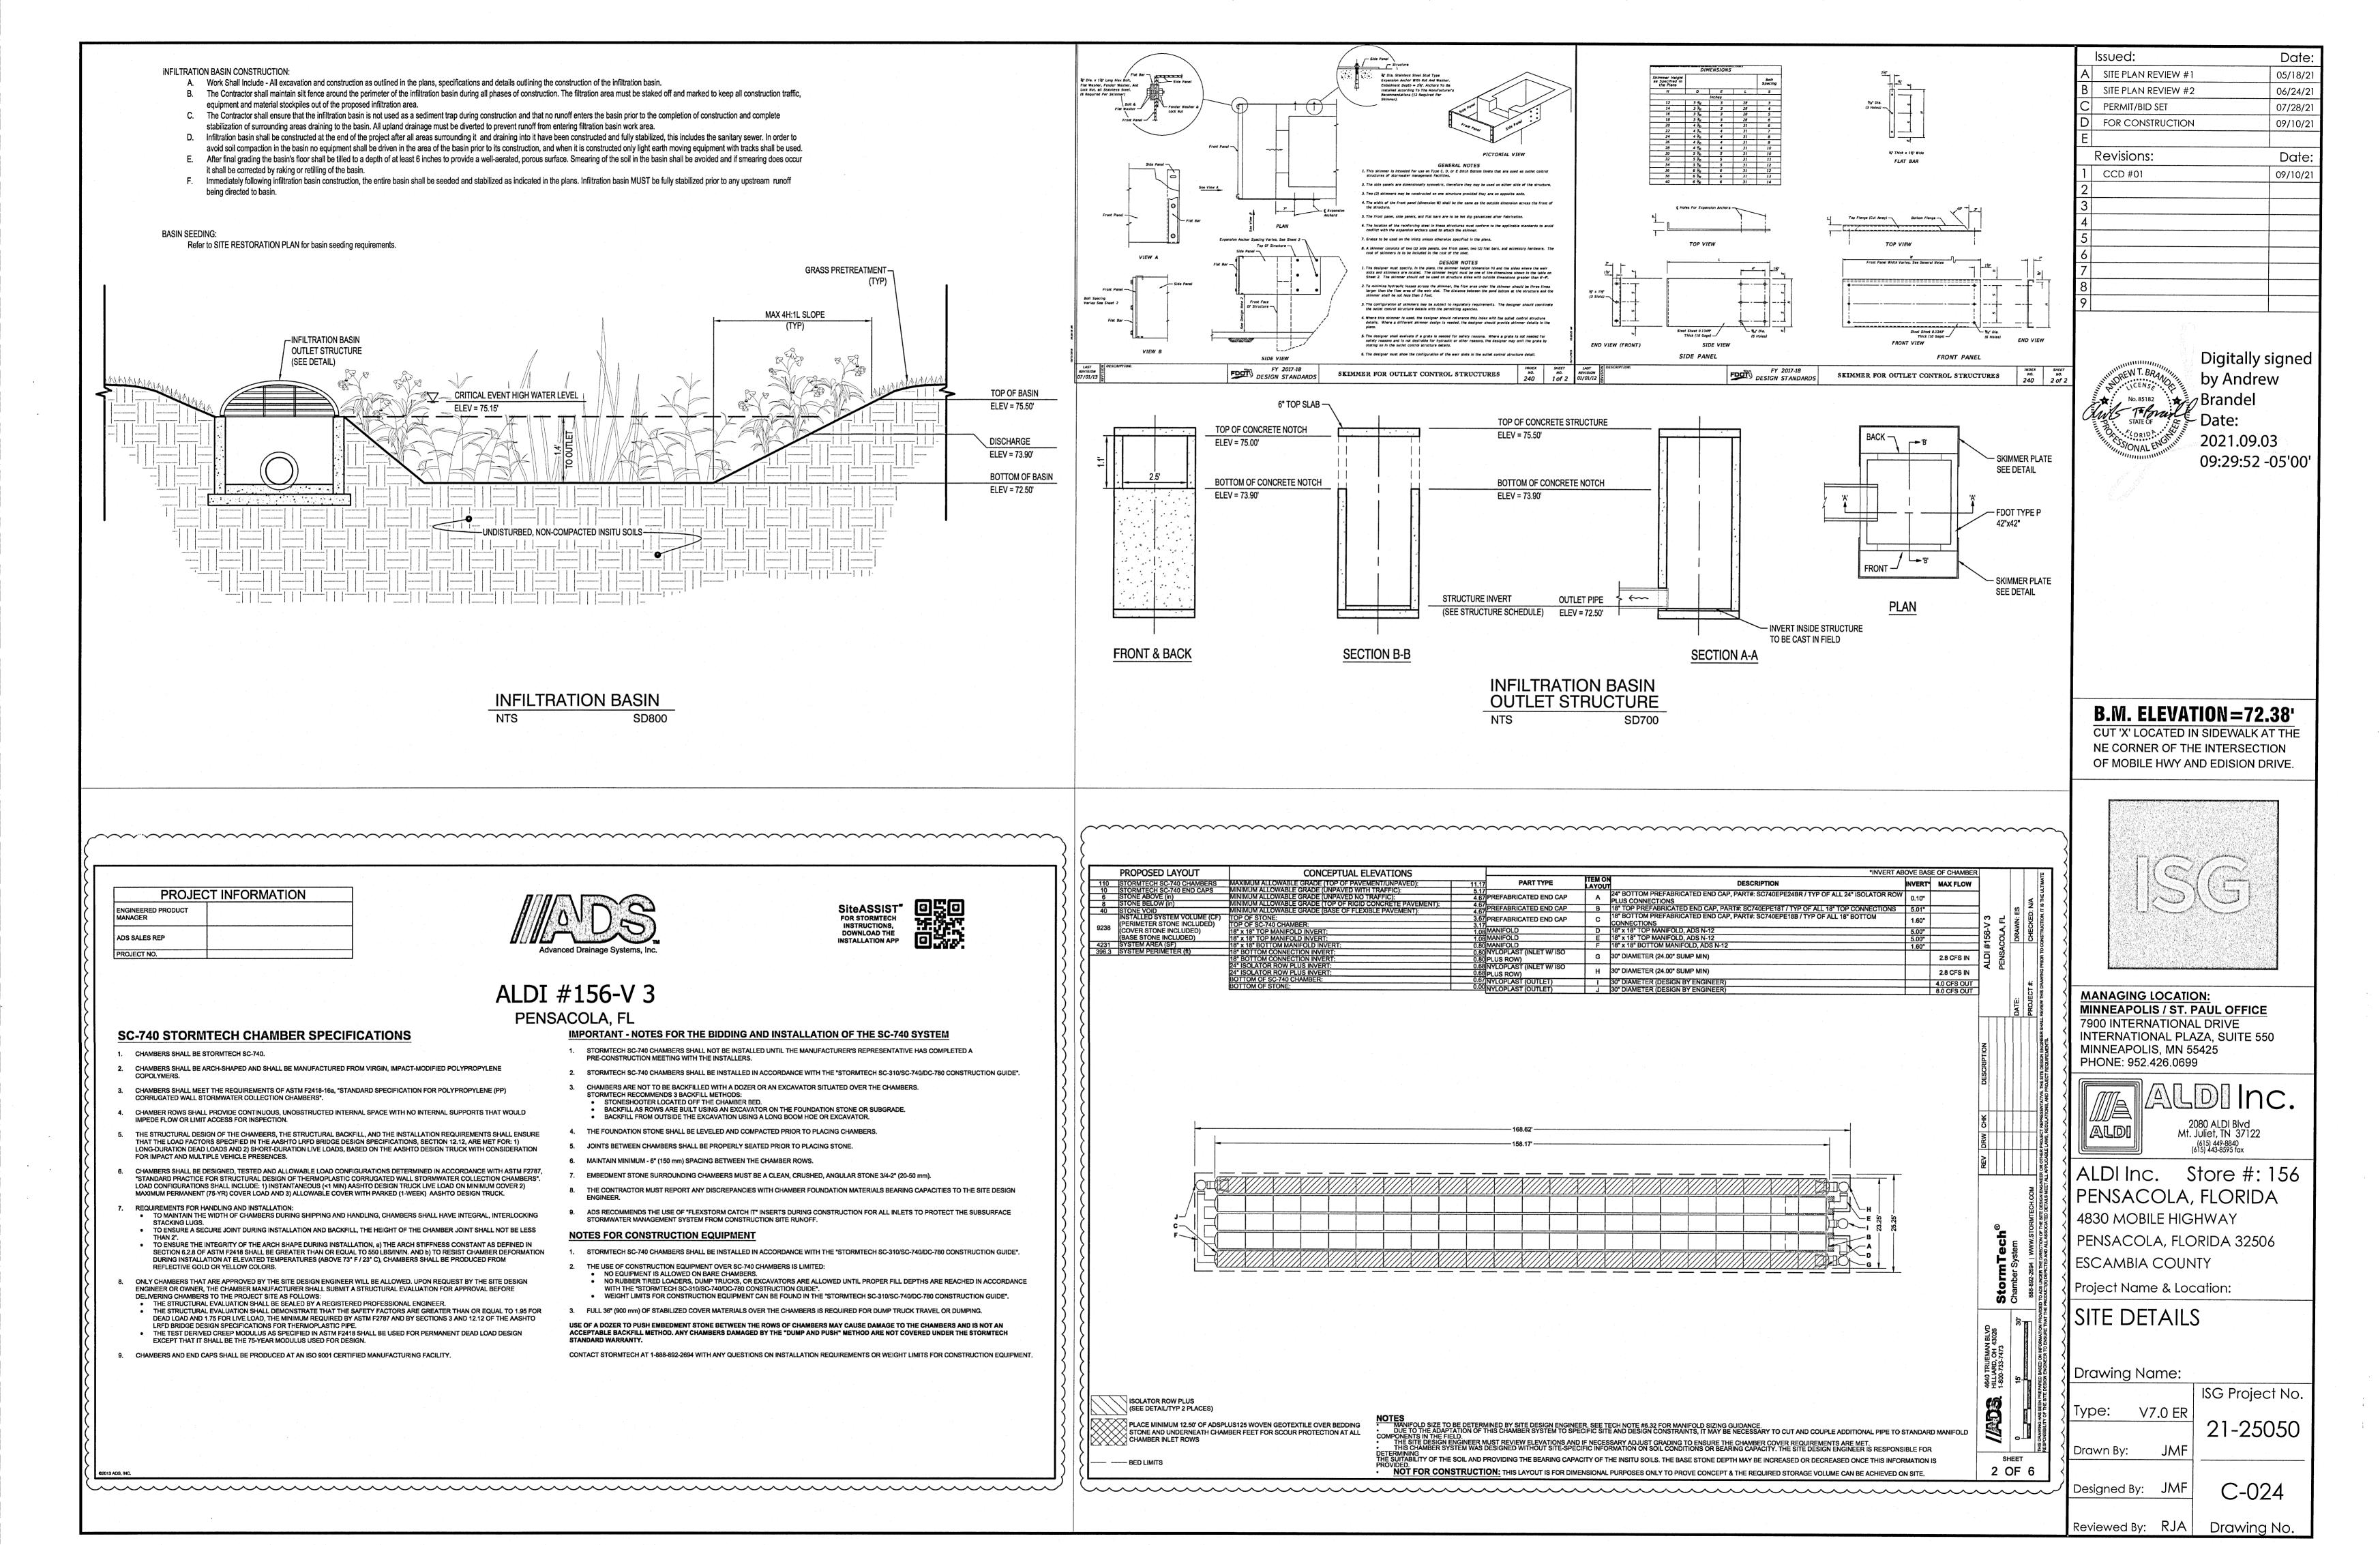



CHAMBER STORAGE

MINIMUM INSTALLED STORAGE

PART#

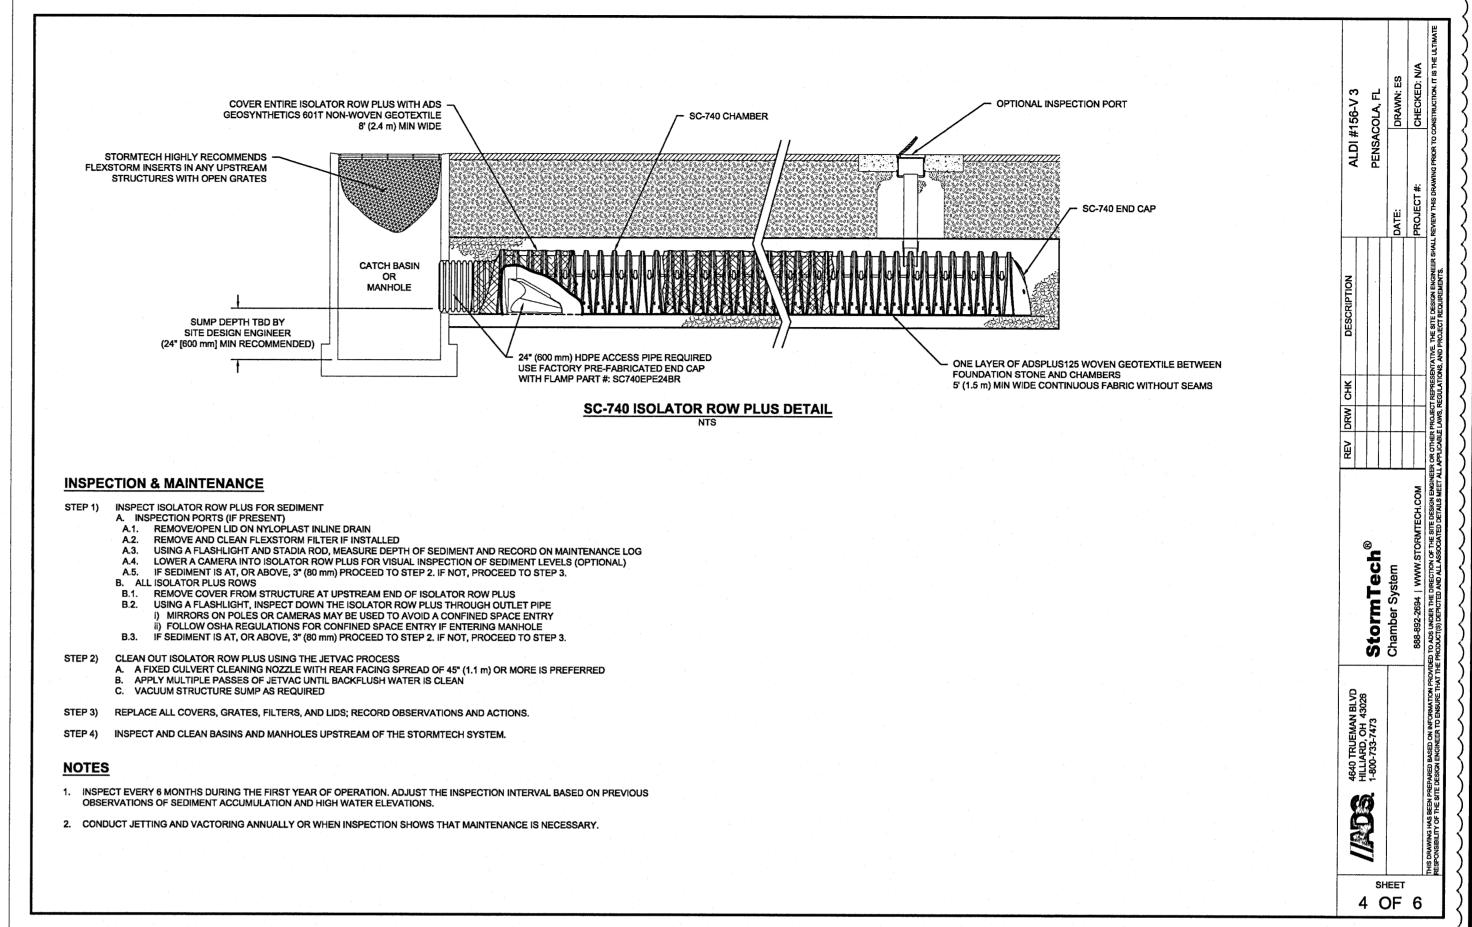


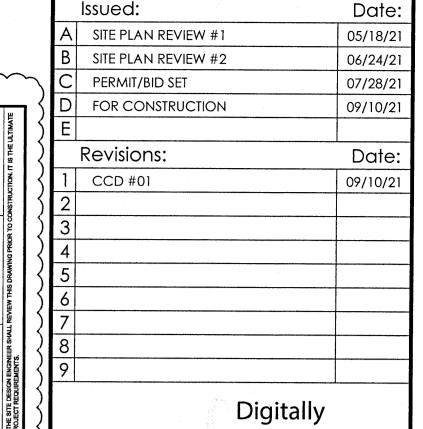

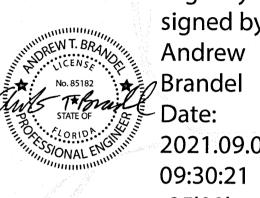

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2080 ALDI Blvd Mt. Juliet, TN 37122

Store #: 156 PENSACOLA, FLORIDA

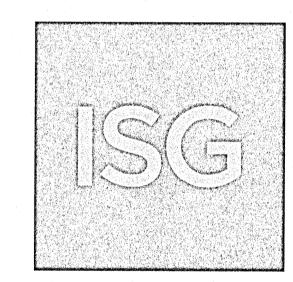4830 MOBILE HIGHWAY PENSACOLA, FLORIDA 32506

ESCAMBIA COUNTY


Project Name & Location:

21-25050


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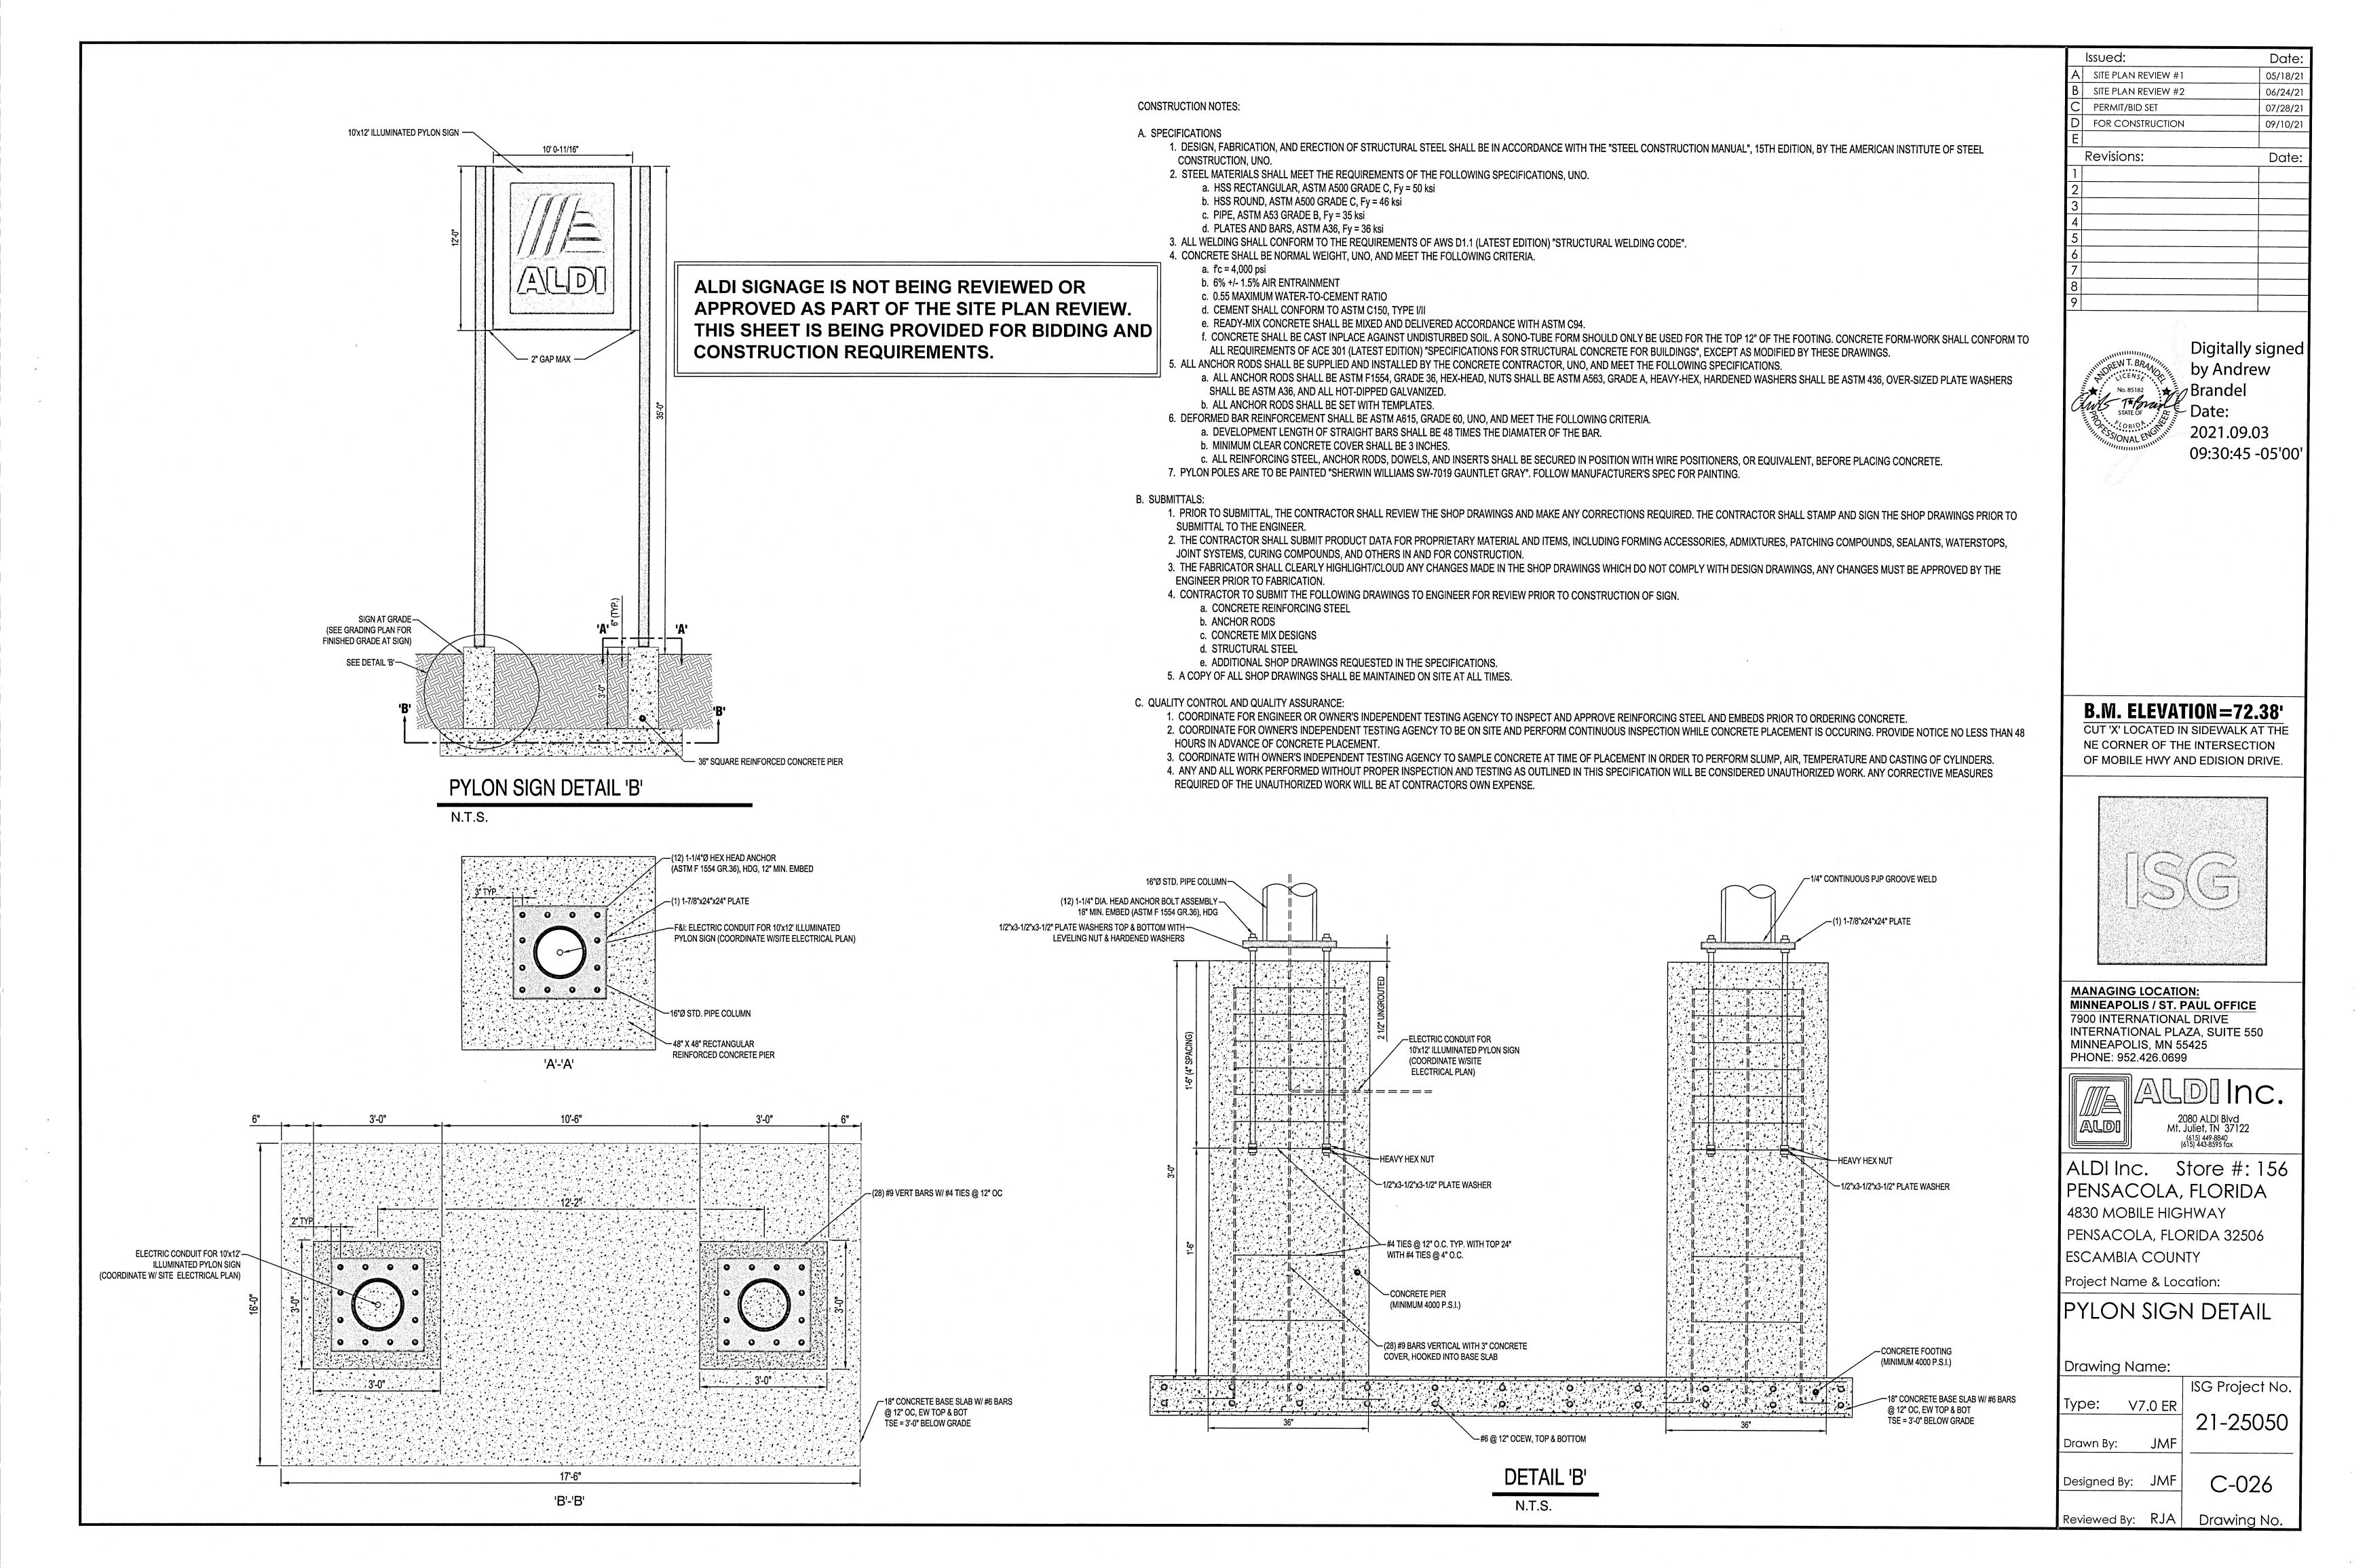
Drawing No.


Reviewed By:

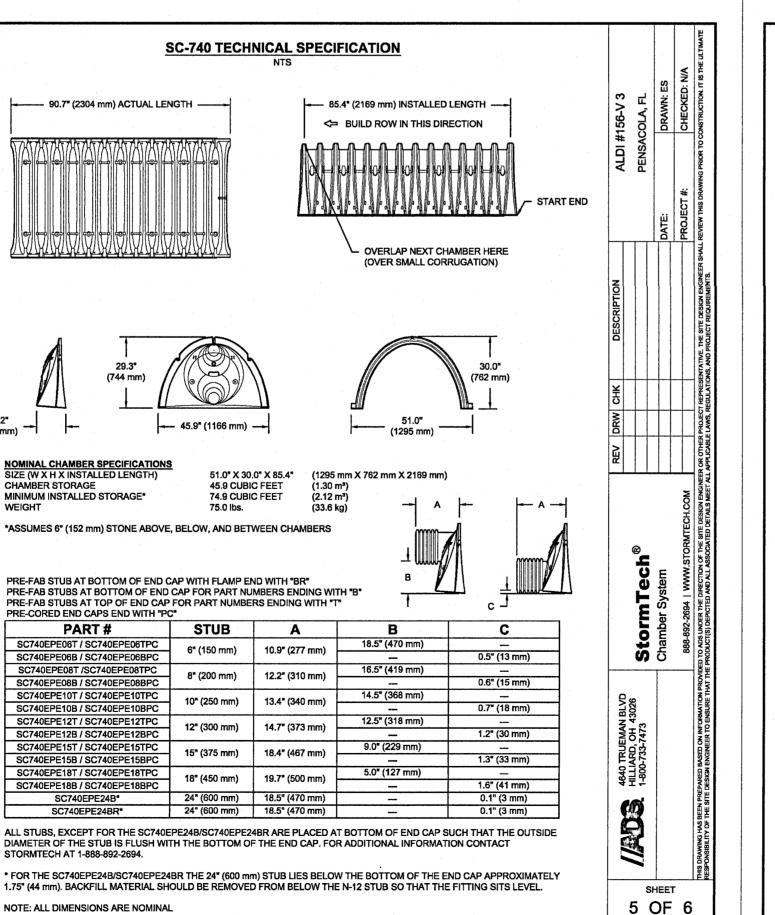


3 OF 6




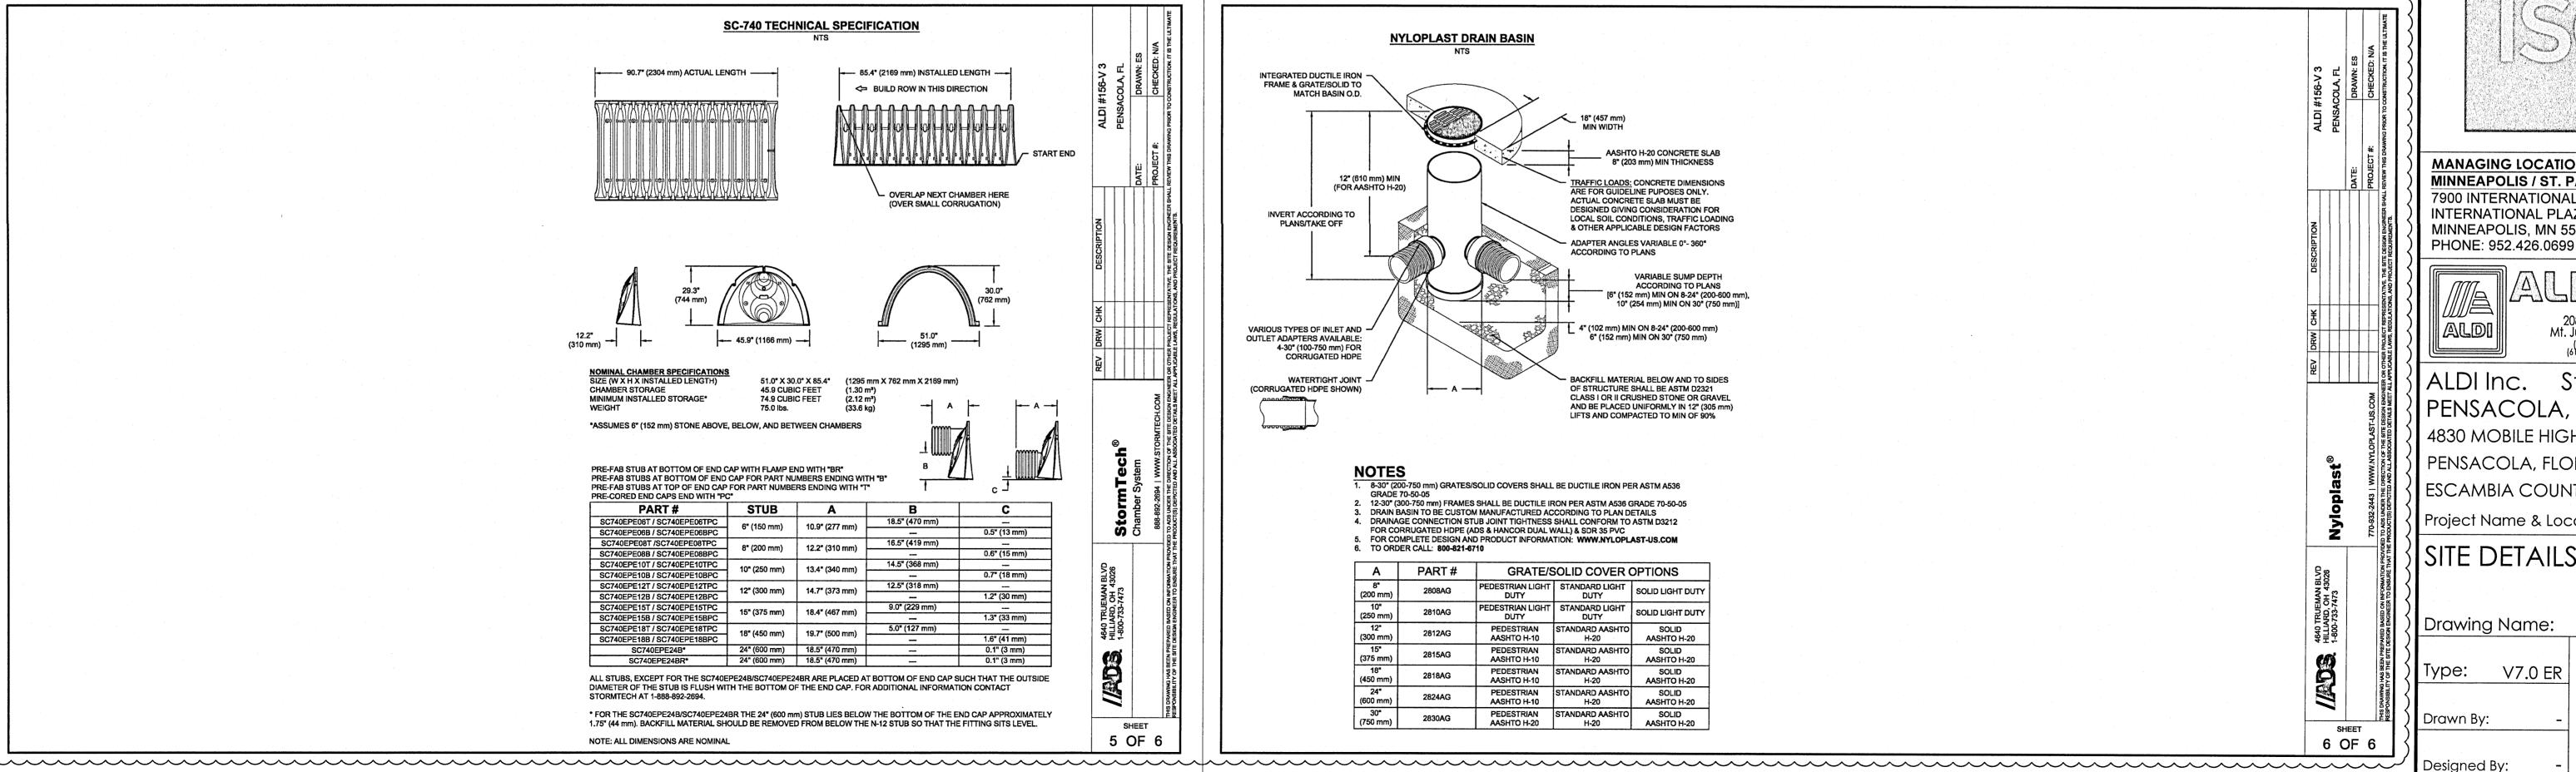

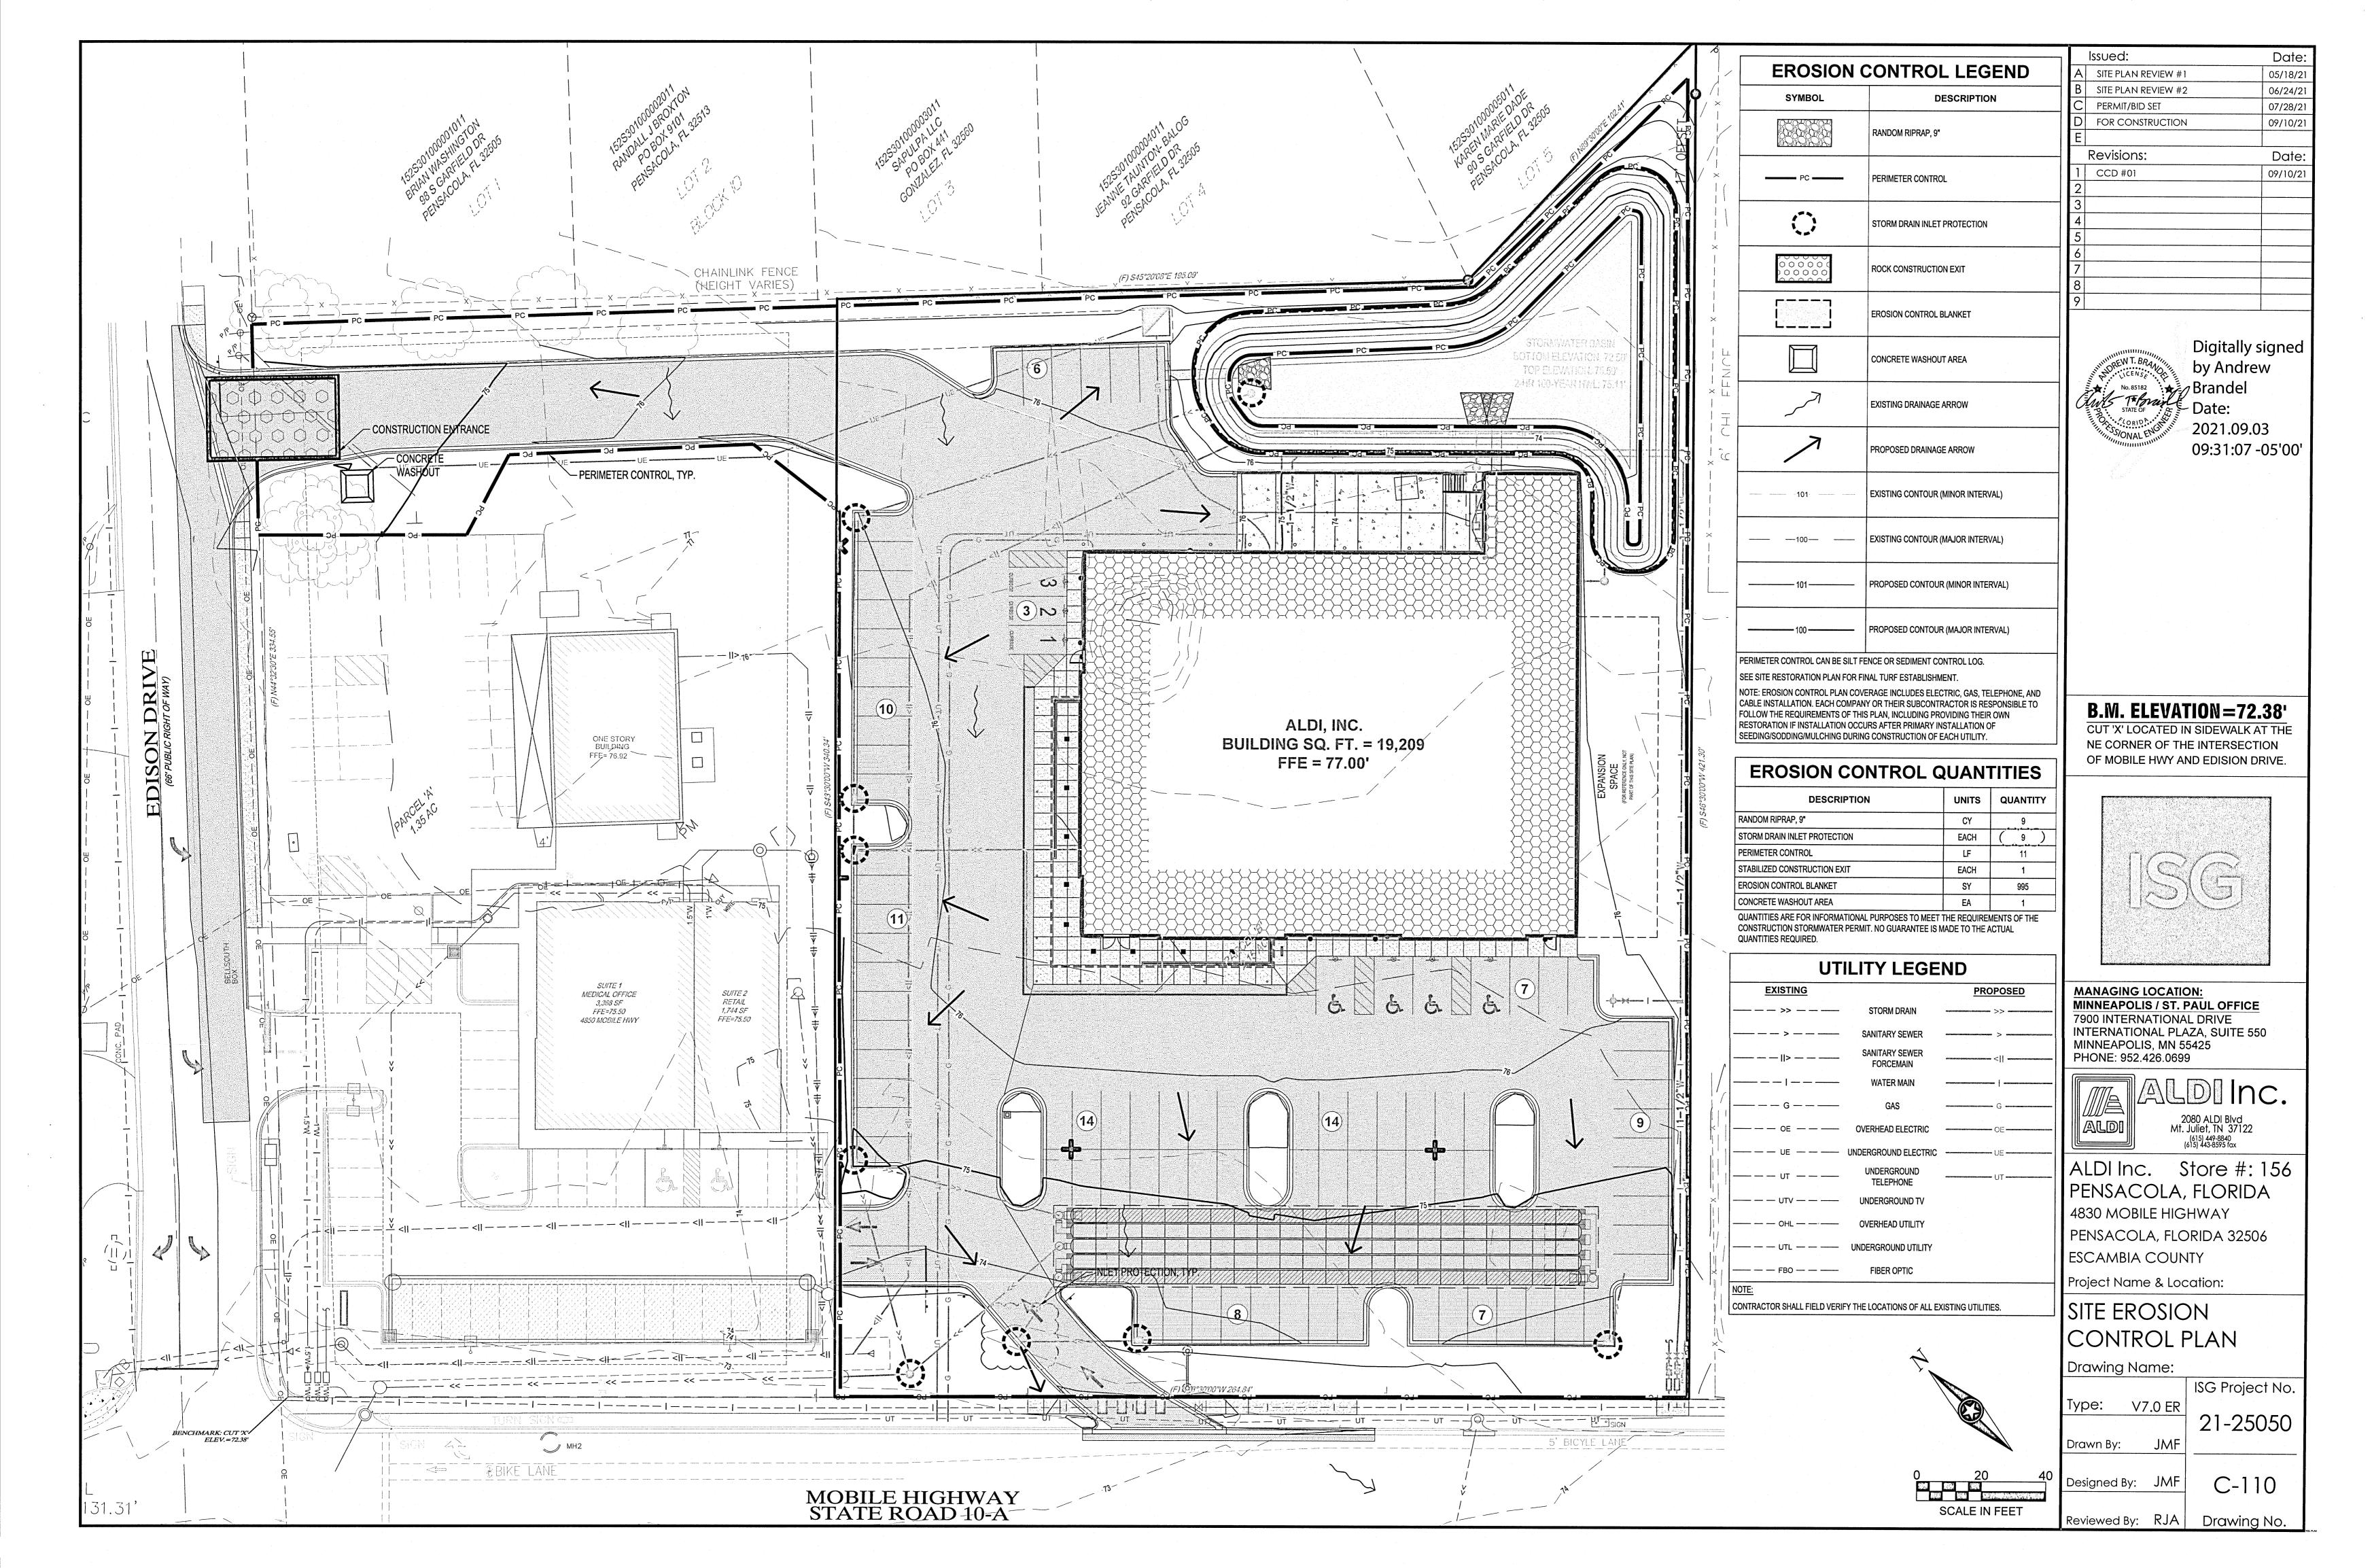

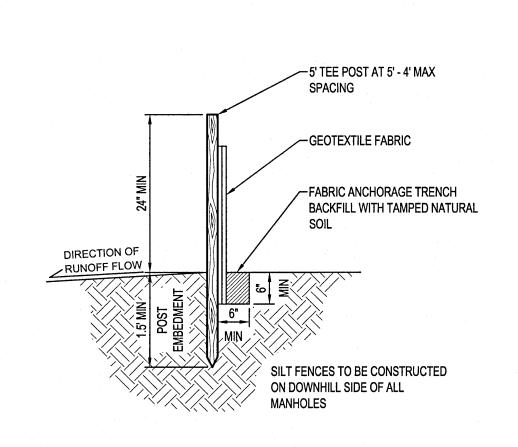

SILT FENCE

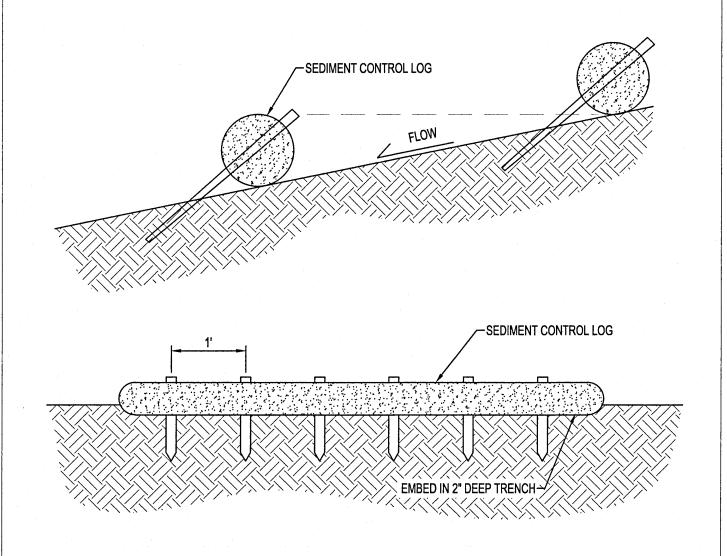

NOTES:


SEDIMENT CONTROL LOGS TO BE 6" DIAMETER UNLESS OTHEWISE NOTED. STAKED INTO THE GROUND WITH WOOD STAKES.

WOOD STAKES ARE A MINIMUM OF 2"x16"x½" UNLESS PRECLUDED BY PAVED SURFACE OR ROCK.

WOOD STAKES DRIVEN THROUGH BACK HALF OF SEDIMENT CONTROL LOG AT AN APPROXIMATE ANGLE OF 45° WITH THE TOP OF STAKE POINTING UP STREAM.

WHEN MORE THAN ONE SEDIMENT CONTROL LOG IS NEEDED, OVERLAP ENDS A MINIMUM OF 6" AND STAKE

SEDIMENT CONTROL LOG STAKING

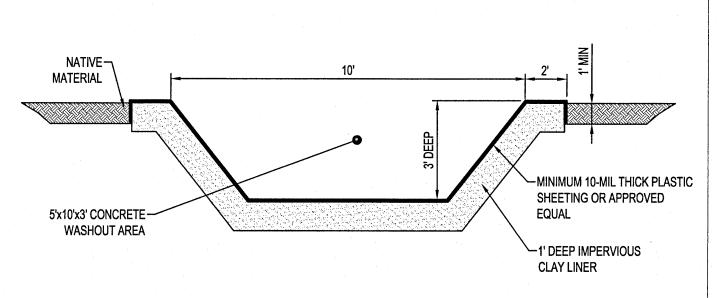

NOTES:

CONTRACTOR SHALL INSTALL A SIGN INDICATING THE CONCRETE WASHOUT AREA.


CONTRACTOR SHALL MAINTAIN WASHOUT AREA TO REMOVE MATERIALS BEYOND 75% CAPACITY.


WASHOUT AREA SHALL NOT BE PLACED WITHIN 50' OF STORM DRAINS, OPEN DITCHES OR BODIES OF WATER.

CONTRACTOR SHALL INSPECT WASHOUT AREA AS NECESSARY TO PREVENT LEAKS AND OVER TOPPING.

WASHOUT AREA SHALL BE REMOVED AFTER CONSTRUCTION IS COMPLETE.

CONCRETE WASHOUT EC500

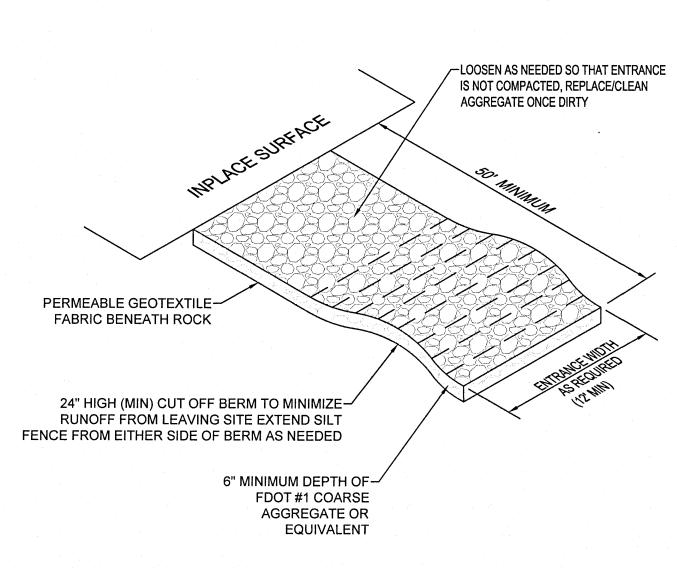

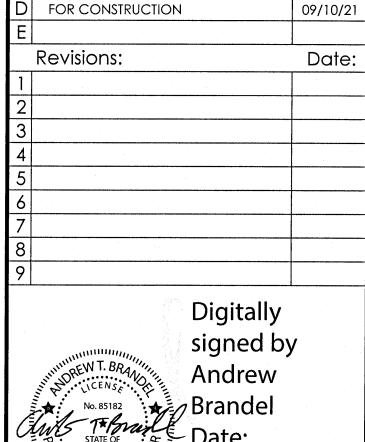

Issued:

SITE PLAN REVIEW #1

PERMIT/BID SET

SITE PLAN REVIEW #2

Date:

05/18/21


06/24/21

07/28/21



B.M. ELEVATION=72.38'

CUT 'X' LOCATED IN SIDEWALK AT THE NE CORNER OF THE INTERSECTION OF MOBILE HWY AND EDISION DRIVE.

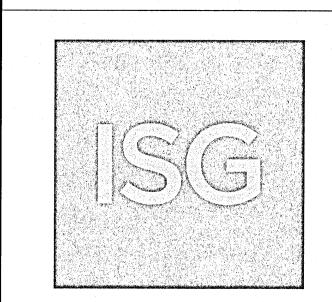

MANAGING LOCATION: MINNEAPOLIS / ST. PAUL OFFICE 7900 INTERNATIONAL DRIVE INTERNATIONAL PLAZA, SUITE 550 MINNEAPOLIS, MN 55425 PHONE: 952.426.0699



ALDI Inc. Store #: 156 PENSACOLA, FLORIDA

4830 MOBILE HIGHWAY PENSACOLA, FLORIDA 32506 ESCAMBIA COUNTY

Project Name & Location:

SITE EROSION CONTROL DETAILS

Drawing Name:


ISG Project No. Type: V7.0 ER 21-25050

Drawn By: JMF

Designed By: JMF

Reviewed By: RJA Drawing No.

STABILIZED CONSTRUCTION EXIT NTS EC600

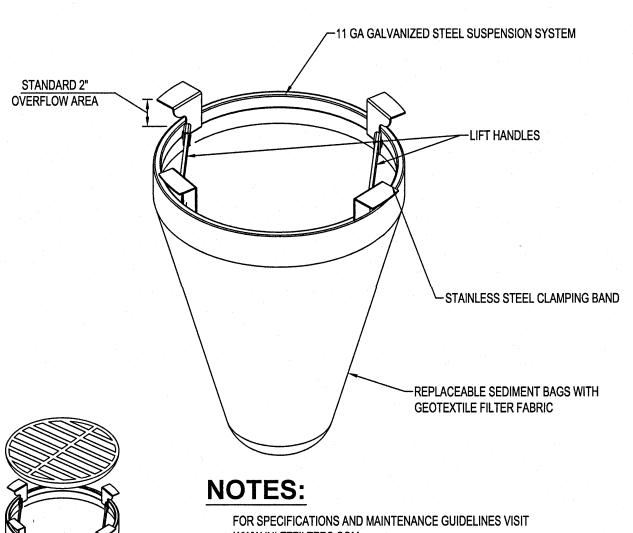

WWW.INLETFILTERS.COM **INSTALLATION:** REMOVE GRATE DROP FLEXSTORM INLET FILTER ONTO LOAD BEARING LIP OF CASTING OR

MATERIALS:


FRAMING - 11 GAUGE STEEL; CORROSION RESISTANT


SEDIMENT BAG - WOVEN GEOTEXTILE FABRIC; 2 CUBIC FOOT TYP VOLUME; STAINLESS STEEL LOCKING BAND SECURING BAG TO FRAME

ROUND FILTER INLET PROTECTION NTS EC210

CONCRETE STRUCTURE

REPLACE GRATE

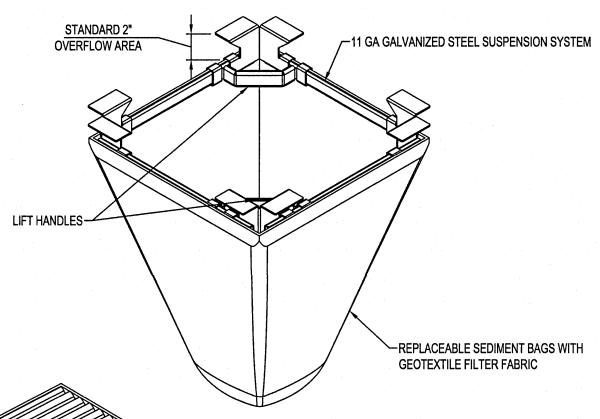

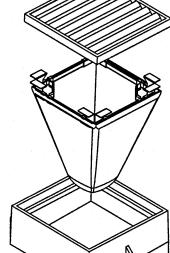

NOTES:

FOR SPECIFICATIONS AND MAINTENANCE GUIDELINES VISIT WWW.INLETFILTERS.COM

INSTALLATION: REMOVE GRATE

> DROP FLEXSTORM INLET FILTER ONTO LOAD BEARING LIP OF CASTING OR CONCRETE STRUCTURE


REPLACE GRATE

MATERIALS:


FRAMING - 11 GAUGE STEEL; CORROSION RESISTANT


SEDIMENT BAG - WOVEN GEOTEXTILE FABRIC; 2 CUBIC FOOT TYP VOLUME; STAINLESS STEEL LOCKING BAND SECURING BAG TO FRAME

RECTANGULAR FILTER **INLET PROTECTION** NTS EC211

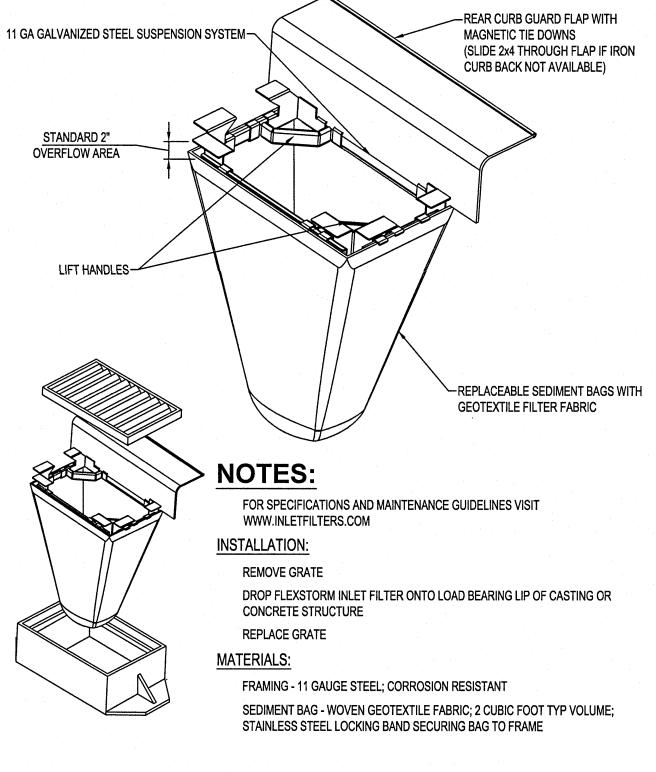

CURB BOX FILTER INLET PROTECTION EC212

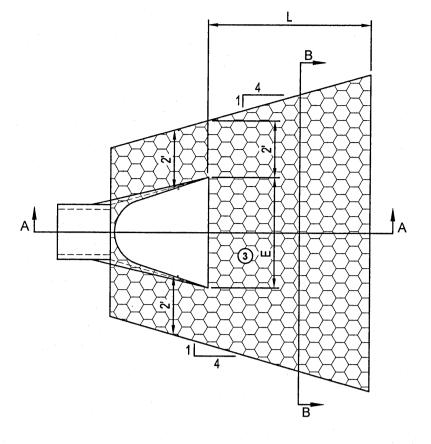

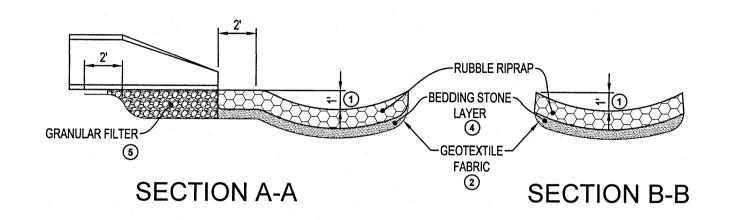

	DIMENSIONS								
	PIPE Ø (INCHES)	L (FEET)	PIPE (INCH						
	12	8	27	12					
;	15	8	30	14					
	18	10	36	16					
	21	10	42	18					
	24	12	48	20					


NOTES:

REQUIREMENTS FOR GEOTEXTILE TYPE, RIPRAP SIZE AND THICKNESS WILL BE DESIGNATED IN THE

PIPE SIZES LARGER THAN THOSE SHOWN REQUIRE A SPECIAL DESIGN

- 1 FOR PIPES GREATER THAN OR EQUAL TO 30", USE 1.5'
- GEOTEXTILE FABRIC NON WOVEN MONOFILAMENT TYPE D-2 PER FDOT INDEX 199, SHALL COVER THE BOTTOM AND SIDES OF THE AREA EXCAVATED FOR THE RIPRAP, GRANULAR FILTER MATERIALS
- 3 DIMENSION "E" IS THE WIDTH AT THE END OF THE FES.
- 4 BEDDING STONE LAYER MEETING THE REQUIREMENTS OF FDOT SPECIFICATION 530-2.3.
- RUBBLE RIPRAP, FDOT SPEC. 530-2.2.2, TO EXTEND UNDER THE ENTIRE OPEN PORTION OF PIPE APRON. BROKEN SIDEWALKS OR PAVEMENT SHALL NOT BE USED. DEPTH OF MATERIAL UNDER APRON SHALL (5) MATCH RIPRAP DEPTH. WHEN USING RIPRAP, INCREASE RIPRAP QUANTITY ACCORDINGLY AND PLACE A 3" LAYER OF 1.5" CRUSHED ROCK UNDER THE APRON TO AID IN GRADING FOR APRON PLACEMENT. CRUSHED ROCK IS INCIDENTAL.

RIPRAP AT RCP OUTLET EC400

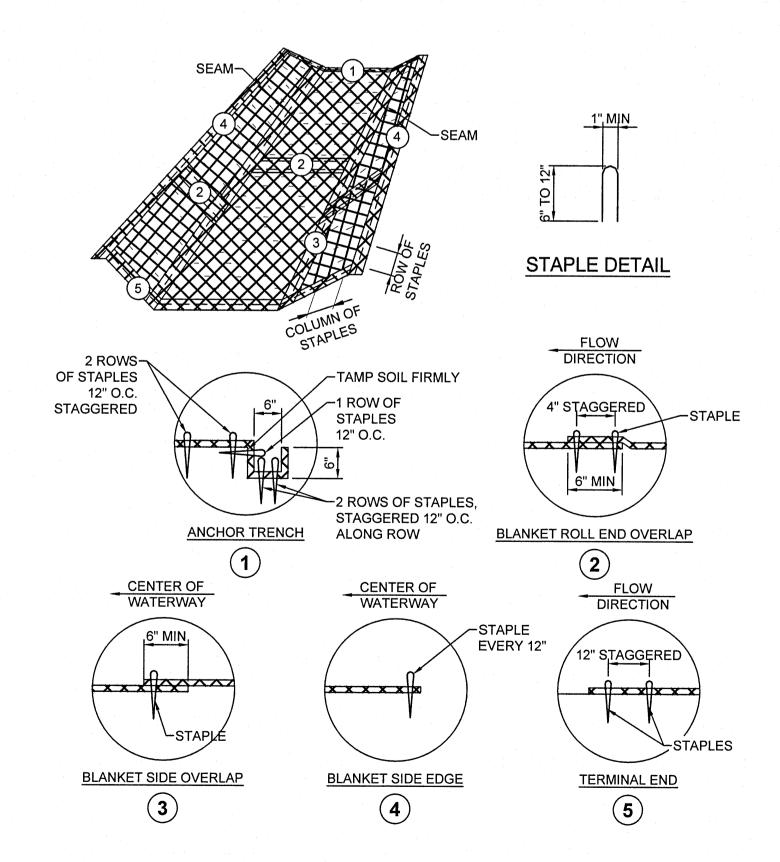

NOTES:

INSTALL EROSION CONTROL BLANKET (ECB) OVER WATERWAYS AS SHOWN IN THE STORM WATER POLLUTION PREVENTION PLAN.

THE ECB SHALL CONFORM TO MINDOT STANDARD SPECIFICATIONS SECTION 3885.

PREPARE SOIL PRIOR TO INSTALLING ECB, INCLUDING SEEDING AND FERTILIZING. THE ECB SHALL BE PLACED IN FIRM CONTACT WITH THE SOIL AND NOT BE ALLOWED TO

BRIDGE OVER SURFACE IRREGULARITIES. THE MAT SHALL NOT BE STRETCHED. START LAYING THE MATS BY ROLLING CENTER MAT IN THE DIRECTION OF FLOW, CENTERED ON THE CENTERLINE OF WATERWAY. THERE SHALL NOT BE AN OVERLAP OF MATS AT THE CENTER OF THE WATERWAY.


THE ECB SHALL BE ANCHORED, OVERLAPPED, AND STAPLED ACCORDING TO MANUFACTURER'S INSTRUCTIONS. IF NO MANUFACTURER'S INSTRUCTIONS ARE AVAILABLE, INSTALL THE MAT AS FOLLOWS.

STAPLES SHALL BE "U" SHAPED, 0.12" DIAMETER WIRE OR GREATER (#11 GAUGE). (SEE STAPLE DETAIL FOR DIMENSIONS)

- BURY UPSTREAM END OF MAT IN A TRENCH 6" WIDE BY 6" DEEP AND STAPLED IN STAGGERED ROWS ACROSS THE WIDTH AS SHOWN IN DETAIL 1.
- C. FOR JOINING ENDS OF ROLLS, OVERLAP END OF UP SLOPE MAT A MINIMUM OF 6" 2 OVER DOWN SLOPE MAT (SHINGLE STYLE). USE A DOUBLE ROW OF STAGGERED STAPLES 4" APART, AS SHOWN IN DETAIL 2.
- D. MATS ON SIDE SLOPES SHALL OVERLAP A MINIMUM OF 6" OVER THE MAT BELOW (SHINGLE STYLE). STADLE OVERLAP AT ACT OF THE MAT BELOW (SHINGLE STYLE). STAPLE OVERLAP AT 12" INTERVALS. (SEE DETAIL 3)
- E. THE OUTER EDGE ALONG SIDES OF THE MAT SHALL BE STAPLED EVERY 12". (SEE DETAIL 4)
- F. STAPLES ARE TO BE PLACED ALTERNATELY IN COLUMNS (IN THE DIRECTION OF THE WATERWAY) 2' APART AND IN ROWS (ACROSS THE WATERWAY) 3' APART THROUGHOUT THE AREA COVERED BY THE ECB.
- G. DOWNSTREAM (TERMINAL) END OF BLANKET SHALL BE STAPLED WITH A DOUBLE ROW OF STAGGERED STAPLES 12" APART. (SEE DETAIL 5)

EROSION CONTROL BLANKET INSTALLATION


Issued: Date: SITE PLAN REVIEW #1 05/18/21 SITE PLAN REVIEW #2 06/24/21 PERMIT/BID SET 07/28/21 FOR CONSTRUCTION 09/10/21 Revisions: Date:

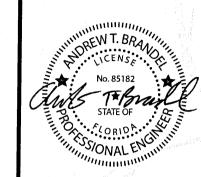

Digitally signed by Andrew Brandel 2021.09.03 09:31:51 -05'00'

B.M. ELEVATION=72.38'

CUT 'X' LOCATED IN SIDEWALK AT THE NE CORNER OF THE INTERSECTION OF MOBILE HWY AND EDISION DRIVE

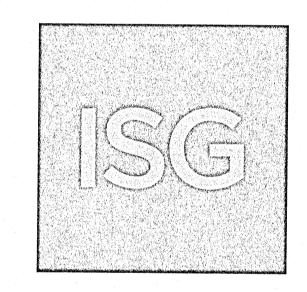

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2080 ALDI BIVd Mt. Juliet, TN 37122

ALDI Inc. Store #: 156 PENSACOLA, FLORIDA 4830 MOBILE HIGHWAY PENSACOLA, FLORIDA 32506

ESCAMBIA COUNTY

Project Name & Location:

SITE EROSION CONTROL DETAILS

Drawing Name:

ISG Project No. Type: V7.0 ER 21-25050

Drawn By: JMF Designed By: JMF

Reviewed By: RJA Drawing No.

STORMWATER POLLUTION PREVENTION PLAN (SWPPP) NARRATIVE

PROJECT LOCATION
PROJECT/SITE NAME: ALDI STORE #156 PROJECT LOCATION: 4830 MOBILE HIGHWAY CITY/TOWNSHIP: PENSACOLA COUNTY/STATE: FLORIDA

ZIP CODE: 32506 LATITUDE/LONGITUDE: 30.440372, -8781494

LANDSCAPING, FINAL TURF, MISC.

THE PROJECT INCLUDES CONSTRUCTION OF A NEW ALDI GROCERY STORE WITH A PARKING LOT AND ASSOCIATED UNDERGROUND LITHLITIES AND STORMWATER MANAGEMENT.

TENTATIVE CONSTRUCTION SCHEDULE (OPERATOR SHOULD OWNER'S REPRESENTATIVE)	PROVIDE ESTIMATED CONSTRUCTION SCHEDULE TO THE
CONSTRUCTION ACTIVITIES:	ESTIMATED DATES OF SOIL DISTURBANCE ACTIVITIE
CLEARING AND GRUBBING OPERATIONS, GRADING	SEPTEMBER 2021 - NOVEMBER 2021
CURB & GUTTER/SIDEWALK	APRIL 2022 – MAY 2022
PAVING	APRIL 2022 – MAY 2022
LANDSCAPING, FINAL TURF, MISC.	JUNE 2022 – JULY 2022

PRE-CONSTRUCTION IMPERVIOUS SURFACE AND DISTURBED AREA CALCULATIONS MINIMUM AREA REQUIRING DEP PERMIT = 1.00 ACRES TOTAL AREA TO BE DISTURBED = 2.5 ACRES

AN FL DEP NPDES PERMIT IS REQUIRED FOR THIS PROJECT IMPERVIOUS AREA: PRE-CONSTRUCTION = 0.16 ACRES

POST-CONSTRUCTION = 1.74 ACRES NET INCREASE OF IMPERVIOUS AREA = 1.58 ACRES

CONTACT INFORMATION/RESPONSIBLE PARTIES

THE OWNER OWNS THE LAND, ADJACENT ROADS, AND EASEMENT AREAS ASSOCIATED WITH THE PROJECT. THE OWNER IS THE OWNER CO-PERMITTEE APPLYING FOR PERMIT COVERAGE AND WILL BE RESPONSIBLE FOR COMPLIANCE WITH ALL TERMS AND CONDITIONS OF THE PERMIT INCLUDING DEVELOPING THIS SWPPP AND THE LONG-TERM MAINTENANCE PLAN OF THE PERMANENT STORMWATER MANAGEMENT SYSTEM FOR THIS PROJECT (IF APPLICABLE). THE OWNER WILL ENSURE THAT THE DESCRIBED WORK IN THE SWPPP IS BEING COMPLETED BY THE OPERATOR PERMITTEE.

OWNER/PERMITTEE:

ALDI, INC. (SPENCER SCHIMMEL, DIRECTOR OF REAL EASTATE) 2080 ALDI BOULEVARD

MT. JULIET, TN 37122 615.449.8840 / SPENCER.SCHIMMEL@ALDI.US

THE PRIMARY CONTRACTOR WILL ENTER INTO A CONTRACT WITH THE OWNER TO COMPLETE THE REQUIRED WORK FOR THIS PROJECT. THE PRIMARY CONTRACTOR WILL BECOME (UNDER CONTRACT) THE OPERATOR CO-PERMITTEE ON THE NPDES PERMIT (THROUGH EXECUTION OF A NPDES PERMIT MODIFICATION FORM). AND THEREBY AGREE TO IMPLEMENT THIS SWPPP IN COOPERATION WITH THE OWNER. THE OPERATOR IS RESPONSIBLE FOR IDENTIFYING AN EROSION CONTROL SUPERVISOR PRIOR TO STARTING CONSTRUCTION (REFER TO SWPPP AMENDMENT SECTION).

THE OPERATOR WILL ENSURE THAT INDIVIDUALS OVERSEEING OR IMPLEMENTING THE SWPPP HAVE BEEN PROPERLY TRAINED AND THAT CERTIFICATIONS WILL BE MADE AVAILABLE UPON REQUEST. THIS INCLUDES ANY SUB-CONTRACTORS THAT THE OPERATOR EMPLOYS UNDER SEPARATE CONTRACT. THE OPERATOR WILL PROVIDE THE CONTACT INFORMATION FOR THE EROSION CONTROL SUPERVISOR, SITE SUPERINTENDENT/FOREMAN. AND BMP INSTALLERS. THE EROSION CONTROL SUPERVISOR SHALL BE A RESPONSIBLE EMPLOYEE OF THE PRIME CONTRACTOR AND/OR DULY AUTHORIZED BY THE PRIME CONTRACTOR TO REPRESENT THE PRIME CONTRACTOR ON ALL MATTERS PERTAINING TO THE NPDES CONSTRUCTION STORMWATER PERMIT COMPLIANCE. THE EROSION CONTROL SUPERVISOR SHALL HAVE AUTHORITY OVER ALL OPERATOR ACTIVITIES WHICH INFLUENCE NPDES PERMIT COMPLIANCE, INCLUDING GRADING, EXCAVATION, UTILITY WORK, CLEARING/GRUBBING, DEWATERING, AND ANY OTHER OPERATION THAT INCREASES THE EROSION POTENTIAL ON THE PROJECT.

THE OPERATOR WILL PERFORM A PRECONSTRUCTION SITE VISIT TO ADDRESS ANY AREAS OF CONCERN PERTAINING TO ENVIRONMENTAL COMPLIANCE. THE OPERATOR WILL IMPLEMENT AND MAINTAIN BMPS FOR THE DURATION OF CONSTRUCTION PROJECT. THE OPERATOR WILL COMPLETE THE REQUIRED SITE INSPECTIONS, AND IS RESPONSIBLE TO REMAIN IN COMPLIANCE WITH NPDES PERMIT.

OPERATOR/PERMITTEE: (TO BE DETERMINED AND IDENTIFIED THROUGH TRANSFER OF NPDES-CSW PERMIT)

ISG INC. (ANDY BRANDEL) 7900 INTERNATIONAL DR., SUITE 550 MINNEAPOLIS, MN 55425 952-426-0699/ANDY.BRANDEL@ISGINC.COM

MAINTENANCE STANDARDS

PERMENANT STORMWATER MANAGEMENT SYSTEM: ISG INC. (ANDY BRANDEL) 7900 INTERNATIONAL DR., SUITE 550 MINNEAPOLIS, MN 55416

952-426-0699/ANDY.BRANDEL@ISGINC.COM

CONSTRUCTION ACTIVITY REQUIREMENTS: SEDIMENT CONTROL PRACTICES, PROCEDURES, &

DOWNGRADIENT SYSTEMS: IF THE DOWNGRADIENT TREATMENT SYSTEM IS OVERLOADED, ADDITIONAL UP GRADIENT SEDIMENT CONTROL PRACTICES OR REDUNDANT BMPS MUST BE INSTALLED TO ELIMINATE THE OVERLOADING, AND THE SWPPP MUST BE AMENDED TO IDENTIFY THESE ADDITIONAL PRACTICES.

<u>PERIMETER CONTROL BMPS (SILT FENCES, CHIP/SLASH MULCH SACKS, BIOROLLS, FLOATING SILT CURTAIN, ETC.)</u> PERIMETER CONTROL BMPS SHALL BE INSTALLED ON ALL DOWNGRADIENT PERIMETERS AND UPGRADIENT OF ANY BUFFER AREAS, PRIOR TO INITIATING UPGRADIENT LAND DISTURBANCE ACTIVITIES, UPLAND PERIMETER CONTROLS BMPS SHALL BE PLACED AS CLOSE AS POSSIBLE TO FOLLOW A SINGLE CONTOUR ELEVATION. ALL PERIMETER CONTROL DEVICES MUST BE REPAIRED, REPLACED, OR MAINTAINED WHEN THEY BECOME NONFUNCTIONAL OR THE SEDIMENT REACHES 1/2 OF THE HEIGHT OF THE DEVICE. FLOATING SILT CURTAIN SHALL BE INSTALLED AS CLOSE TO THE SHORELINE AS POSSIBLE FOR SHORELAND/IN-WATER SHORT-TERM CONSTRUCTION ACTIVITIES. IMMEDIATELY AFTER THE SHORT-TERM ACTIVITY IN THAT AREA IS COMPLETE, AN UPLAND PERIMETER CONTROL MUST BE INSTALLED IF EXPOSED SOILS CONTINUE TO DRAIN TO THE SURFACE WATER.

TEMPORARY SEDIMENTATION BASINS: WHERE TEN (10) OR MORE ACRES OF DISTURBED SOIL DRAIN TO A COMMON LOCATION. A TEMPORARY SEDIMENT BASIN MUST BE PROVIDED PRIOR TO RUNOFF LEAVING THE CONSTRUCTION SITE OR ENTERING SURFACE WATERS, ALL TEMPORARY BASINS SHALL BE CONSTRUCTED AND OPERATIONAL PRIOR TO GRADING TEN (10) OR MORE ACRES. BASINS MUST PROVIDE A LIVE STORAGE VOLUME FROM A TWO YEAR 24-HOUR STORM EVENT FROM EACH ACRE (DISTURBED AND UNDISTURBED) DRAINING TO THE BASIN OR 1.800 CUBIC FEET OF LIVE STORAGE PER ACRE DRAINED, WHICHEVER IS GREATER. AT A MINIMUM, IF CALCULATIONS ARE NOT PERFORMED THE BASIN SHALL PROVIDE 3,600 CUBIC FEET OF LIVE STORAGE FROM EACH ACRE. THE BASIN INTAKE MUST BE DESIGNED TO WITHDRAW WATER FROM THE SURFACE, PREVENT SHORT CIRCUITING AND THE DISCHARGE OF FLOATING DEBRIS, INCLUDE AN EMERGENCY OVERFLOW ABOVE THE LIVE STORAGE ELEVATION, AND PROVIDE ENERGY DISSIPATION AT THE BASIN OUTLET. BASINS MUST BE DRAINED AND SEDIMENT REMOVED WHEN THE DEPTH OF COLLECTED SEDIMENT IN THE BASIN REACHES 1/2 THE LIVE STORAGE VOLUME. IF A BASIN IS INFEASIBLE WITHIN THE PROJECT LIMITS. EQUIVALENT SEDIMENT CONTROL BMPS MUST BE IMPLEMENTED AND DOCUMENTED IN THE SWPPP OR SWPPP AMENDMENT.

TEMPORARY STOCKPILES: ALL STOCKPILES MUST HAVE SILT FENCE OR EQUIVALENT PERIMETER SEDIMENT CONTROLS IMPLEMENTED AND MAINTAINED AT ALL TIMES, PILES CANNOT BE PLACED IN BUFFER AREAS OR SURFACE WATERS, INCLUDING STORMWATER CONVEYANCES SUCH AS CURB AND GUTTER SYSTEMS. OR CONDUITS AND DITCHES UNLESS THERE IS A BYPASS IN PLACE TO PREVENT STORMWATER RUN-ON INTO THE STOCKPILE. STABILIZATION ON TEMPORARY STOCKPILES WITHOUT SIGNIFICANT SILT, CLAY OR ORGANIC COMPONENTS IS NOT REQUIRED.

CONSTRUCTION SITE ENTRANCE/VEHICLE TRACKING: OPERATOR MUST MINIMIZE SEDIMENT FROM LEAVING THE CONSTRUCTION SITE (OR ONTO STREETS WITHIN THE SITE) BY IMPLEMENTING BMPS SUCH AS ROCK PADS, SLASH MULCH, CONCRETE OR STEEL WASH RACKS, OR EQUIVALENT SYSTEMS. STREET SWEEPING MUST BE USED DAILY DURING CONSTRUCTION OPERATIONS IF SUCH BMPS ARE NOT ADEQUATE TO PREVENT SEDIMENT FROM BEING TRACKED ONTO THE STREET. TRACKED SEDIMENT MUST BE REMOVED FROM ALL PAVED SURFACES (ON AND OFF-SITE) WITHIN 24 HOURS OF DISCOVERY, OR SOONER AS DIRECTED BY THE PROJECT OWNER. MULTIPLE STREET SWEEPINGS AT THE OPERATOR'S EXPENSE MAY BE REQUIRED ON ALL ENTRY/EXIT POINTS TO THE SITE AT THE DISCRETION OF THE

SURFACE WATERS: INCLUDING OFF-SITE AND DOWNSTREAM DRAINAGE DITCHES, CATCH BASINS, AND CONVEYANCE SYSTEMS, MUST BE INSPECTED FOR EVIDENCE OF EROSION AND SEDIMENT DEPOSITION. THE REMOVAL AND STABILIZATION OF EXPOSED SOILS MUST TAKE PLACE WITHIN SEVEN (7) DAYS OF DISCOVERY UNLESS PRECLUDED BY LEGAL REGULATORY, OR PHYSICAL ACCESS CONSTRAINTS. IF PRECLUDED, REMOVAL AND STABILIZATION MUST TAKE PLACE WITHIN SEVEN (7) CALENDAR DAYS OF OBTAINING ACCESS. THE PERMITTEES ARE RESPONSIBLE FOR CONTACTING ALL LOCAL, REGIONAL, STATE AND FEDERAL AGENCIES AND RECEIVING ANY APPLICABLE PERMITS, PRIOR TO CONDUCTING ANY WORK.

INLET PROTECTION: ALL STORM DRAIN INLETS (INCLUDING DOWNGRADIENT, OFF-SITE) MUST BE PROTECTED BY APPROPRIATE BMPS DURING CONSTRUCTION UNTIL ALL SOURCES WITH POTENTIAL FOR DISCHARGING TO THE INLET HAVE BEEN STABILIZED. SILT FENCE IS NOT AN ACCEPTABLE CATCH BASIN INLET PROTECTION BMP. CONTACTOR SHALL CLEAN, REMOVE AND DISPOSE OF SEDIMENT, AND/OR REPLACE STORM DRAIN INLET PROTECTION ON A ROUTINE BASIS TO ENSURE THE DEVICE IS FULLY FUNCTIONAL PRIOR TO THE NEXT FORECASTED PRECIPITATION EVENT (30% OR GREATER) INLET PROTECTION MAY BE REMOVED FOR A PARTICULAR INLET IF A SPECIFIC SAFETY CONCERN (STREET FLOODING/FREEZING) HAS BEEN IDENTIFIED BY THE PERMITTEE(S) OR THE JURISDICTIONAL AUTHORITY (E.G. CITY/COUNTY/TOWNSHIP). WRITTEN CORRESPONDENCE REGARDING THE NEED FOR REMOVAL MUST BE DOCUMENTED

<u>DEWATERING, STREAM DIVERSION, AND BASIN DRAINING</u>
DEWATERING, STREAM DIVERSION, OR BASIN DRAINING IS NOT ANTICIPATED DURING CONSTRUCTION OF THIS PROJECT.

PERMANENT WATER QUALITY VOLUME FROM THE NET NEW IMPERVIOUS SURFACES OF THE PROJECT IS PROVIDED IN THE PROPOSED INFILTRATION BASIN. HYDROLOGIC AND WATER QUALITY MODELING DATA IS AVAILABLE UPON REQUEST, THE SITE IS ABLE TO MEET THE FULL VOLUME REDUCTION REQUIREMENT. INFILTRATION RATES WERE DETERMINED BY THE INFILTRATION RATE CHART IN THE FDOT DRAINAGE DESIGN GUIDE TABLE J-1 UTILIZING SOIL-

EXISTING SITE CONDITIONS, SOILS, & WATER RESOURCES

OILS AND NATIVE TOPSOIL: NATIVE TOPSOIL WILL BE STRIPPED AND STOCKPILED FOR FINAL GRADING OPERATIONS WHERE INDICATED IN THE CONSTRUCTION PLANS AND SPECIFICATIONS. METHODS AND EQUIPMENT TO MINIMIZE SOIL COMPACTION (IN PROPOSED INFILTRATION AREAS, DRIP LINE OF TREES TO BE PRESERVED, ETC.) SHALL BE DETERMINED BY THE OPERATOR'S SWPPP AMENDMENT. TRACKED VEHICLES ARE PREFERRED AND WHEELED VEHICLES ARE DISCOURAGED IN THESE AREAS. THE FOLLOWING USDA-NRCS MAPPED SOILS ARE SHOWN AS "NOT HIGHLY ERODIBLE" ON THE COUNTY SOIL SURVEY MAP.

USDA-NRCS MAPPED SOIL SURVEY UNIT NO., NAME.	PERCENTAGE	APPROXIMATE	PARTICLE SIZE RA	INGE (MM)
TEXTURE, SLOPE PERCENTAGE	OF PROJECT AREA	SAND (0.05- 2.00+)	SILT (0.002- 0.05)	CLAY (<0.002)
38 - BONIFAY LOAMY SAND, 0-5% SLOPES	100%	70-85%	0-30%	10-15%

DESCRIPTION OF RECEIVING WATERS (LOCATED WITHIN 1-MILE): STORMWATER FROM APPROXIMATELY HALF OF THE PROJECT WILL BE CONVEYED INTO THE ON-SITE INFILTRATION BASIN AND THE OTHER HALF IS CONVEYED VIA ON SITE STORM SEWER. THERE ARE 2 DISCHARGE POINTS LEAVING THE SITE TO THE WEST AND NORTH. THE WEST DISCHARGE POINT IS AT LAT/LONG. 30.440460, -87.282137 AND THE NORTH DISCHARGE POINT IS AT LAT/LONG. 30.441346, -87.281926. HYDROLOGIC AND WATER QUALITY MODELING DATA IS AVAILABLE UPON REQUEST.

POTENTIAL FOR SEDIMENT AND/OR OTHER POLLUTANT(S) DISCHARGING FROM THE PROJECT SITE THE TEMPORARY EROSION AND SEDIMENT CONTROL BMPS IN THIS SWPPP HAVE BEEN DESIGNED TO MINIMIZE THE POTENTIAL OF SEDIMENTS DISCHARGING OFF-SITE FROM A 0.5 INCH RAINFALL WITHIN A 24 HOUR PERIOD. THE FDOT IDF CURVES ESTIMATE FOR THE PROJECT LOCATION WAS REVIEWED AND USED FOR ANTICIPATED INSPECTION FREQUENCY. BMP DESIGN, AND ESTIMATING CONSTRUCTION ACTIVITIES IN THIS SWPPP.

ROUTINE INSPECTION AND BMP MAINTENANCE BY THE OPERATOR IS CRUCIAL IN ENSURING THE FUNCTIONALITY OF

CONSTRUCTION PHASING/STAGING, BUFFERS, & AREAS NOT TO BE DISTURBED

THERE IS NO CONSTRUCTION PHASING OR STAGING DEFINED BY THE OWNER FOR THIS PROJECT. THE SCHEDULE FOR INSTALLING TEMPORARY BMPS SHALL BE INCORPORATED INTO THE OPERATOR'S WEEKLY SCHEDULE FOR EACH CONSTRUCTION STAGE AND PRESENTED TO THE OWNER'S REPRESENTATIVE.

STEEP SLOPES: EXISTING AND PROPOSED SLOPES 1 IN 3 (33.33%) AND STEEPER THAT ARE PROPOSED TO BE DISTURBED ARE ILLUSTRATED ON THE PLAN SHEETS. STEEP SLOPES MAY BE TEMPORARILY CREATED DURING GRADING OPERATIONS IF NECESSARY, AT WHICH TIME TEMPORARY BMPS MUST BE IMPLEMENTED BY THE OPERATOR (THROUGH AN APPROVED SWPPP AMENDMENT) WITHIN 7 DAYS OF NO LONGER WORKING THE STEEP SLOPE.

CONTAMINATED PROPERTIES: PHASE II ENVIRONMENTAL ASSESSMENT HAS BEEN COMPLETED FOR THE PROJECT (JULY 2018- AVAILABLE UPON REQUEST). NO HAZARDOUS MATERIALS OR WASTES ARE ANTICIPATED TO BE FOUND ONSITE.

STORMWATER POLLUTION MITIGATION MEASURES (AS IDENTIFIED FROM ENVIRONMENTAL REVIEW): ENVIRONMENTAL REVIEW IDENTIFIED NO STORMWATER POLLUTION MITIGATION MEASURES TO BE UTILIZED FOR THIS PROJECT.

KARST AREAS: THERE ARE NO KNOWN ACTIVE KARST AREAS WITHIN OR ADJACENT TO THE PROJECT LIMITS.

WETLANDS: NO WETLANDS EXIST WITHIN OR IMMEDIATELY ADJACENT TO THE PROJECT LIMITS.

SEQUENCE OF CONSTRUCTION/TIMING OF BMP INSTALLATION

NO CONSTRUCTION OPERATIONS, INCLUDING REMOVALS, THAT REQUIRE EROSION & SEDIMENT CONTROL PER THE SWPPP CAN COMMENCE UNTIL THE OPERATOR'S EROSION CONTROL SUPERVISOR CERTIFIES THE PROPER INSTALLATION OF BMP'S AND A CHAIN OF RESPONSIBILITY FOR SWPPP IMPLEMENTATION IS CREATED FOR ALL OPERATORS ON THE SITE. PERIMETER SEDIMENT CONTROLS (SILT FENCE, INLET PROTECTION, CONSTRUCTION ENTRANCES, ETC.) SHALL BE INSTALLED PRIOR TO THE START OF CONSTRUCTION. THESE PRACTICES SHALL REMAIN IN PLACE UNTIL FINAL STABILIZATION IS ACHIEVED. OPERATOR SHALL IMPLEMENT THE NECESSARY ON SITE BMP'S IN ACCORDANCE WITH THE NPDES PERMIT REQUIREMENTS TO PREVENT NUISANCE CONDITIONS FROM ANY DISCHARGES UNDER COVERAGE OF THE NPDES PERMIT. IN SOME CASES, MULTIPLE OR REDUNDANT APPLICATIONS OF SOME BMP'S MAY BE NEEDED TO MEET THESE REQUIREMENTS.

INSPECTION PROCEDURES, SWPPP AMENDMENTS, RECORD KEEPING, & TRAINING THE SWPPP MUST BE AMENDED BY THE OPERATOR WHEN THE IDENTITY OF THE RESPONSIBLE SITE OPERATORS (EROSION CONTROL SUPERVISOR, SUB-CONTRACTORS, ETC.) ARE KNOWN.

2. THE OPERATOR MUST INSPECT THE ENTIRE CONSTRUCTION SITE AT LEAST ONCE EVERY SEVEN (7) DAYS DURING ACTIVE CONSTRUCTION AND WITHIN 24 HOURS AFTER A RAINFALL EVENT GREATER THAN 0.5 INCHES IN 24 HOURS.

PERMIT TERMINATION CONDITIONS

N CONDITIONS ARE ACHIEVED WHEN THE FOLLOWING PARAMETERS ARE COMPLETED, PRIOR TO SUBMISSION OF THE NOTICE OF TERMINATION TO FL DEP.

- 70% VEGETATIVE COVER: ALL SOIL DISTURBING ACTIVITIES AT THE SITE HAVE BEEN COMPLETED AND ALL EXPOSED SOILS ARE STABILIZED BY A UNIFORM, LIVE PERENNIAL VEGETATIVE COVER WITH A DENSITY OF 70% OVER THE ENTIRE PERVIOUS SURFACE AREA, OR OTHER EQUIVALENT MEANS NECESSARY TO PREVENT SOIL FAILURE UNDER
- FINAL CLEAN OUT OF PERMANENT STORMWATER MANAGEMENT SYSTEMS & CONVEYANCE SYSTEMS: ALL ACCUMULATED SEDIMENT MUST BE REMOVED FROM PERMANENT STORMWATER MANAGEMENT SYSTEMS. CONVEYANCE SYSTEMS, AND DITCHES MUST BE STABILIZED WITH PERMANENT COVER. ALL SYSTEMS MUST
- REMOVAL OF ALL TEMPORARY SYNTHETIC BMPS: ALL TEMPORARY SYNTHETIC AND STRUCTURAL EROSION PREVENTION AND SEDIMENT CONTROL BMPS (SUCH AS SILT FENCE) MUST BE REMOVED ON THE PORTIONS OF THE SITE FOR WHICH THE PERMITTEE IS RESPONSIBLE. BMPS DESIGNED TO DECOMPOSE ON SITE (SUCH AS SOME COMPOST LOGS) MAY BE LEFT IN PLACE.
- 4. ALL DEWATERING DISCHARGES AUTHORIZED BY THIS PERMIT HAVE CEASED.
- 5. ALL CONTRUCTION ACTIVITY DISCHARGES AUTHORIZED BY THIS PERMIT HAVE CEASED.

THE CO-PERMITTEES (OWNER AND OPERATOR) MUST SIGN AND SUBMIT THE COMPLETED NOT TO THE FL DEP WITHIN 14 DAYS AFTER SELLING/LEGALLY TRANSFERRING THE PROPERTY OR FINAL STABILIZATION IS ACHIEVED.

THE OPERATOR SHALL PROVIDE A RAINFALL GAUGE ON-SITE, WITHIN ONE MILE OF THE SITE, OR SOURCE OF THE WEATHER REPORTING SYSTEM THAT USES SITE SPECIFIC RAINFALL DATA FROM RADAR SUMMARIES. THE LOCATION AND SOURCE OF THE RAINFALL GAUGE OR REPORTING SYSTEM MUST BE DOCUMENTED IN THE FIRST SWPPP INSPECTION REPORT. THE INSPECTION FREQUENCY MAY BE REDUCED TO ONCE PER MONTH OR SUSPENDED. IF SITE CONDITIONS MEET ITEMS 6.5 OF THE NPDES PERMIT. ALL INSPECTIONS AND MAINTENANCE CONDUCTED MUST BE RECORDED IN WRITING BY THE OPERATOR AND RETAINED WITH THE SWPPP. RECORDS OF EACH INSPECTION AND MAINTENANCE ACTIVITY SHALL INCLUDE:

A. DATE, TIME, AND NAME OF PERSON(S) CONDUCTING INSPECTIONS: B. FINDINGS OF INSPECTIONS, INCLUDING RECOMMENDATIONS FOR CORRECTIVE ACTIONS: C. CORRECTIVE ACTIONS TAKEN (INCLUDING DATES, TIMES, AND PARTY COMPLETING MAINTENANCE ACTIVITIES);

- INCLUDING DOCUMENTATION/PHOTOS OF IMPLEMENTED BMPS INTENDED TO CORRECT A PROBLEM BUT FAILED. D. DATE AND AMOUNT OF ALL RAINFALL EVENTS GREATER THAN 0.5 INCHES IN 24 HOURS; E. DOCUMENTATION OF CHANGES MADE TO THE SWPPP.
- SWPPP AMENDMENTS AND SITE PLANS WILL BE PREPARED BY THE OPERATOR AND SUBMITTED TO THE OWNER FOR REVIEW AND WRITTEN APPROVAL BY THE PROJECT OWNER (OR DESIGNATED REPRESENTATIVE). ALL OWNER ACCEPTED AND DENIED SWPPP AMENDMENTS AND SITE PLANS MUST BE RECORDED IN WRITING AND RETAINED
- 4. THE SWPPP SHALL BE AMENDED TO INCLUDE ADDITIONAL OR MODIFIED BMPS, DESIGNED TO CORRECT IDENTIFIED PROBLEMS OR ADDRESS SITUATIONS PRIOR TO CONDUCTING SPECIFIC STAGES/PHASES OF THE PROJECT, AS REQUIRED BY THE OWNER AND DEFINED IN THIS PROJECT SWPPP.
- 5. THE SWPPP (ORIGINAL OR COPIES), ALL CHANGES TO THE SWPPP, PROJECT MANUAL, AND INSPECTIONS/MAINTENANCE RECORDS MUST BE KEPT AT THE SITE DURING CONSTRUCTION BY THE OPERATOR WHO HAS OPERATIONAL CONTROL OF THAT PORTION OF THE SITE. THE SWPPP CAN BE KEPT IN THE FIELD OFFICE OR ON SITE VEHICLE DURING NORMAL WORKING HOURS. THE PERMITEES MUST KEEP AND MAKE AVAILABLE TO FEDERAL, STATE, AND LOCAL OFFICIALS WITHIN THREE DAYS THE SWPPP, OTHER STORMWATER RELATED PERMITS, RECORDS OF ALL INSPECTION/MAINTENANCE, ALL PERMANENT OPERATIONS AND MAINTENANCE AGREEMENTS, ALL REQUIRED CALCULATIONS FOR DESIGN OF THE TEMPORARY AND PERMANENT STORMWATER MANAGEMENT SYSTEMS AND OTHER INFORMATION REQUIRED BY THE GENERAL PERMIT FOR THREE YEARS FOLLOWING THE
- THE OPERATOR MUST ASSIGN A TRAINED INDIVIDUAL(S) TO OVERSEE THE IMPLEMENTATION, MAINTENANCE, AND REPAIR OF BMPS. THIS INDIVIDUAL(S) SHALL ALSO PERFORM INSPECTIONS, REVISE/AMEND THE SWPPP (DOCUMENT IN SWPPP AS NECESSARY) AND BE AVAILABLE FOR AN ONSITE INSPECTION WITHIN 72 HOURS UPON REQUEST BY THE PERMITTED OWNER (OR ITS DESIGNEE), LOCAL GOVERNMENT UNITS, OR FL DEP LEAD PROJECTS REQUIRE AVAILABLE ONSITE INSPECTION WITHIN 24 HOURS.

POLLUTION PREVENTION MANAGEMENT MEASURES

- POTENTIAL SOURCES OF POLLUTANTS FROM CONSTRUCTION ACTIVITIES INCLUDE: SEDIMENT AND FUGITIVE DUST GENERATED FROM CLEARING AND GRUBBING, IMPORT/EXPORT OPERATIONS, REMOVALS/COMPACTION, MASS/FINE GRADING, EXCAVATIONS, TRENCHING, TOPSOIL STRIPING STOCKPILING, WET/DRY PAVEMENT CUTTING, STREET CONSTRUCTION.
- BASIC/ACIDIC PH LEVELS FROM CURB AND GUTTER, MANHOLE STRUCTURES, SIDEWALKS, DRIVEWAY APRONS, FOUNDATIONS, BRIDGE ABUTMENTS, WET/DRY PAVEMENT CUTTING, MASONRY WASHOUT/CLEANOUT.
- EXCESS NUTRIENTS FROM LANDSCAPING INSTALLATIONS, SOIL ADDITIVES, FERTILIZATION, MULCHING HYDROCARBONS FROM STREET CONSTRUCTION, DEMOLITION/REMOVALS, WET/DRY PAVEMENT CUTTING

OPERATOR WILL COMPLY WITH ALL OF THE POLLUTION PREVENTION AND MANAGEMENT MEASURES IDENTIFIED IN THE NPDES-CSW PERMIT. OPERATOR WILL SUBMIT A SPILL PREVENTION AND RESPONSE PLAN (SPRP) TO THE ENGINEER PRIOR TO ANY CONSTRUCTION ACTIVITY. THE SPRP MUST SATISFACTORILY ADDRESS (AT A MINIMUM) THE FOLLOWING NPDES REQUIREMENTS BY THE PROPOSED IMPLEMENTATION AND MAINTENANCE OF APPROPRIATE BMPS:

NO-EXPOSURE: CONSTRUCTION AND BUILDING PRODUCTS (THAT HAVE THE POTENTIAL TO LEACH POLLUTANTS), PESTICIDES, HERBICIDES, INSECTICIDES, FERTILIZERS. TREATMENT CHEMICALS. AND LANDSCAPING MATERIALS MUST BE UNDER COVER (PLASTIC SHEETING OR TEMPORARY ROOFS) TO MINIMIZE CONTACT WITH STORMWATER AND

SOLID WASTE: (SEDIMENT, ASPHALT, CONCRETE MILLINGS, CONSTRUCTION, AND DEMOLITION DEBRIS) AND OTHER WASTES MUST BE DISPOSED OF PROPERLY AND SHALL COMPLY WITH FL DEP DISPOSAL REQUIREMENTS.

HAZARDOUS MATERIALS: (E.G. GAS, DIESEL, OIL, ANTIFREEZE, PAINT SOLVENTS, SOAPS, DETERGENTS, WOOD PRESERVATIVES, CLEANING SOLVENTS, CURING COMPOUNDS, ACIDS, ETC.) MUST BE STORED IN SEALED CONTAINERS. SECONDARY SPILL CONTAINMENT IS REQUIRED FOR ALL MATERIALS IF STORED ON-SITE FOR MORE THAN 24 CONSECUTIVE HOURS (DOUBLE WALLED TANKS ARE ACCEPTABLE FOR SECONDARY CONTAINMENT). STORAGE AND DISPOSAL OF HAZARDOUS WASTES AND MATERIALS MUST BE IN COMPLIANCE WITH FL DEP REGULATIONS.

PORTABLE TOILETS: MUST BE POSITIONED AND SECURED SO THEY ARE NOT TIPPED OR KNOCKED OVER. SANITARY WASTE MUST BE PROPERLY DISPOSED OF IN ACCORDANCE WITH FL DEP REGULATIONS.

SPILLED OR LEAKED CHEMICALS: REASONABLE STEPS TO PREVENT THE DISCHARGE OF SPILLED OR LEAKED CHEMICALS. NCLUDING FUEL, FROM ANY AREA WHERE CHEMICAL OR FUEL WILL BE LOADED OR UNLOADED. PROCEDURES FOR SPILL RESPONSE AND MATERIALS FOR CONTAINMENT, CLEANUP (DRIP PANS, ABSORBENTS, AND SPILL KITS) AND APPROPRIATE DISPOSAL SHALL BE AVAILABLE AT ALL TIMES ON-SITE. PERMITEES MUST REPORT AND CLEAN UP SPILLS IMMEDIATELY.

EQUIPMENT/VEHICLE WASHING: WHEN VEHICLE/EQUIPMENT WASHING MUST OCCUR ON-SITE, THE ACTIVITY IS LIMITED TO A CONTAINED PORTION OF THE STAGING AREA, UNLESS INFEASIBLE THROUGH A SWPPP AMENDMENT. SOAPS, DETERGENTS, AND SOLVENTS ARE TO BE USED AND STORED PROPERLY, RUNOFF MUST BE CONTAINED FROM THE WASHING AREAS AND DISPOSED OF PROPERLY.

CONCRETE, STUCCO, PAINT, CURING COMPOUNDS, SOLVENTS, AND OTHER WASHOUT WASTES: TEMPORARY OR LONG-TERM STORAGE OF WASHOUT WASTE IS PROHIBITED ON-SITE (SLURRY MUST BE HAULED IMMEDIATELY OFF-SITE). OPERATOR MUST SUBMIT A CONCRETE WASHOUT PLAN TO THE PROJECT ENGINEER FOR APPROVAL OF ALL ON-SITE WASHOUT LOCATIONS. ON-SITE WASHOUT LOCATIONS MUST BE LOCATED 200 FEET FROM AN ENVIRONMENTALLY SENSITIVE AREA AND SURFACE WATERS. HAVE "CONCRETE WASHOUT AREA" SIGNAGE. AND BE CONTAINED IN A LEAK PROOF CONTAINER OR IMPERMEABLE LINER. LIQUID AND SOLID WASTES SHOULD NOT CONTACT THE GROUND (UNLESS PERMITTED IN THE CONCRETE WASHOUT PLAN), BE CONTAINED TO PREVENT RUNOFF FROM THE WASHOUT LOCATION, AND MUST BE DISPOSED OF PROPERLY AND IN COMPLIANCE WITH FL DEP REGULATIONS.

BURNING: BURNING OF GARBAGE, CONSTRUCTION DEBRIS, TREES, BRUSH, OR OTHER VEGETATIVE MATERIAL IS NOT LLOWED ON SITE, UNLESS PRIOR APPROVAL IS GRANTED BY THE OWNER.

CONSTRUCTION ACTIVITY REQUIREMENTS: EROSION PREVENTION PRACTICES, PROCEDURES, & MAINTENANCE STANDARDS THE OPERATOR IS RESPONSIBLE FOR THE INSTALLATION, OPERATION, AND CONTINUED MAINTENANCE OF ALL TEMPORARY AND PERMANENT WATER QUALITY MANAGEMENT BMPS, AS WELL AS ALL EROSION PREVENTION AND SEDIMENT CONTROL BMPS. FOR THE DURATION OF THE CONSTRUCTION WORK AT THE SITE. UNTIL FINAL STABILIZATION

EROSION FROM A MINIMUM 0.5 INCH TOTAL RAINFALL EVENT WITHIN 24 HOURS. ALL NONFUNCTIONAL BMPS MUST BE REPAIRED, REPLACED, OR SUPPLEMENTED WITH FUNCTIONAL BMPS BY THE END OF THE NEXT BUSINESS DAY AFTER DISCOVERY. OR AS SOON AS FIELD CONDITIONS ALLOW ACCESS UNLESS ANOTHER TIME FRAME IS SPECIFIED IN THE SWPPP. ALL ERODED MATERIAL THAT LEAVES THE SITE SHALL BE COLLECTED BY THE

OPERATOR AND RETURNED TO THE SITE AT THE OPERATOR'S EXPENSE AND INCIDENTAL TO THE PROJECT COST.

IS ACHIEVED. ALL BMPS MUST BE ADEQUATELY LOCATED, DESIGNED, INSTALLED, AND MAINTAINED TO PREVENT

TEMPORARY OR PERMANENT STABILIZATION SHALL BE INITIATED <u>AS SOON AS POSSIBLE, BUT NO LATER THAN THE END OF THE NEXT WORK DAY</u> FOLLOWING THE DAY EARTH-DISTURBING ACTIVITIES IN THAT PORTION OF THE SITE HAS TEMPORARILY OF PERMANENTLY CEASED. ALL EXPOSED SOIL AREAS SHALL BE STABILIZED WITHIN <u>7 DAYS</u> AFTER THE CONSTRUCTION ACTIVITY IN THAT PORTION OF THE SITE HAS TEMPORARILY OR PERMANENTLY CEASED. INITIATED STABILIZATION IS DEFINED AS COMPLETING ONE (OR MORE) OF THE FOLLOWING: SOIL PREPARATION FOR VEGETATION, MULCHING (OR OTHER TEMPORARY NON-VEGETATIVE BMP), SEEDING/PLANTING, OR SCHEDULING STABILIZATION MEASURES TO BE FULLY INSTALLED AND COMPLETED WITHIN THE 7 DAY TIMEFRAME.

TEMPORARY STABILIZATION BMPS SHALL ONLY BE IMPLEMENTED WHEN PERMANENT STABILIZATION BMPS CANNOT BE IMPLEMENTED WITHIN THE 7 DAY TIMEFRAME FOR EXPOSED SOILS.

TEMPORARY/PERMANENT DRAINAGE DITCHES & SWALES: THE NORMAL WETTED PERIMETER (2-YEAR, 24-HOUR PRECIPITATION EVENT) OF ANY TEMPORARY OR PERMANENT DRAINAGE DITCH, CHANNEL, OR SWALE THAT DRAINS WATER FROM ANY PORTION OF THE CONSTRUCTION SITE OR DIVERTS WATER AROUND THE SITE MUST BE STABILIZED. WITHIN THE LAST 200 LINEAL FEET FROM THE PROPERTY EDGE, OR FROM THE POINT OF DISCHARGE INTO ANY SURFACE WATER WITHIN 24 HOURS OF CONNECTION. STABILIZATION REMAINING OF THE REMAINING PORTIONS OF THE CHANNEL MUST BE STABILIZED WITHIN 14 DAYS. ALL STORMWATER CONVEYANCE CHANNELS MUST USE EROSION CONTROL AND VELOCITY DISSIPATION DEVICES WITHIN AND ALONG THE LENGTH OF THE CHANNEL AND AT ANY OUTLETS. TEMPORARY OR PERMANENT DITCHES OR SWALES THAT ARE BEING USED AS A TEMPORARY SEDIMENT CONTAINMENT SYSTEM (WITH PROPERLY DESIGNED ROCK DITCH CHECKS, BIO ROLLS, SILT DIKES ETC.) DO NOT NEED TO BE STABILIZED. THESE AREAS HOWEVER MUST BE STABILIZED WITHIN 24 HOURS AFTER NO LONGER BEING USED AS A SEDIMENT CONTAINMENT SYSTEM, MULCH, HYDROMULCH, TACKIFIER, OR POLYARCRYLAMIDE BELOW THE WETTED PERIMETER OF A DITCH, SWALE, OR OTHER SURFACE WATER CONVEYANCE IS NOT ACCEPTABLE STABILIZATION.

EROSION CONTROL BLANKETS/MATS: OPERATOR SHALL VERIFY DURING REGULAR INSPECTIONS THAT NO GULLIES, RILLS, OR SCOUR HOLES HAVE FORMED UNDER EROSION CONTROL BLANKETS AND MATS. ALL REPAIRS MUST BE COMPLETED WITHIN 24 HOURS OF DISCOVERY, OR AS SOON AS FIELD CONDITIONS ALLOW ACCESS.

MULCH: OPERATOR MUST APPLY MULCH IN A UNIFORM PATTERN OVER THE DISTURBED SOILS, TO ACHIEVE A MINIMUM OF 90% GROUND COVER.

DUST CONTROL: DUST FROM THE SITE WILL BE CONTROLLED BY INCREASED STREET SWEEPING AND/OR USING A MOBILE PRESSURE-TYPE DISTRIBUTOR TRUCK TO APPLY POTABLE WATER TO DISTURBED AREAS. THE MOBILE UNIT WILL APPLY WATER AT A RATE NECESSARY TO PREVENT RUNOFF AND PONDING.

STORM SEWER OUTLETS: PIPE OUTLETS MUST HAVE TEMPORARY OR PERMANENT ENERGY DISSIPATION WITHIN 24 HOURS AFTER HYDRAULIC CONNECTION TO A RECEIVING SURFACE WATER.

TEMPORARY & PERMANENT EROSION PREVENTION BMPS
HYDRO-MULCH: HYDRAULIC SOIL STABILIZER IN COMBINATION WITH A TACKIFIER WILL BE INSTALLED PER MANUFACTURES SPECIFICATIONS TO EXPOSED SOILS AREAS TO PROVIDE TEMPORARY LONG-TERM OR PERMANENT COVER FOR VEGETATION ESTABLISHMENT.


Date: Issued: SITE PLAN REVIEW #1 05/18/21 SITE PLAN REVIEW #2 06/24/21 PERMIT/BID SET 07/28/21 FOR CONSTRUCTION 09/10/21 Revisions: Date:



Andrew [,] Brandel 09:32:17

B.M. ELEVATION = 72.38

CUT 'X' LOCATED IN SIDEWALK AT THE NE CORNER OF THE INTERSECTION OF MOBILE HWY AND EDISION DRIVE.

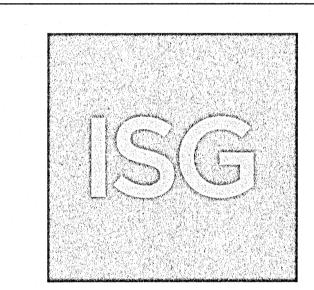

MANAGING LOCATION: MINNEAPOLIS / ST. PAUL OFFICE 7900 INTERNATIONAL DRIVE INTERNATIONAL PLAZA, SUITE 550 MINNEAPOLIS, MN 55425 PHONE: 952.426.0699



ALDI Inc. Store #: 156 PENSACOLA, FLORIDA 4830 MOBILE HIGHWAY

PENSACOLA, FLORIDA 32506 ESCAMBIA COUNTY

SITE EROSION


Project Name & Location:


ICONTROL NOTES


Drawing Name: ISG Project No. Type: V7.0 ER JMF Drawn By:


Reviewed By: RJA | Drawing No.


Designed By: JMF

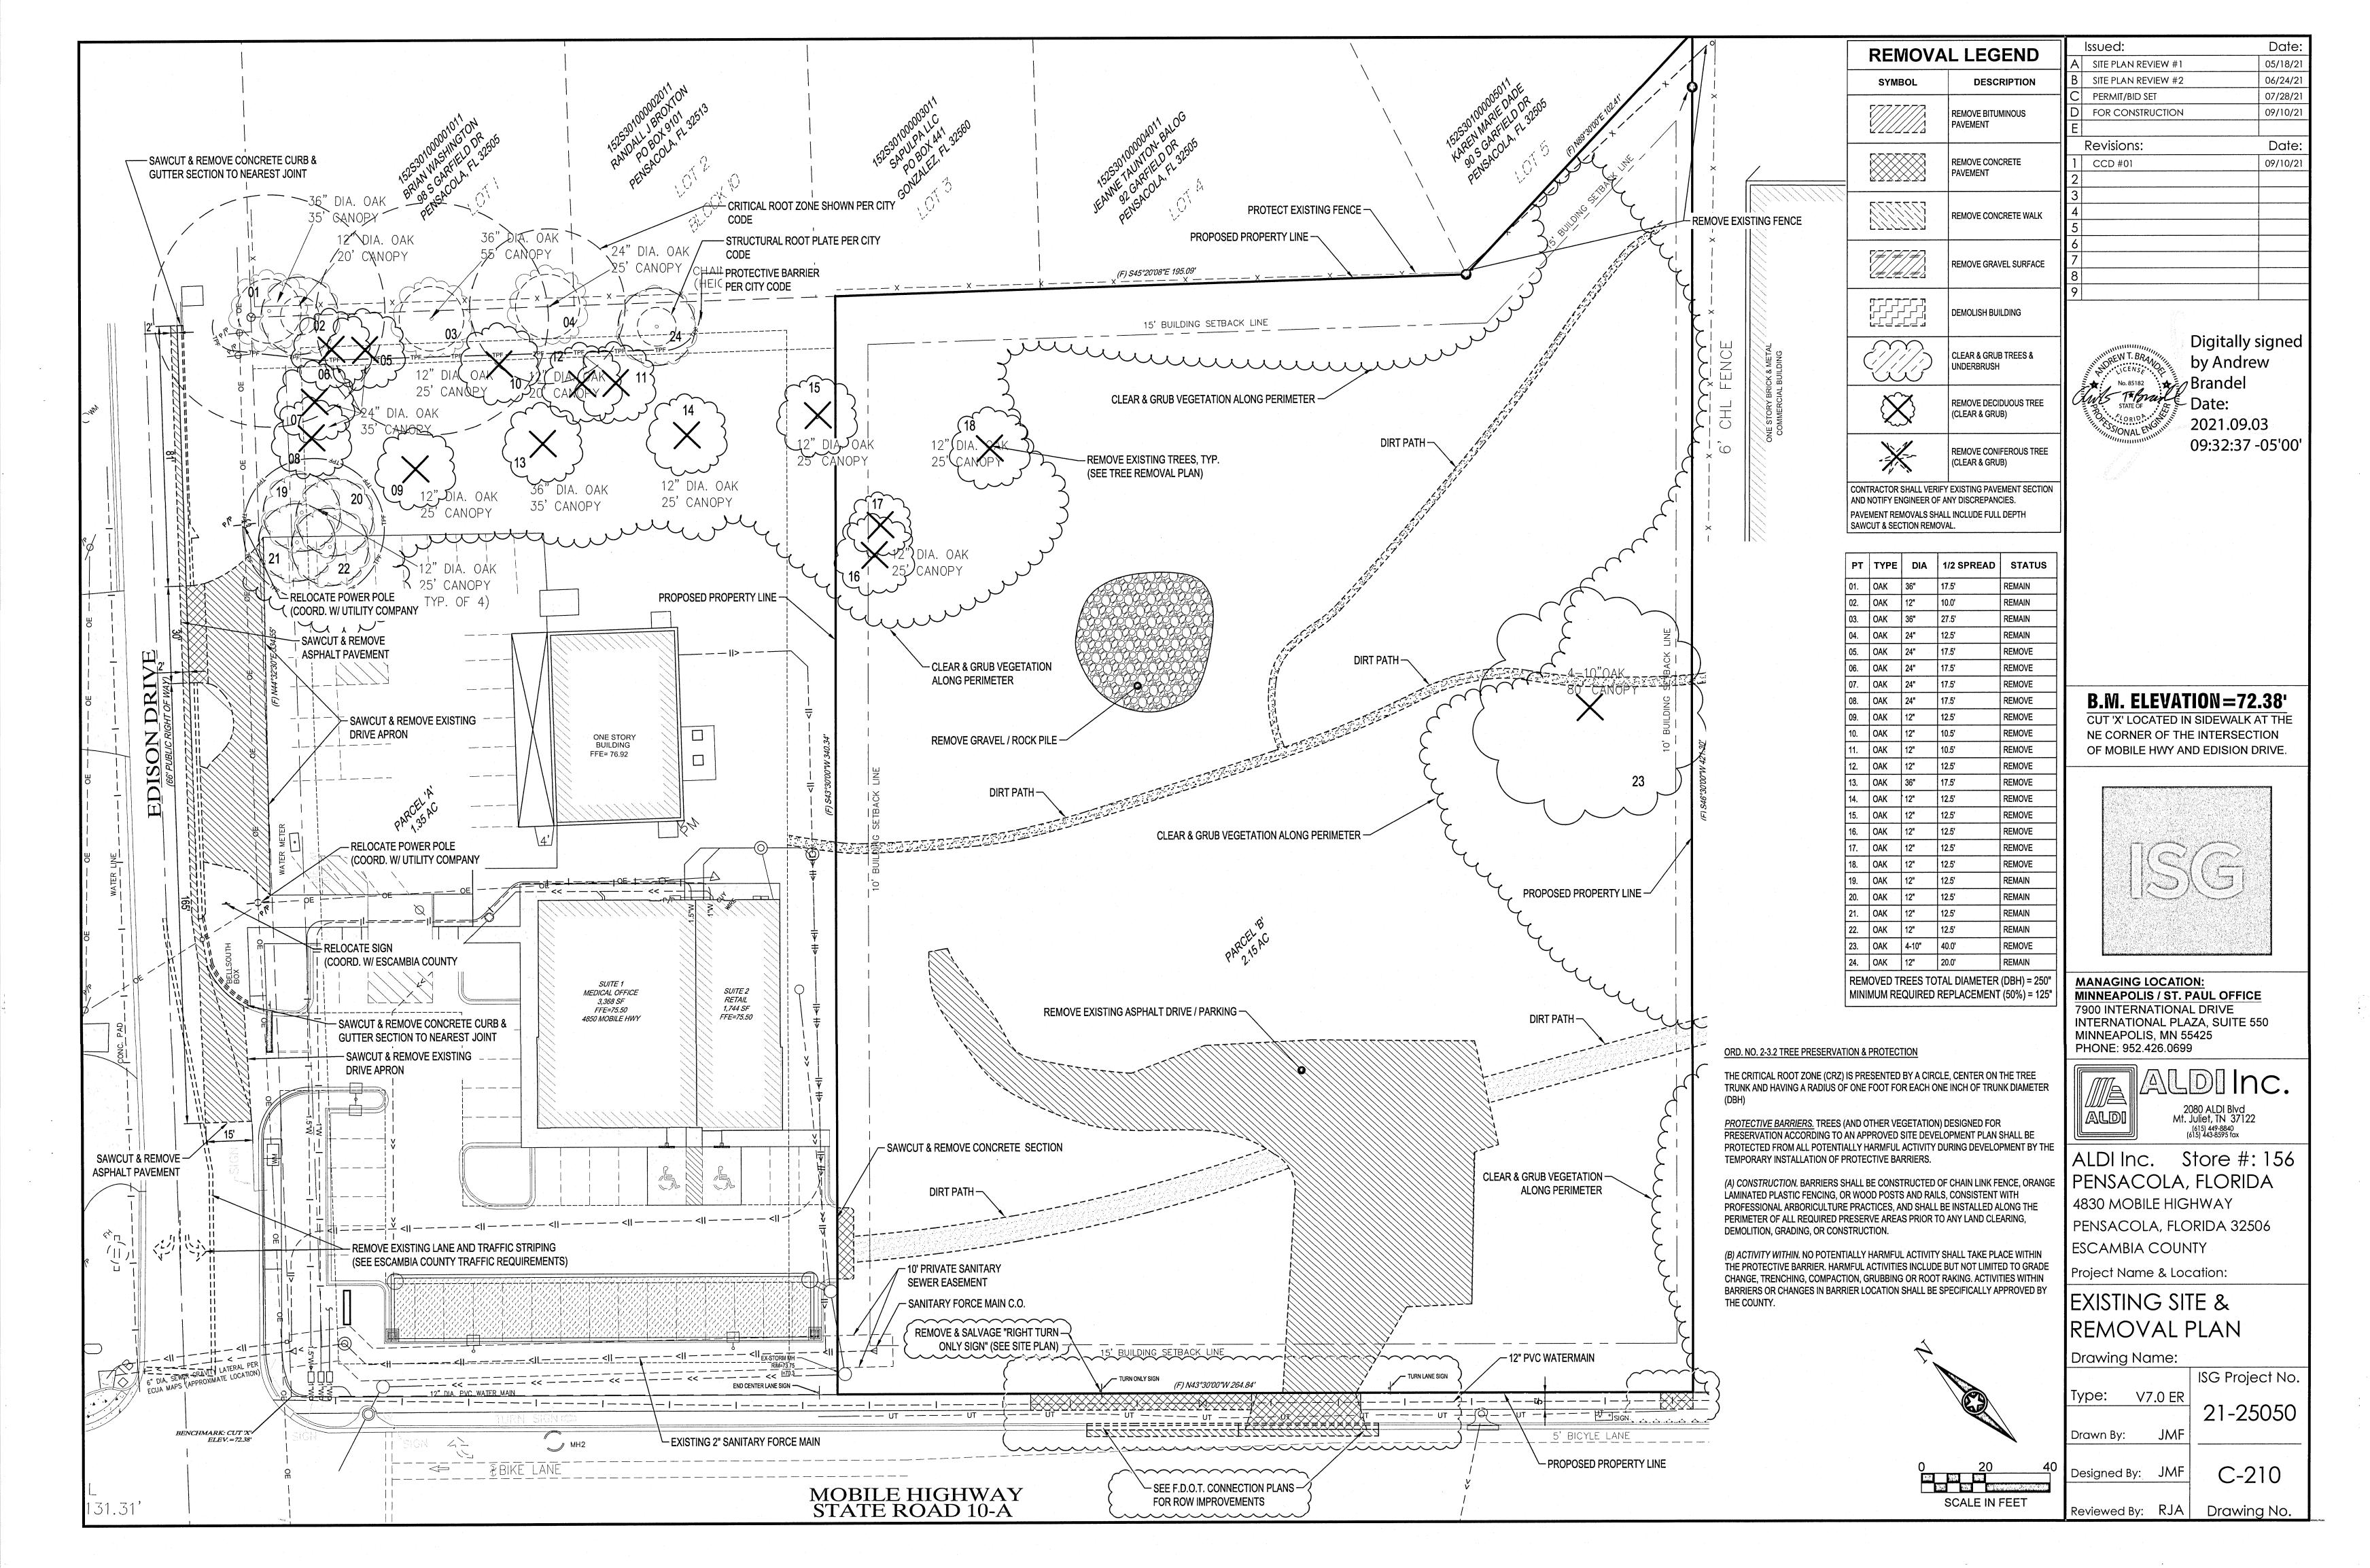


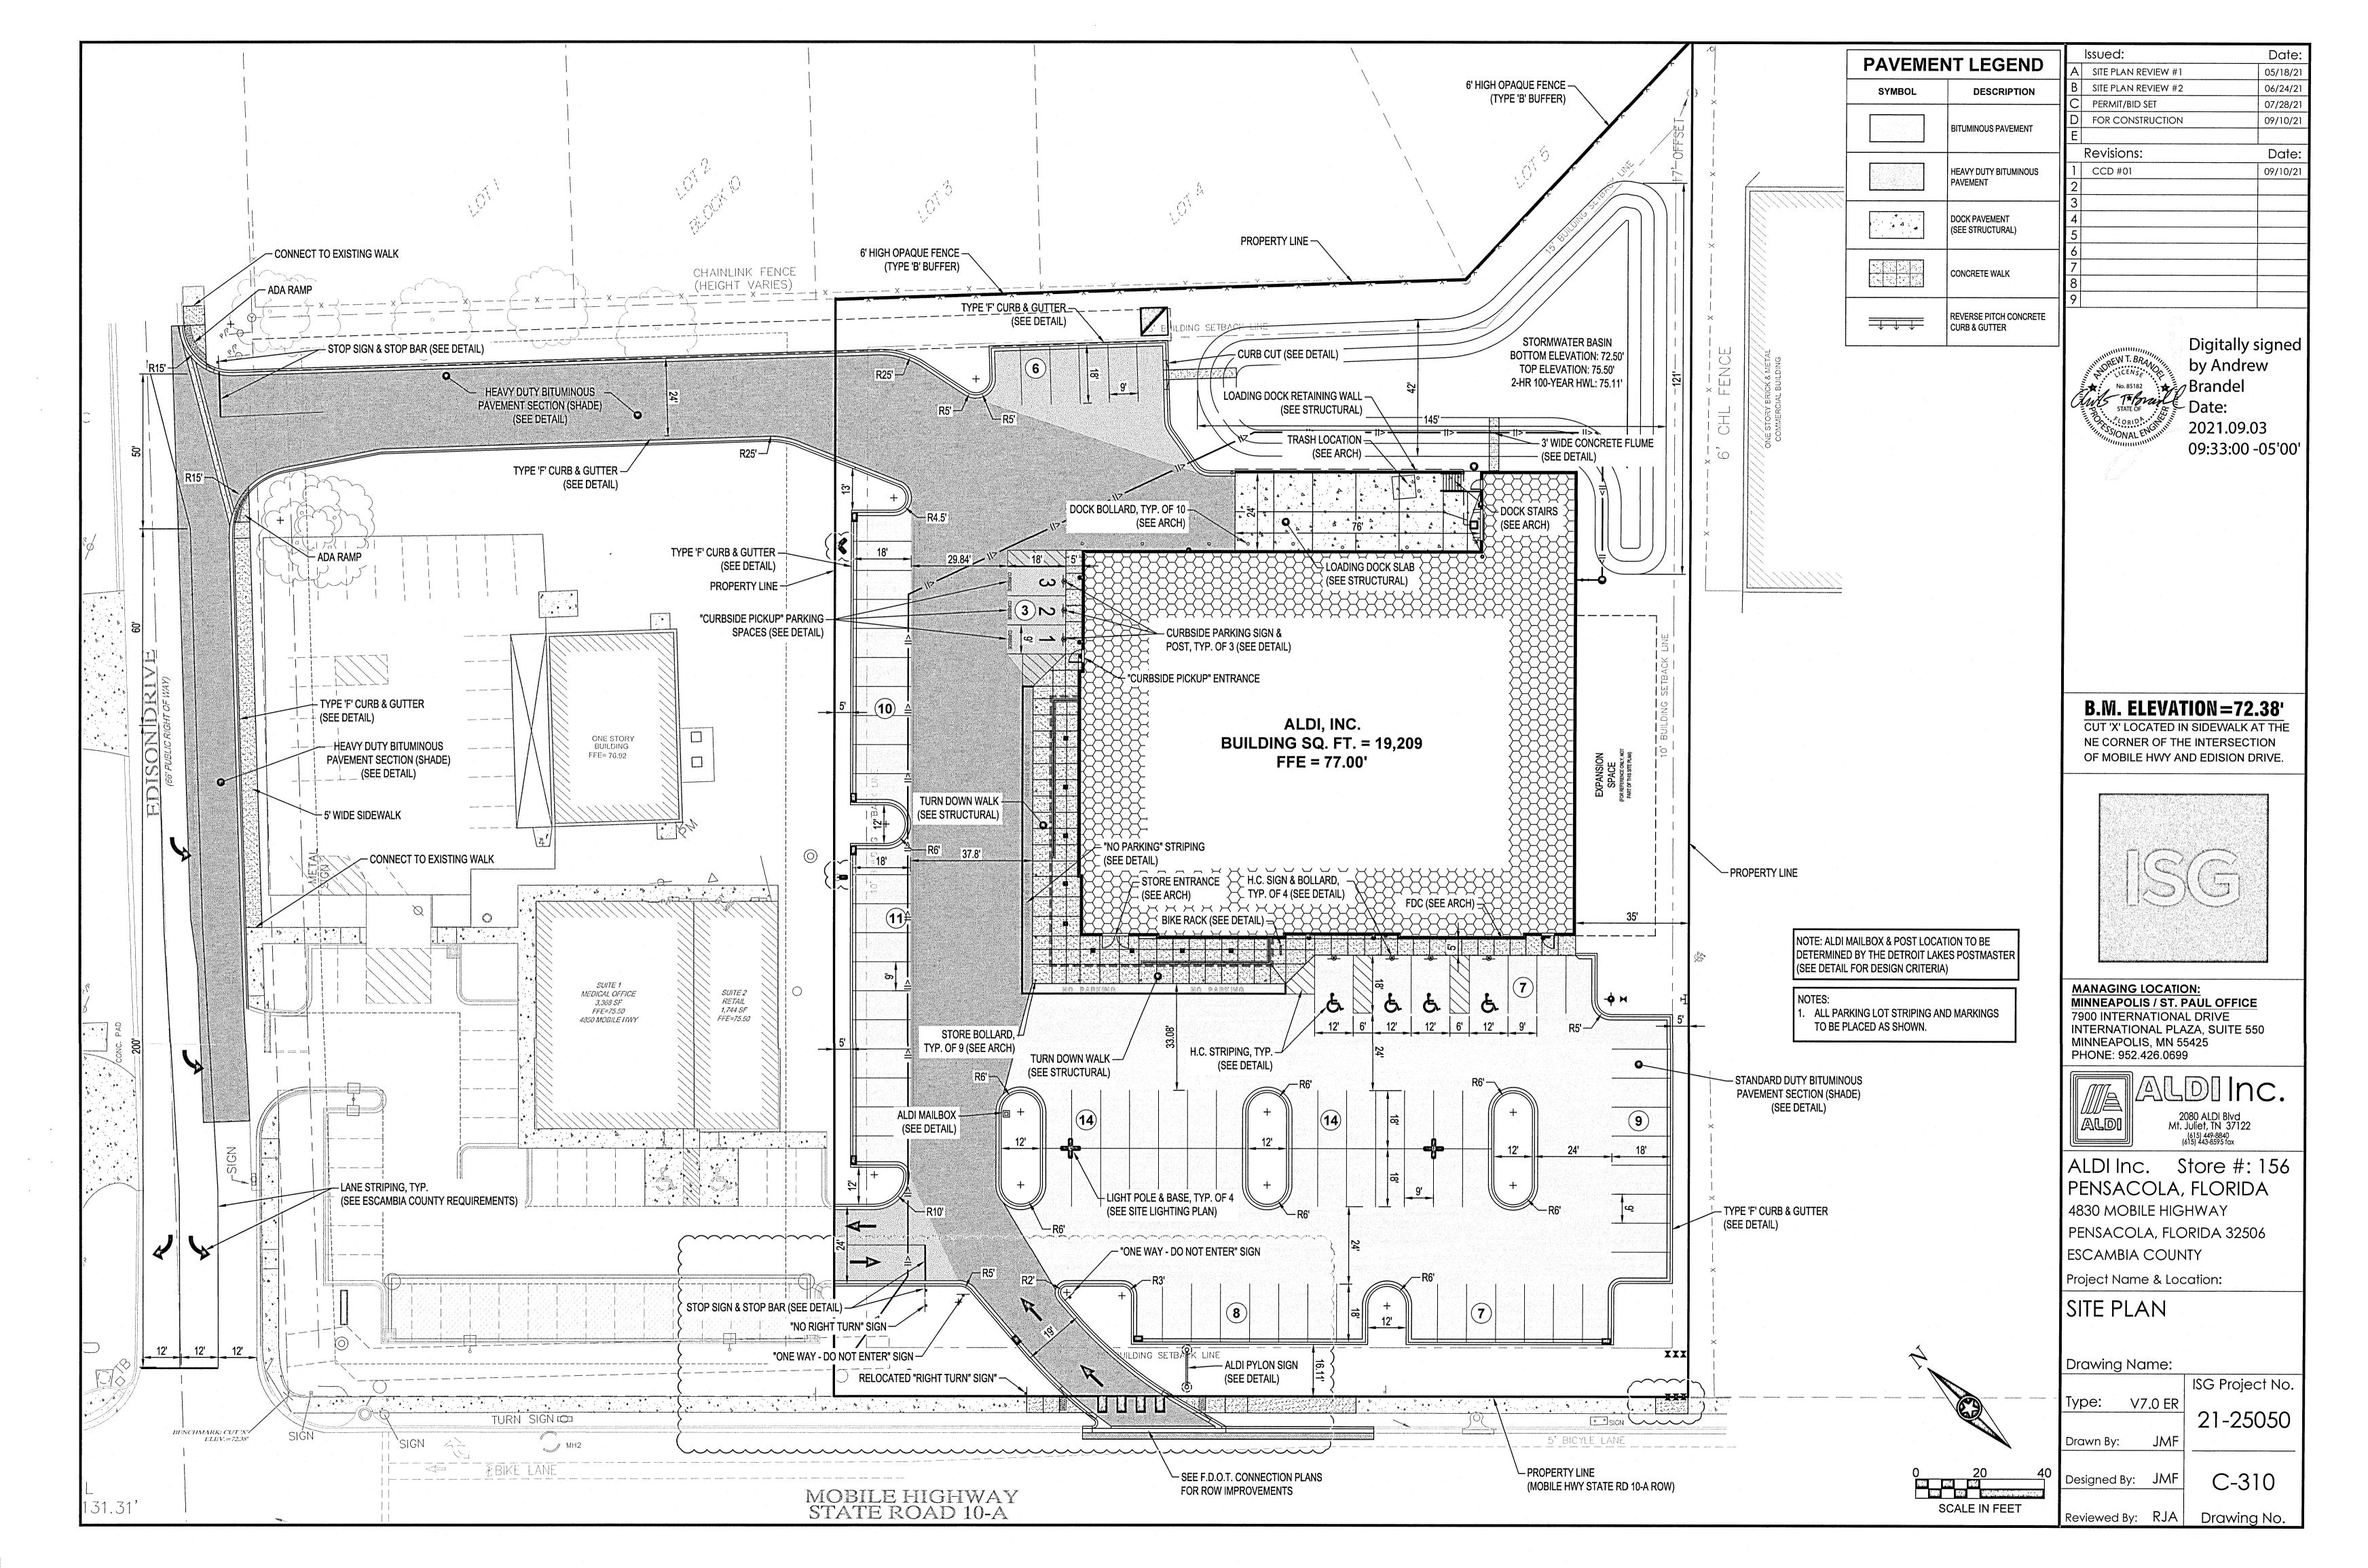

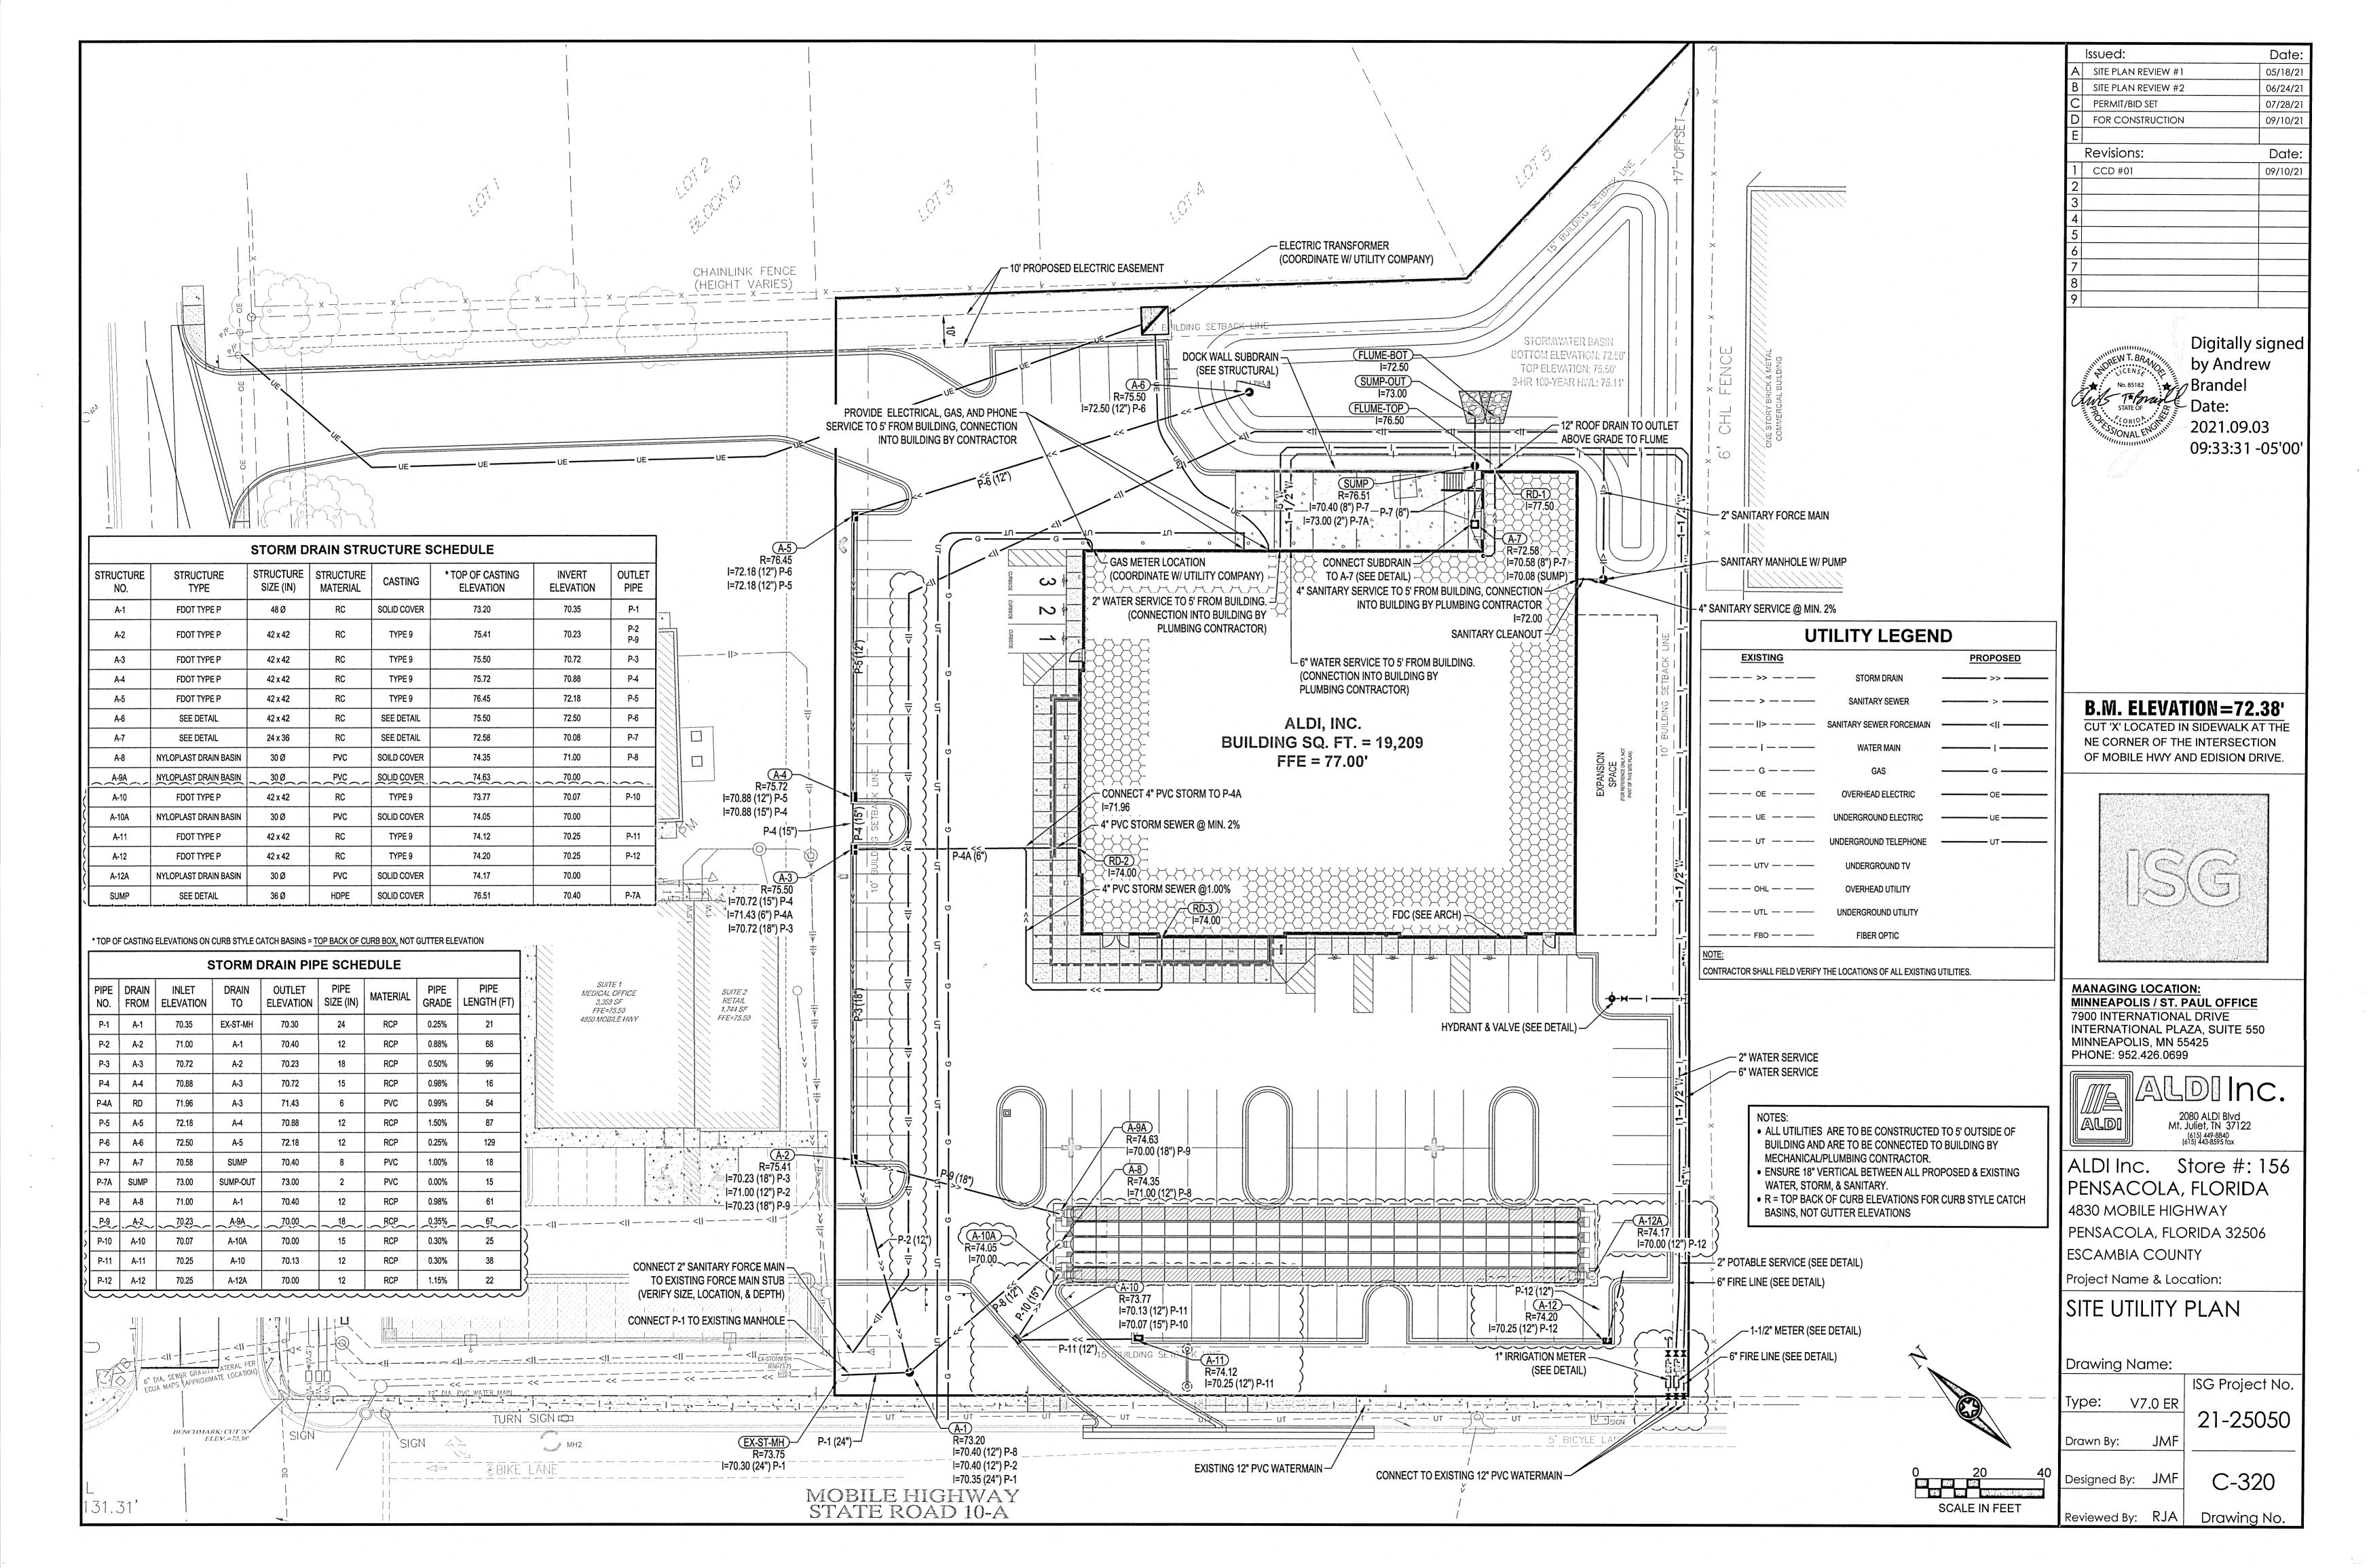


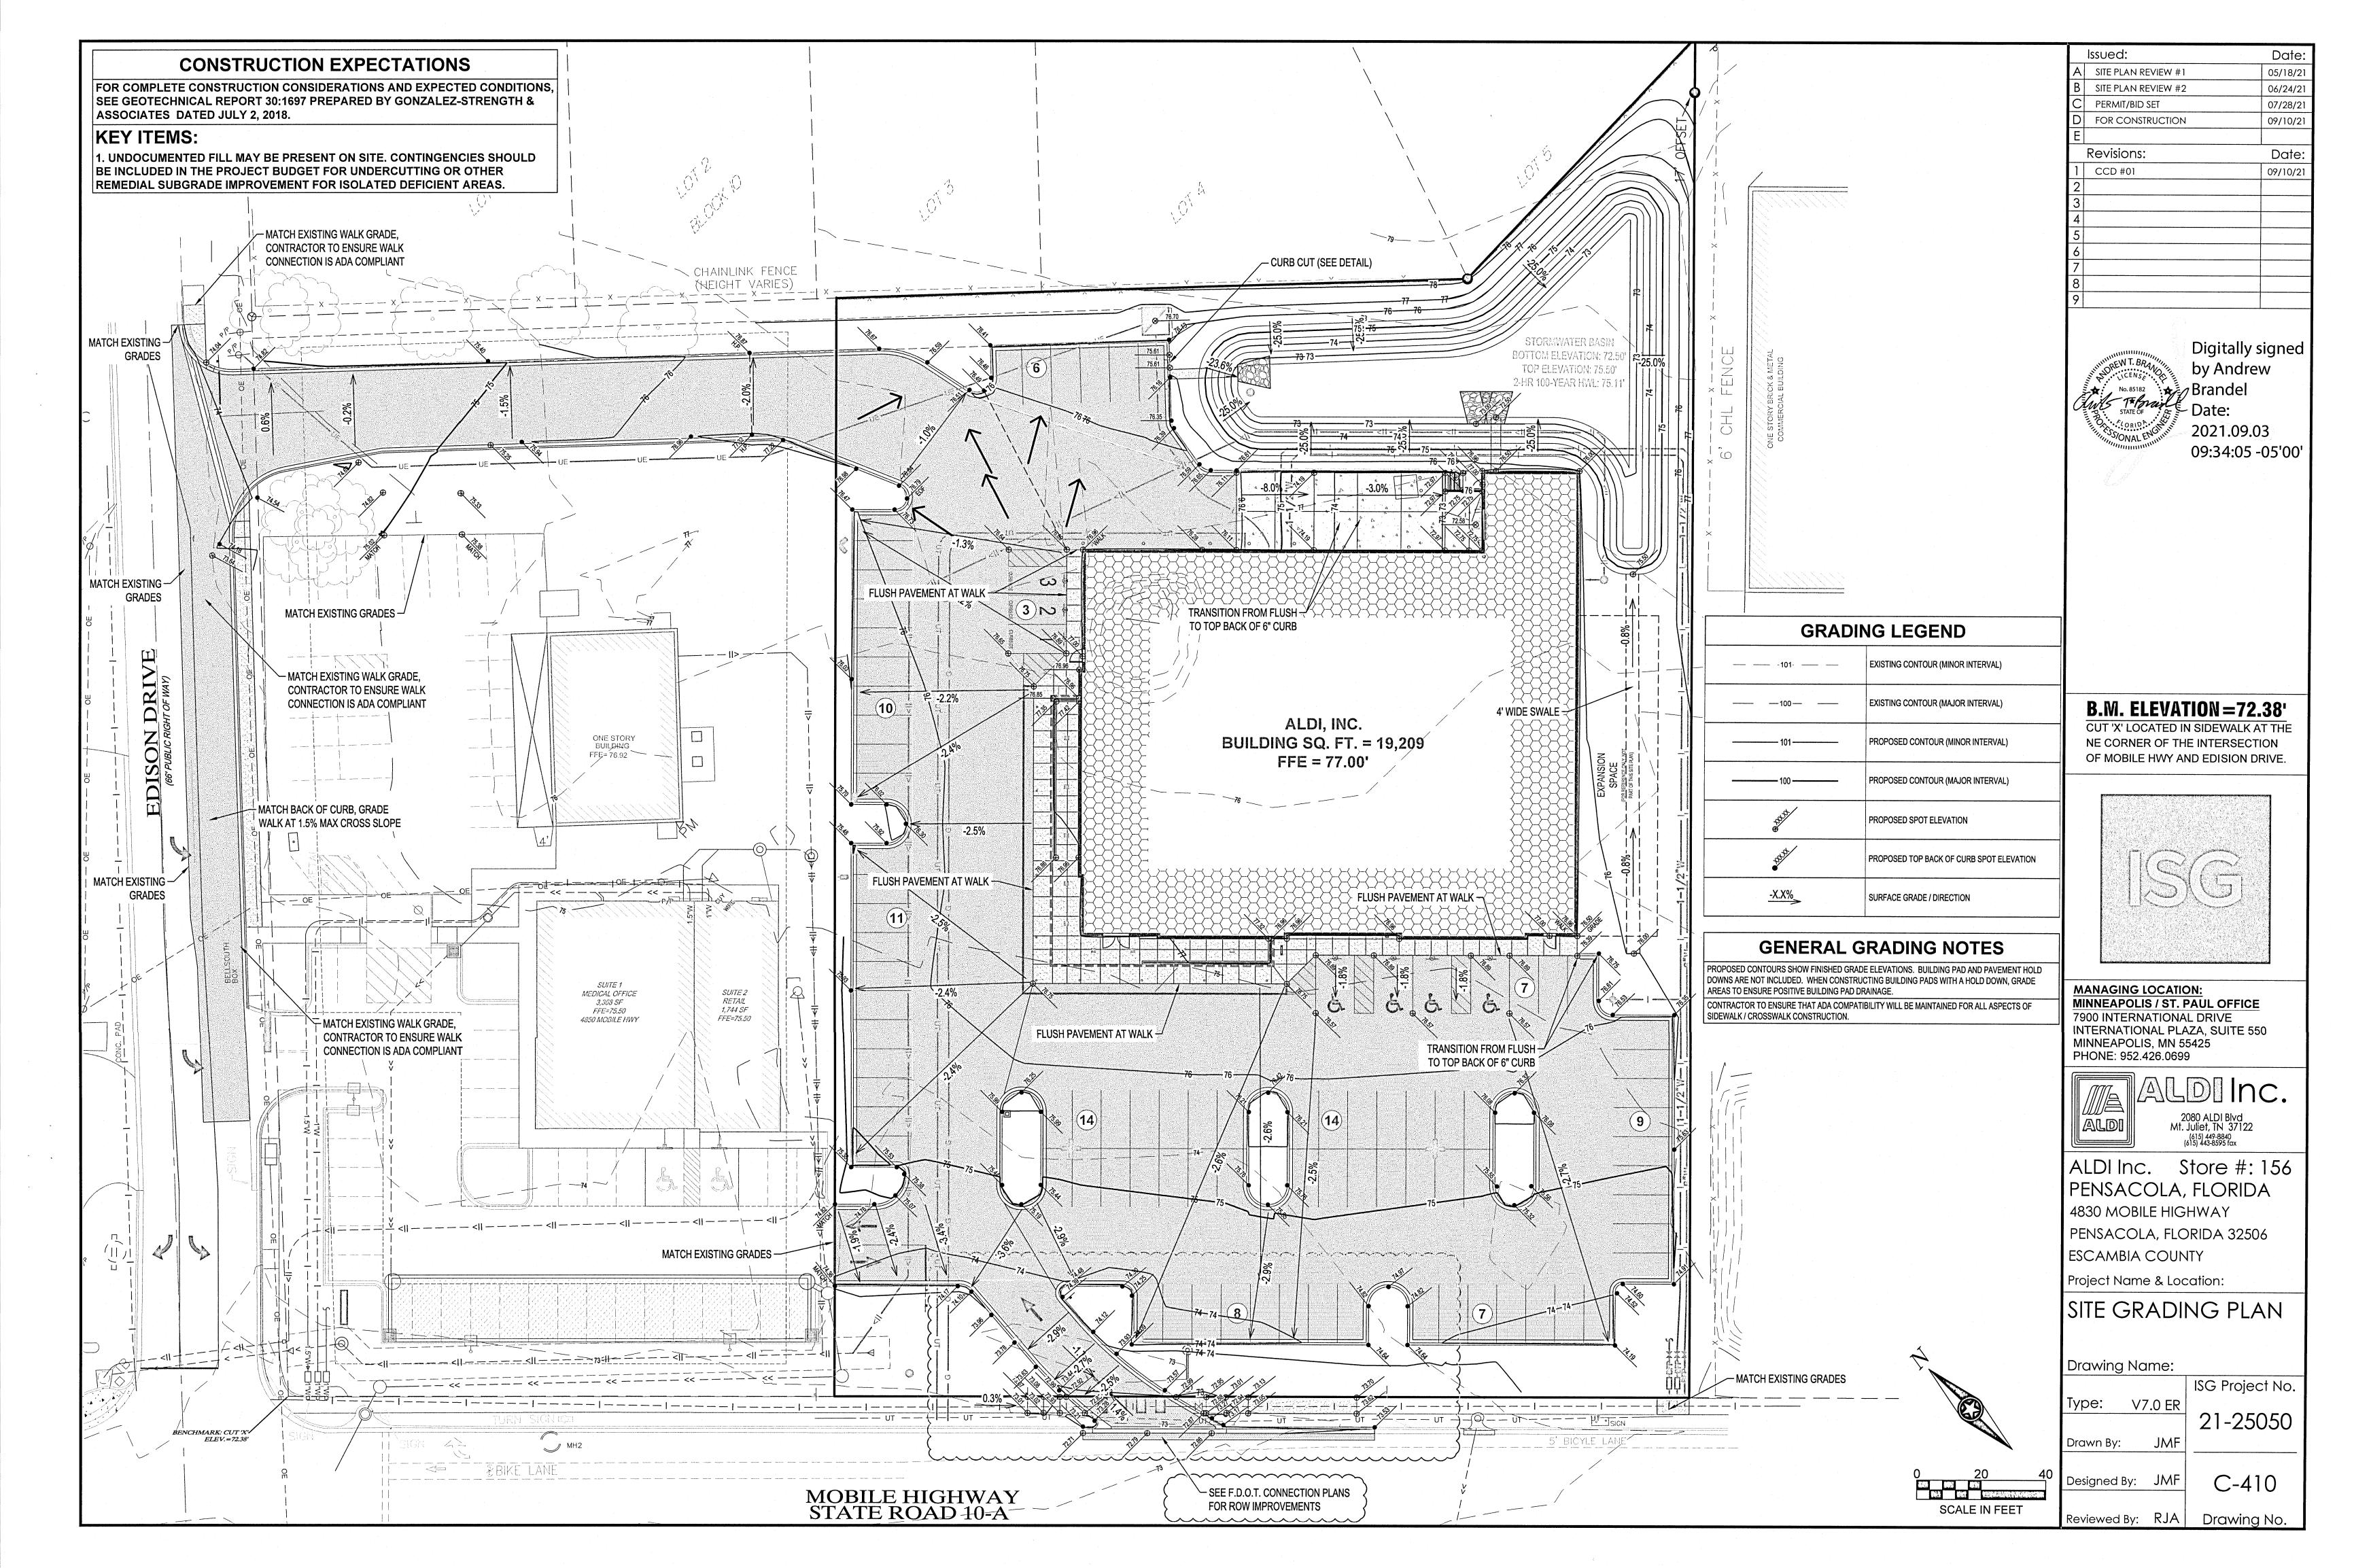

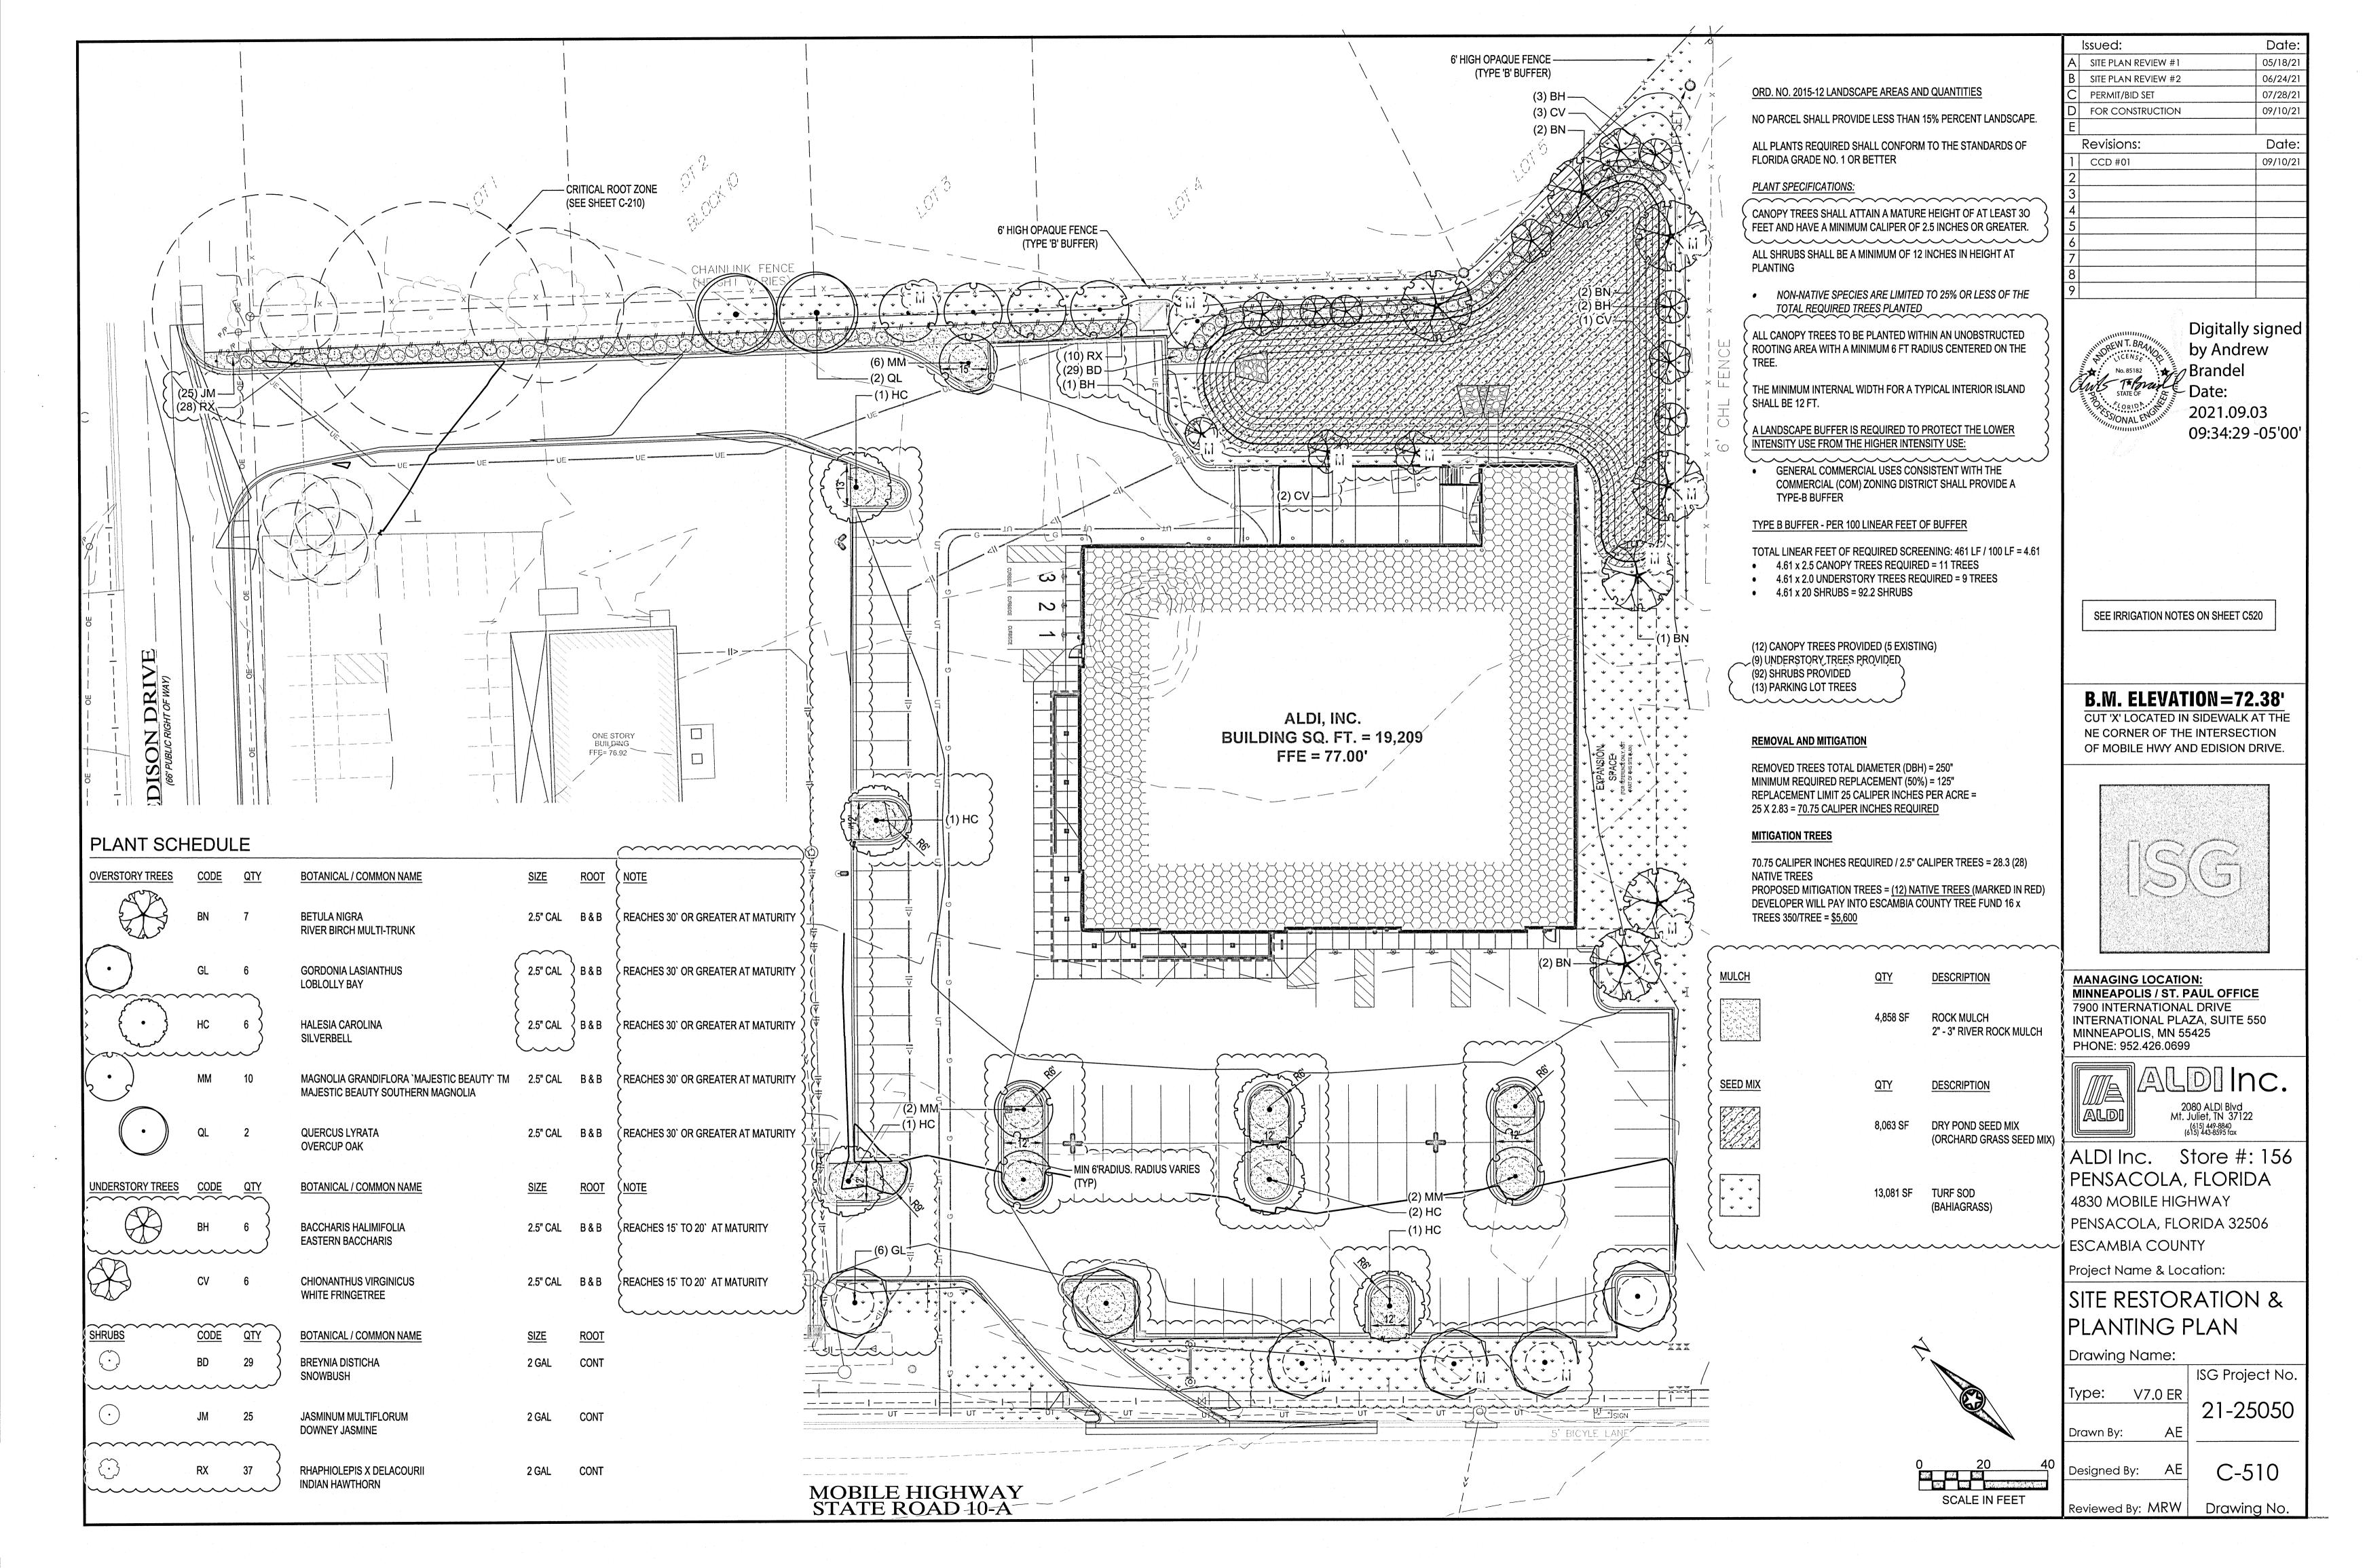

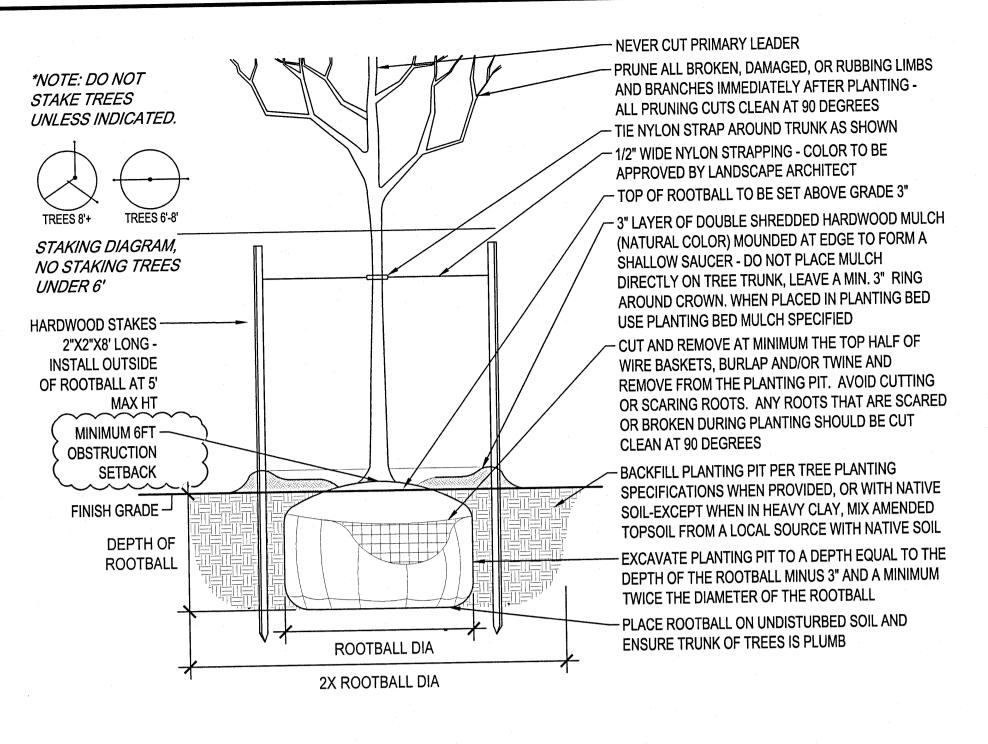


DECIDUOUS TREE PLANTING DETAIL

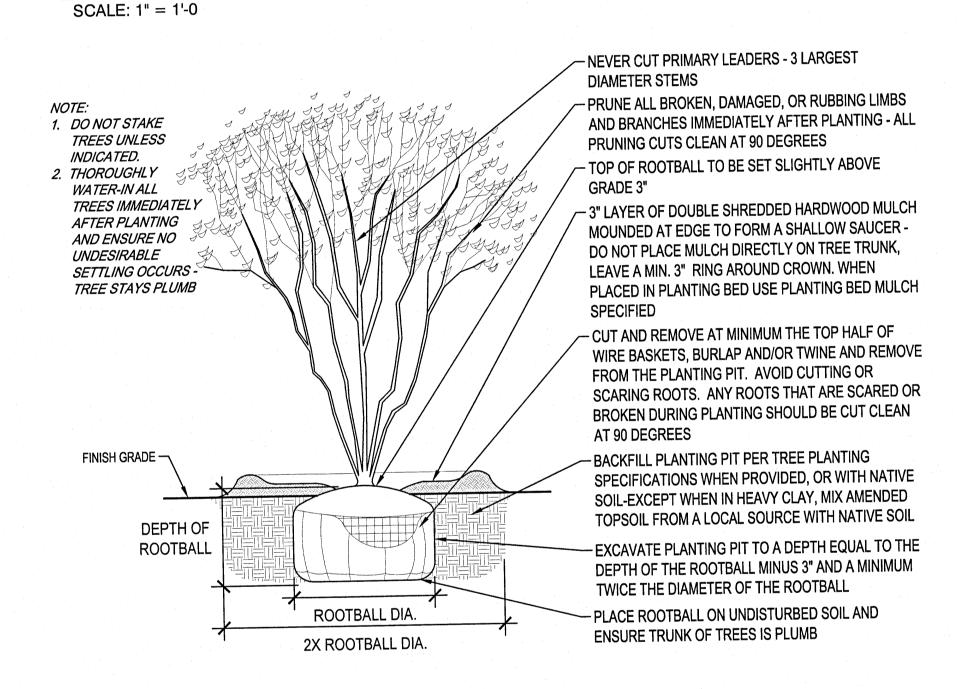

MULTI-STEM TREE PLANTING DETAILS

SCALE: 1" = 1'-0

SCALE: 1" = 1'-0

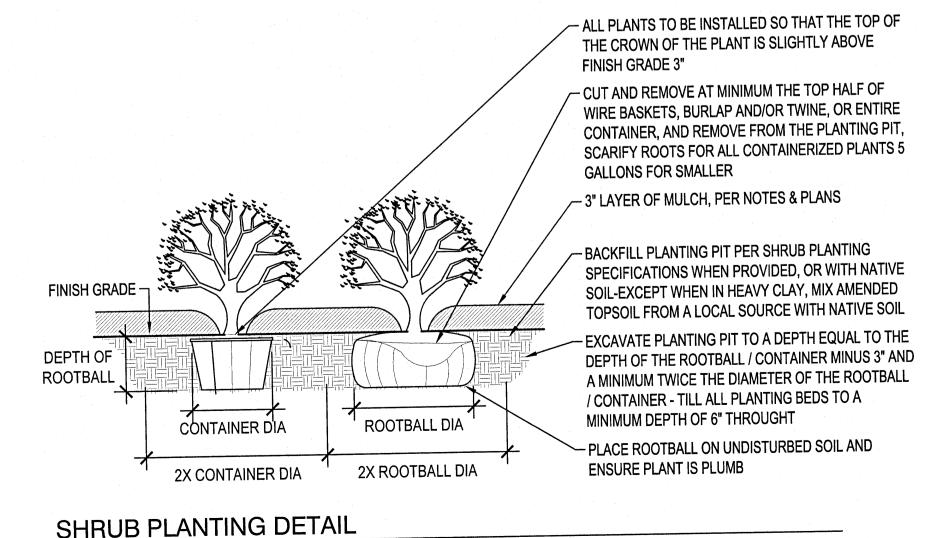


GENERAL PLANTING NOTES

- 1. COORDINATE LOCATION OF ALL UTILITIES (LINES, DUCTS, CONDUITS, SLEEVES, FOOTINGS, ETC.) WITH LOCATIONS OF PROPOSED LANDSCAPE ELEMENTS (FENCE, FOOTINGS, TREE ROOTBALLS, ETC.). CONTRACTOR SHALL REPORT ANY DISCREPANCIES TO OWNER'S REPRESENTATIVE PRIOR TO CONTINUING
- 2. SAVE AND PROTECT ALL EXISTING TREES AND SHRUBS NOT NOTED TO BE REMOVED. CONTRACTOR IS RESPONSIBLE FOR ALL DAMAGE DUE TO OPERATIONS. ANY AREAS THAT ARE DISTURBED SHALL BE RESTORED TO ITS ORIGINAL CONDITION AT NO ADDITIONAL COST TO THE OWNER, INCLUDING
- REMOVE ALL CONSTRUCTION DEBRIS AND MATERIALS INJURIOUS TO PLANT GROWTH FROM PLANTING PITS AND BEDS PRIOR TO BACKFILLING WITH
- 4. IF DISCREPANCIES EXIST BETWEEN THE NUMBER OF PLANTS DRAWN ON THE PLANTING PLAN AND THE NUMBER OF PLANTS IN THE SCHEDULE, THE PLANTING PLAN SHALL GOVERN.
- 5. OWNER RESERVES THE RIGHT TO REVISE QUANTITIES TO SUIT BUDGET LIMITATIONS. CONTRACTOR'S UNIT BID PRICES SHALL PREVAIL FOR ANY CHANGES IN QUANTITIES.
- 6. PLANT MATERIALS MUST CONFORM TO GRADES AND STANDARDS FOR NURSERY PLANTS, DIVISION OF PLANT INDUSTRY, FLORIDA DEPARTMENT OF
- REFERENCED MANUAL.

 ALL PLANT MATERIAL SHALL BE GUARANTEED TO BE IN A LIVE AND HEALTHY GROWING CONDITION FOR ONE FULL GROWING SEASON (ONE YEAR) AFTER FINAL PROJECT ACCEPTANCE OR SHALL BE REPLACED BY THE CONTRACTOR FREE OF CHARGE WITH THE SAME GRADE AND SPECIES.
- 8. INDICATED QUANTITIES ARE ESTIMATES AND SHOULD BE CONFIRMED BY THE CONTRACTOR/BIDDER
- 12. ALL CANOPY TREES TO BE PLANTED WITHIN AN UNOBSTRUCTED ROOTING AREA WITH A MINIMUM 6 FT RADIUS CENTERED ON THE TREE. 13. ALL CANOPY TREES SHALL BE SETBACK A MINIMUM 6 FEET FROM CURBS OR OTHER OBSTRUCTIONS.
- 14. ALL UNDERSTORY TREES SHALL BE SETBACK 4 FEET FROM CURBS OR OTHER OBSTRUCTIONS.
- 15. THE MINIMUM INTERNAL WIDTH FOR A TYPICAL INTERIOR ISLAND SHALL BE 12 FT.
- ~16. PROVIDE 2" = 3" RIVER ROCK MULCH AT 3" DEPTH WITH PERMEABLE WEED BARRIER IN ALL PLANTING BEDS, PARKING ISLANDS, AND MOW STRIP AREAS. ^ FOR TREES NOT LOCATED IN PARKING ISLANDS, OR PLANTING BEDS, PROVIDE DOUBLE SHREDDED HARDWOOD MULCH RING (NATURAL COLOR) AT 3" DEPTH PER PLANTING DETAILS.
- 17. ALL PLANTING BEDS AND MAINTENANCE STRIP THAT ABUTS SOD AREAS TO HAVE BLACK POLY OR VINYL EDGING (COMMERCIAL GRADE).
- 18. ALL TURF AREAS DISTURBED BY CONSTRUCTION SHALL BE SEEDED OR SODDED PER PLANS.


IRRIGATION NOTES

- IRRIGATION SYSTEM SHALL BE CONSTRUCTED AS A DESIGN BUILD PROJECT. SUBMIT DESIGN DRAWINGS FOR APPROVAL BY OWNER...
- ONLY PLANTING BEDS AND TURF AREAS SHALL BE SERVICED BY THE IRRIGATION SYSTEM. ALL IRRIGATION SHALL BE COMPATIBLE WITH LOCAL JURISDICTION CODE. IRRIGATION SHALL NOT OVER SPRAY ONTO ADJACENT HARDSCAPE, BUILDINGS, OR ANY OTHER NON-TURF
- PROVIDE ALL IRRIGATION LINE, SPRAY HEADS, SLEEVING UNDER HARDSCAPE, VALVES, WIRING, CONTROLLER, BACK-FLOW PREVENTOR, MAIN & LATER PIPES, CENTRAL CONTROL WATER MANAGEMENT SYSTEM, AND ALL OTHER REQUIRED ACCESSORIES.
- CONFIRM POINT(S) OF CONNECTION AND CONTROL BOX LOCATIONS WITH OWNER PRIOR TO DESIGN OF IRRIGATION SYSTEM. COORDINATE LOCATIONS OF SLEEVING WITH ALL UTILITIES, FOOTINGS, AND ANY OTHER UNDERGROUND CONSTRUCTION.
- 5. IRRIGATION WATER METER TO BE INSTALLED BY PLUMBING CONTRACTOR.

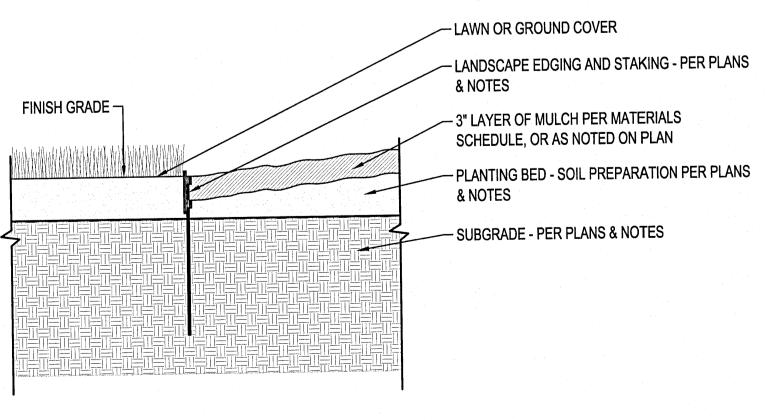


LANDSCAPE EDGING DETAIL SCALE: 1" = 1'-0

Date: Issued: 05/18/21 SITE PLAN REVIEW #1 06/24/21 SITE PLAN REVIEW #2 07/28/21 PERMIT/BID SET 09/10/21 FOR CONSTRUCTION Date: Revisions: 09/10/21 CCD #01

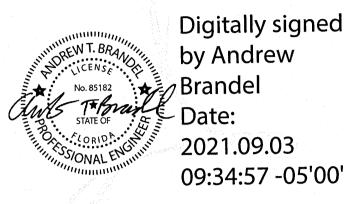

B.M. ELEVATION=72.38'

CUT 'X' LOCATED IN SIDEWALK AT THE NE CORNER OF THE INTERSECTION OF MOBILE HWY AND EDISION DRIVE.

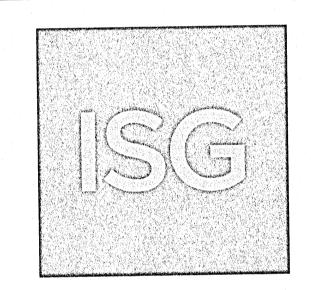

MANAGING LOCATION: MINNEAPOLIS / ST. PAUL OFFICE 7900 INTERNATIONAL DRIVE INTERNATIONAL PLAZA, SUITE 550 MINNEAPOLIS, MN 55425 PHONE: 952.426.0699



2080 ALDI Blvd Mt. Juliet, TN 37122

Store #: 156 ALDI Inc. PENSACOLA, FLORIDA 4830 MOBILE HIGHWAY PENSACOLA, FLORIDA 32506 ESCAMBIA COUNTY

Project Name & Location:


SITE PLANTING NOTES & DETAILS


Drawing Name:

ISG Project No. Type: V7.0 ER 21-25050 Drawn By: C-520

Designed By:

Reviewed By: MRW | Drawing No.

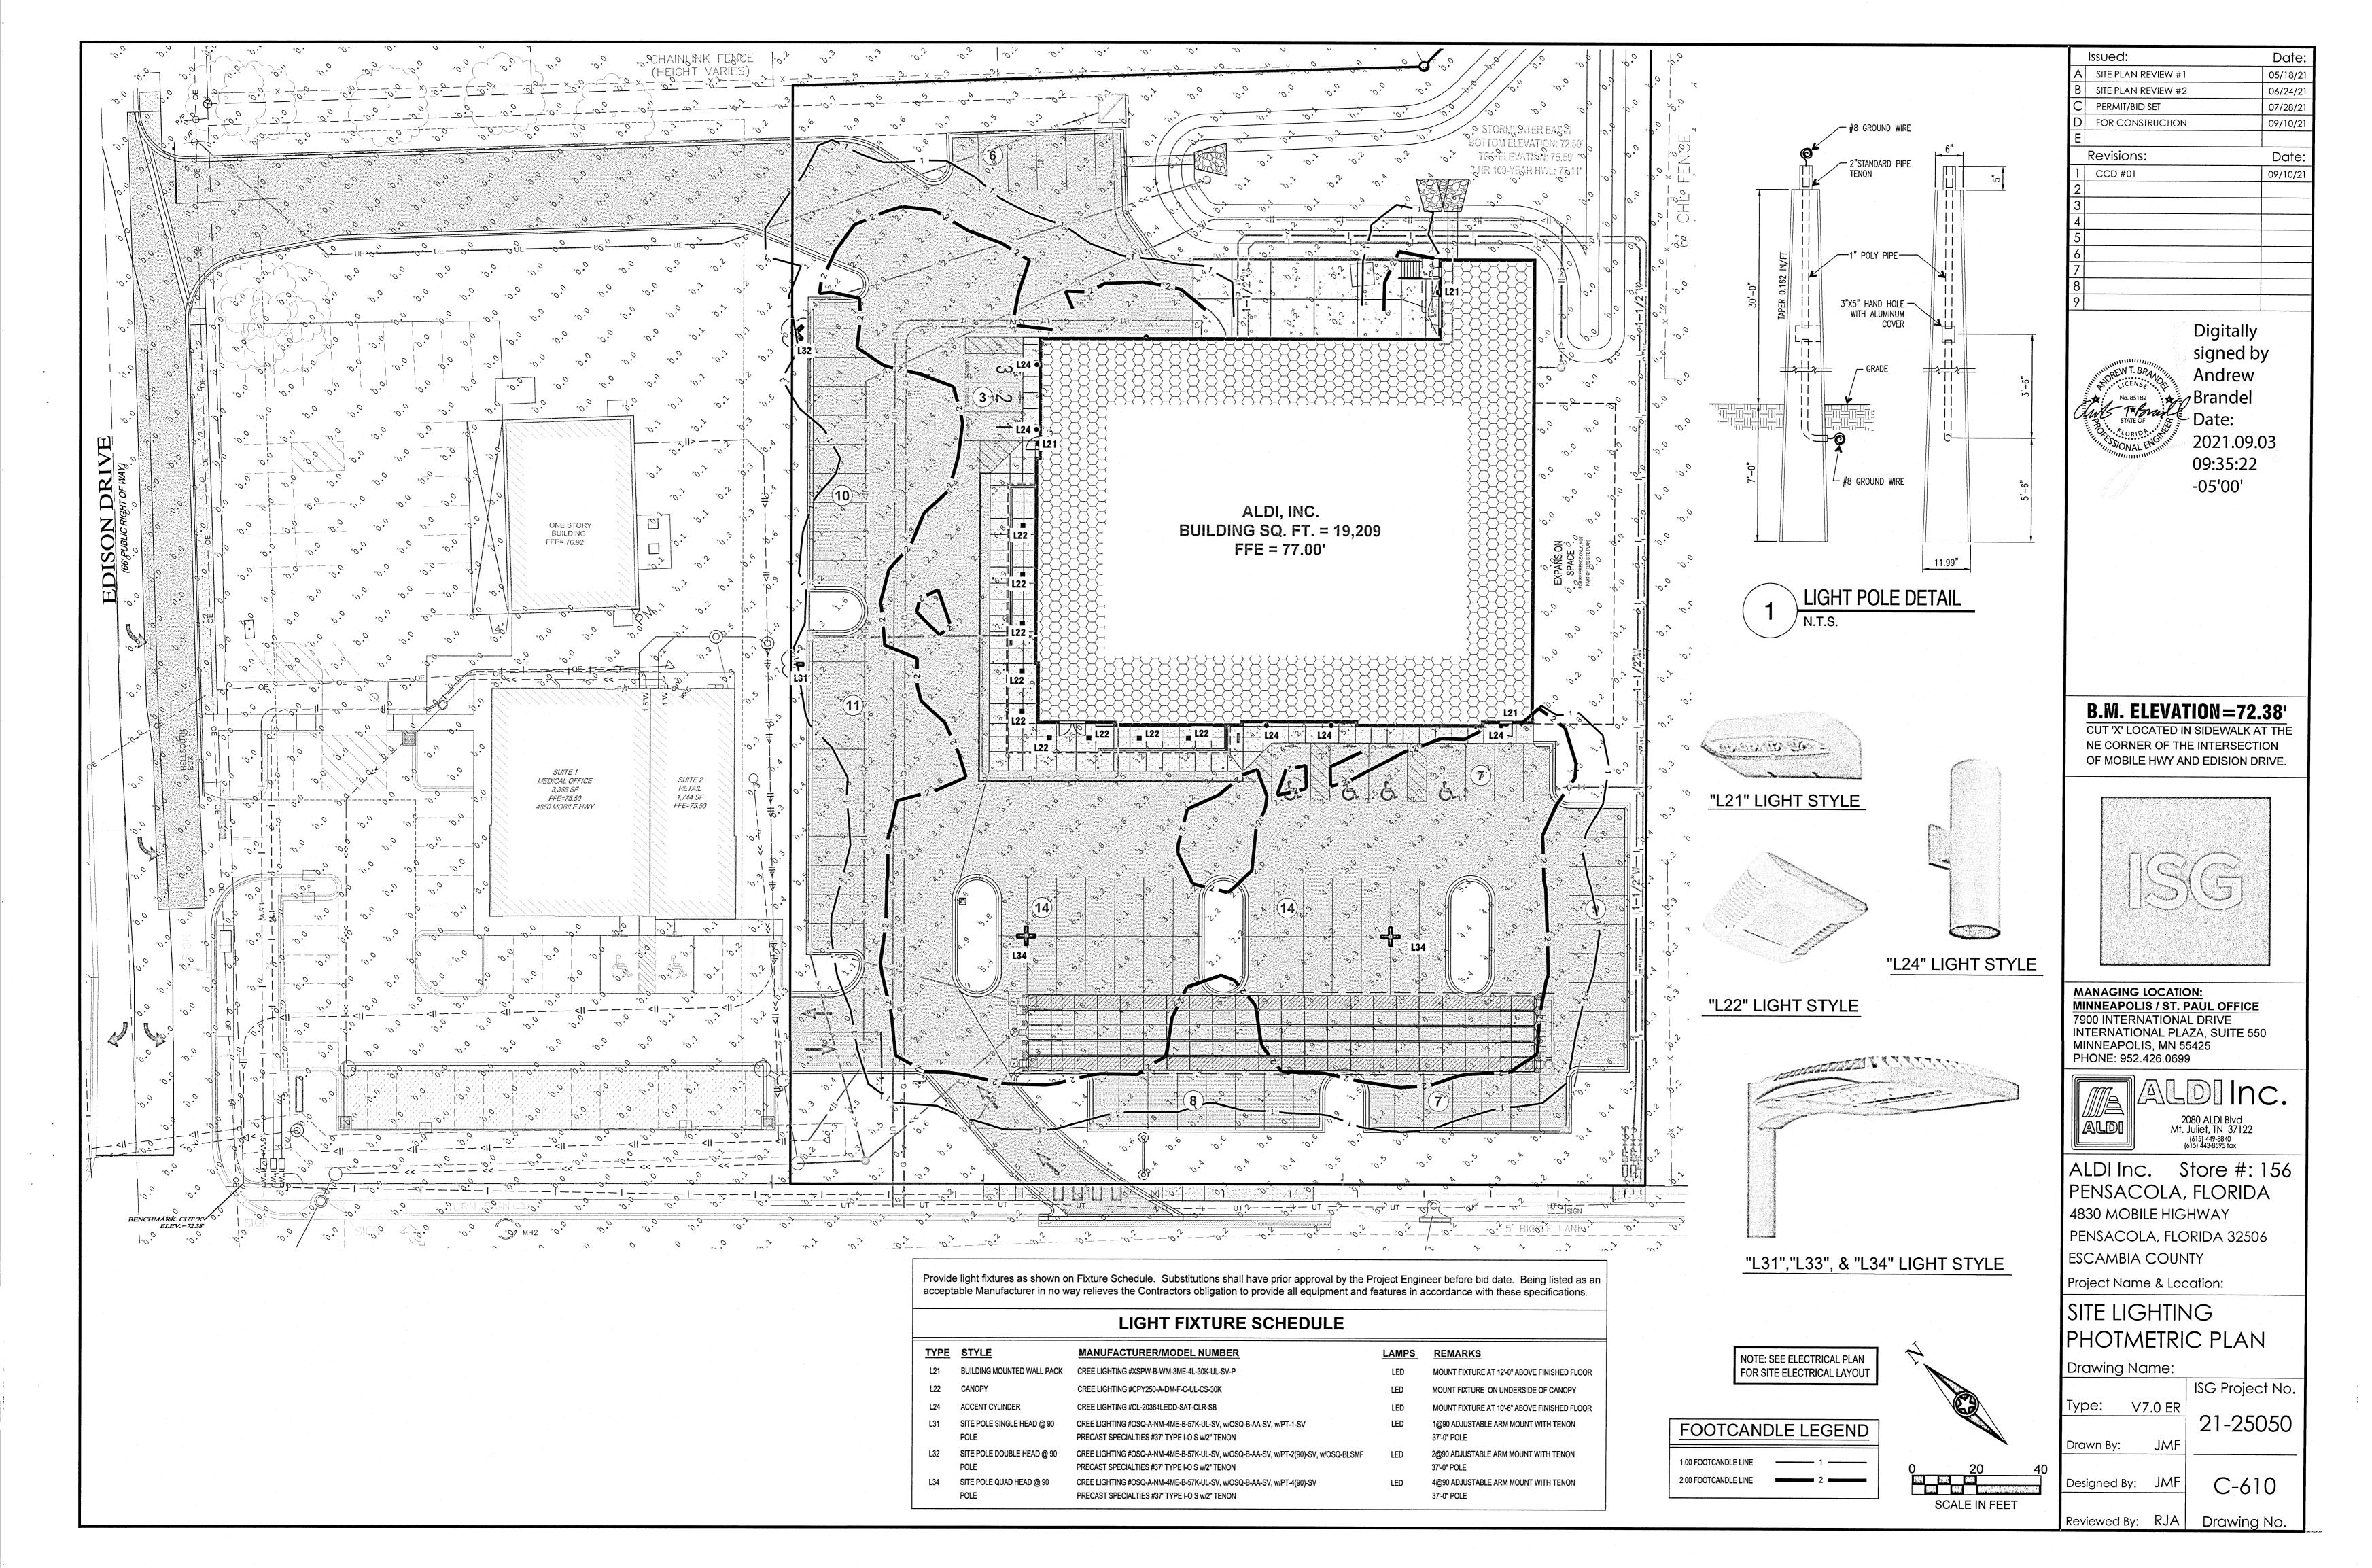

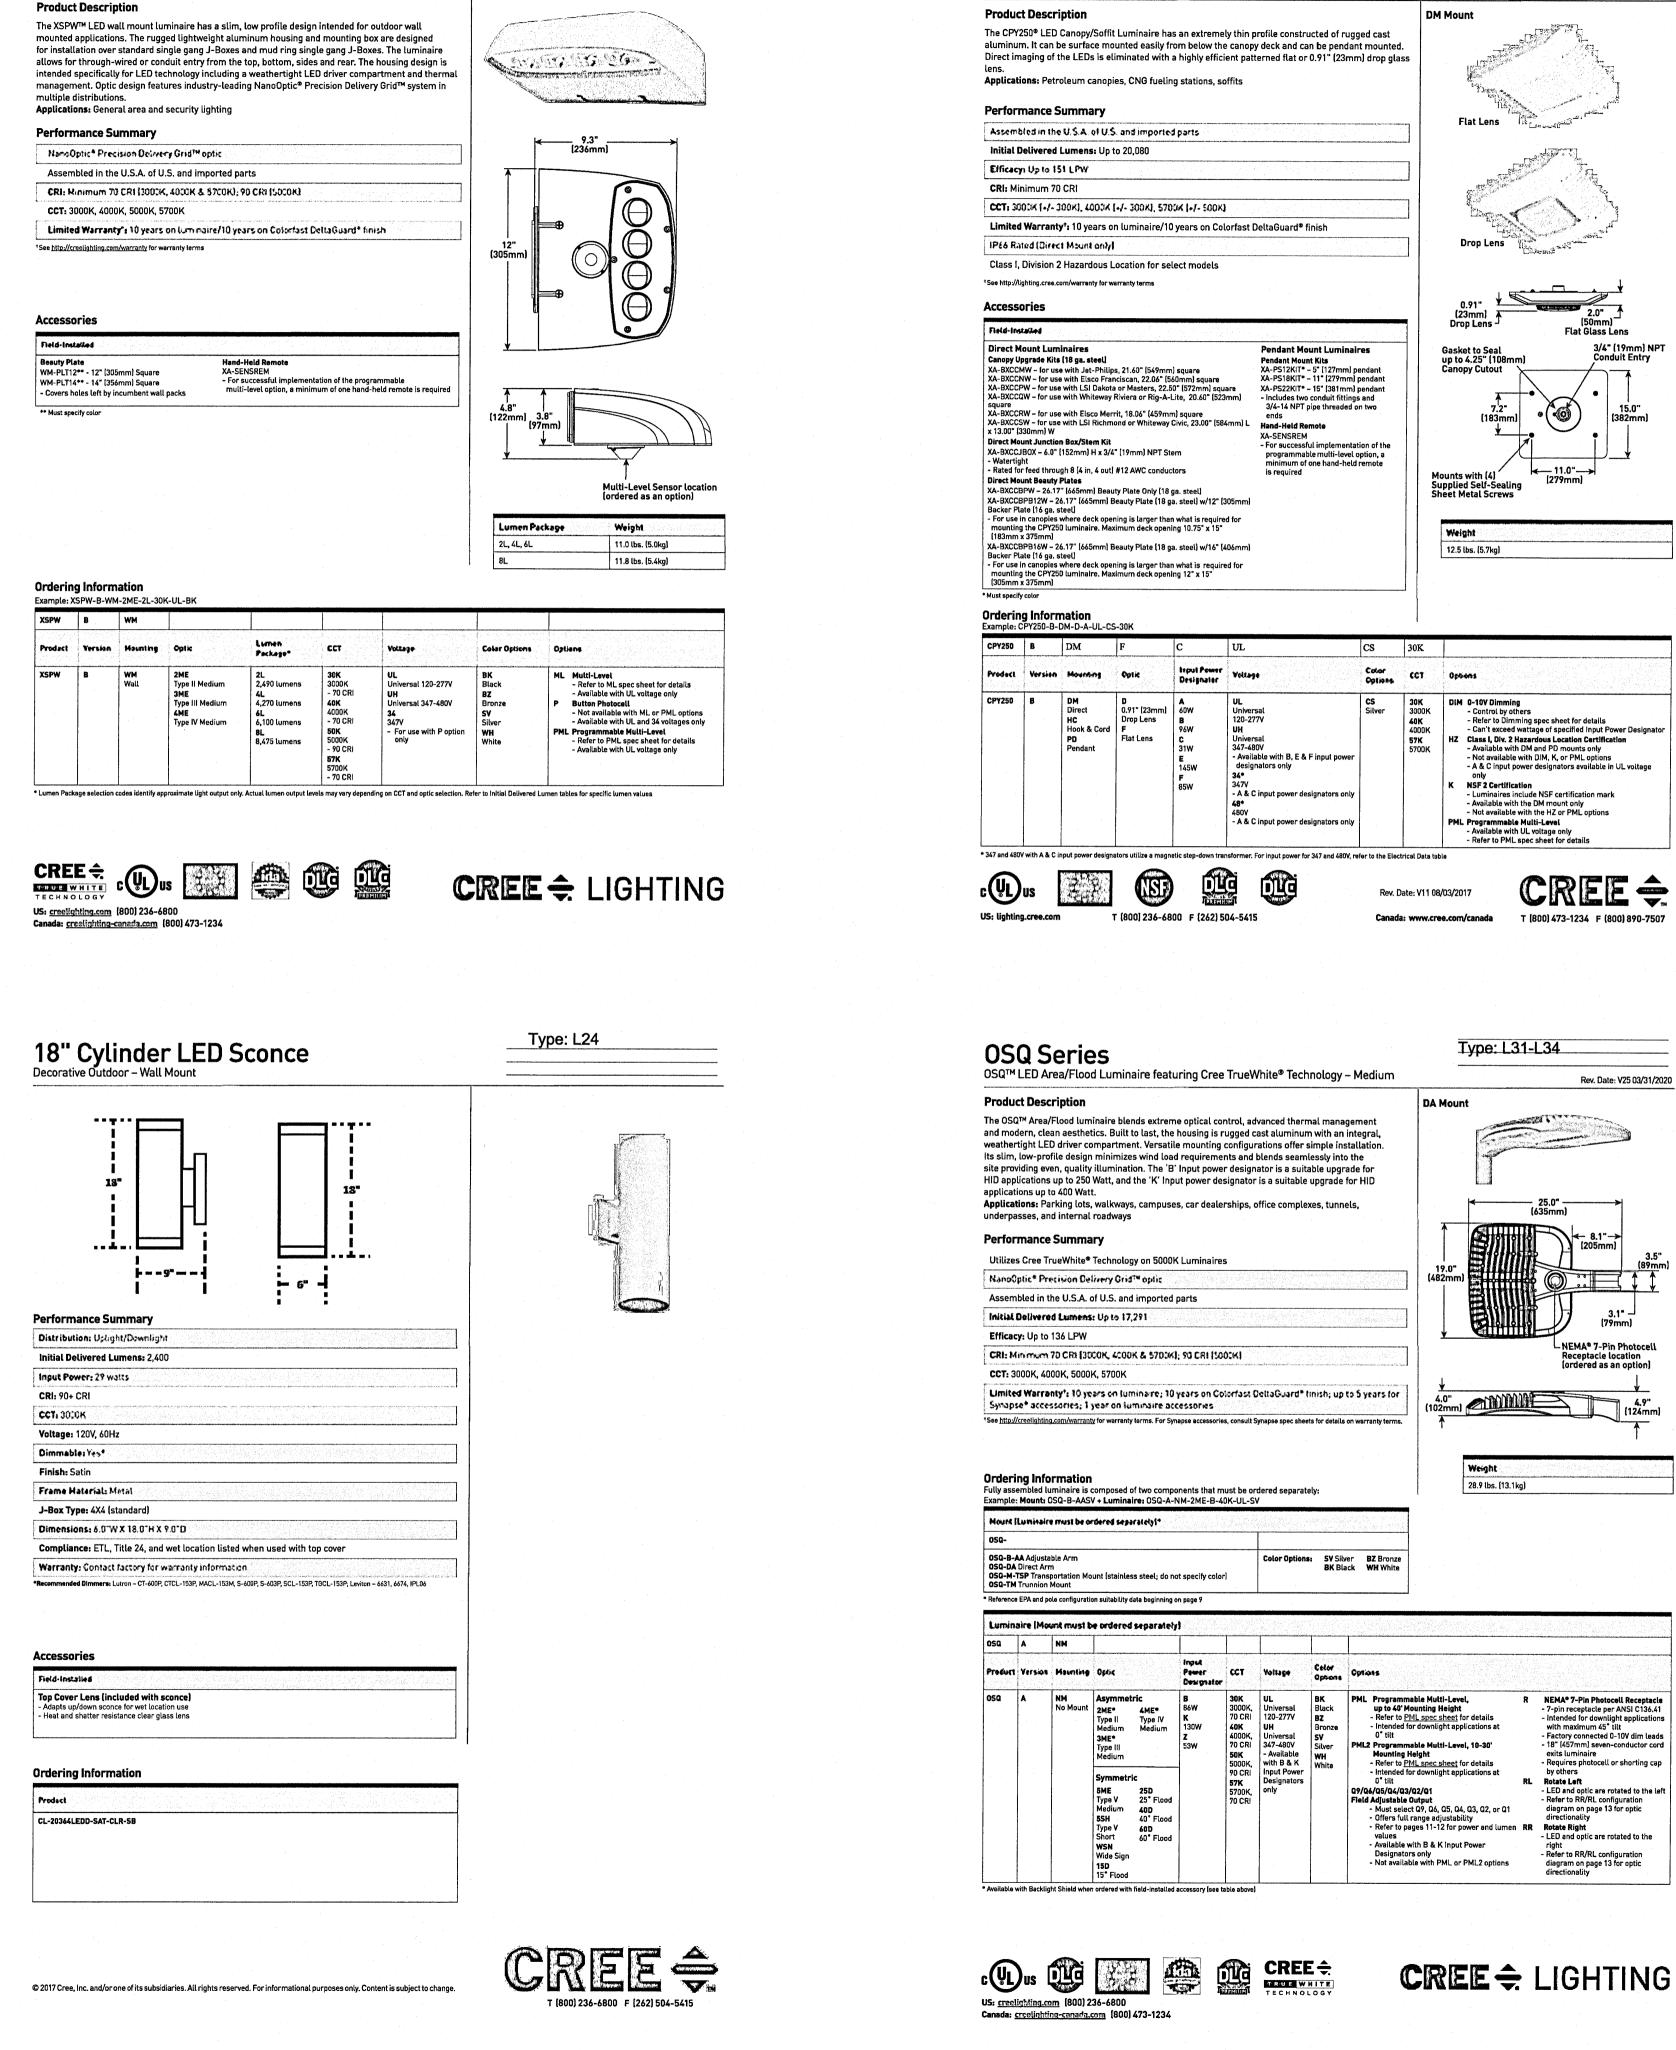


Type: L21

Rev. Date: VersionB V4 02/25/2020

XSP Series

XSPW™ LED Wall Mount Luminaire featuring Cree TrueWhite® Technology

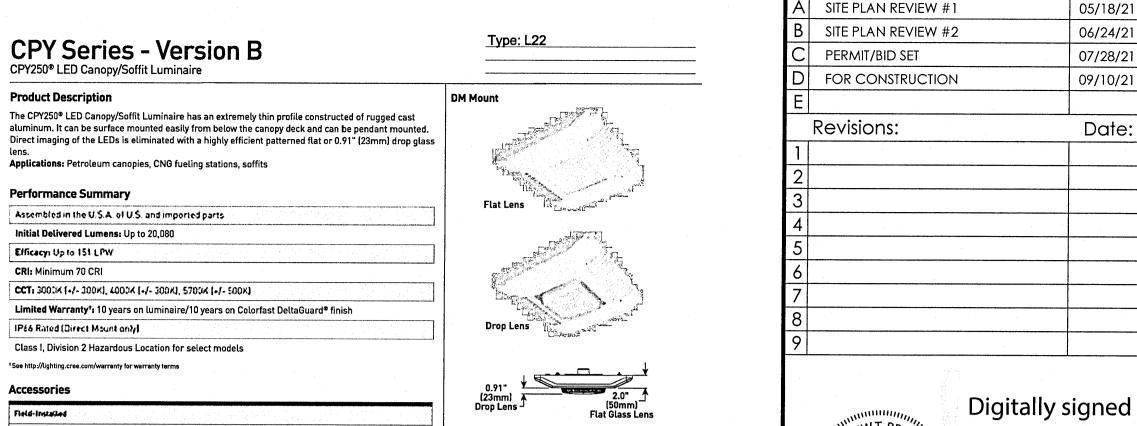

Agunts with (4)

12.5 lbs. (5.7kg)

IZ Class I, Div. 2 Hazardous Location Certification

- Available with DM and PD mounts only

- Not available with DIM, K, or PML options

Luminaires include NSF certification mark
 Available with the DM mount only
 Not available with the HZ or PML options

ML Programmable Multi-Level - Refer to PML spec sheet for detail

Type: L31-L34

- A & C input power designators available in UL voltage

T (800) 473-1234 F (800) 890-7507

Rev. Date: V25 03/31/2020

- NEMA® 7-Pin Photocell

NEMA® 7-Pin Photocell Receptacle
- 7-pin receptacle per ANSI C136.41

 Intended for downlight applications with maximum 45° tilt - Factory connected 0-10V dim leads - 18" [457mm] seven-conductor cord

- Requires photocell or shorting cap by others

Rotate Left
- LED and optic are rotated to the left

- Refer to RR/RL configuration diagram on page 13 for optic

right - Refer to RR/RL configuration

Rotate Right




issued:

Digitally signed by Andrew 2021.09.03 09:35:46 -05'00'

Date:

B.M. ELEVATION=72.38'

CUT 'X' LOCATED IN SIDEWALK AT THE **NE CORNER OF THE INTERSECTION** OF MOBILE HWY AND EDISION DRIVE

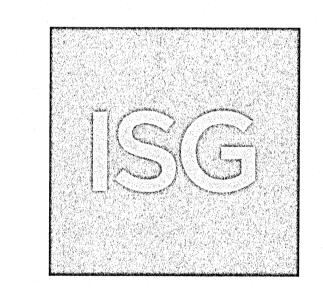

MANAGING LOCATION: MINNEAPOLIS / ST. PAUL OFFICE 7900 INTERNATIONAL DRIVE INTERNATIONAL PLAZA, SUITE 550 MINNEAPOLIS, MN 55425 PHONE: 952.426.0699



2080 ALDI Blvd Mt. Juliet, TN 37122

Store #: 156 PENSACOLA, FLORIDA 4830 MOBILE HIGHWAY PENSACOLA, FLORIDA 32506

Project Name & Location:

ESCAMBIA COUNTY

SITE LIGHTING CATALOGUE PAGES

Drawing Name:

Reviewed By: RJA

ISG Project No. Type: V7.0 ER 21-25050 JMF Drawn By:

Drawing No.

Designed By: JMF C-620