GENERAL NOTES:

- THE CONTRACTOR IS RESPONSIBLE FOR PROVIDING THE ENGINEER WITH A SIGNED AND SEALED AS-BUILT SURVEY FOR THE ENGINEER'S USE IN PREPARING AS-BUILT CERTIFICATIONS AND RECORD DRAWINGS FOR THE OWNER. AS-BUILT INFORMATION MUST INCLUDE BUT NOT BE LIMITED TO: ROUTING OF ALL EXISTING AND PROPOSED UNDERGROUND UTILITIES WITH DISTANCES TO/LOCATIONS OF LINES, BENDS, FITTINGS, STRUCTURES, AND OTHER APPURTENANCES MEASURED FROM AT LEAST TWO FIXED POINTS; TOP, BOTTOM, AND PIPE INVERT ELEVATIONS OF ALL STORM WATER AND SANITARY SEWER STRUCTURES, INCLUDING CLEANOUTS, RELATIVE TO FINISHED FLOOR; REVISIONS TO SITE LAYOUT DEPICTED IN THE PLANS
- 2. THE PROJECT ENGINEER (ENGINEER OF RECORD) MUST PROVIDE ESCAMBIA COUNTY WITH THE SIGNED/SEALED "AS-BUILT" RECORD DRAWINGS FOR VERIFICATION AND APPROVAL BY ESCAMBIA COUNTY ONE WEEK PRIOR TO REQUESTING A FINAL INSPECTION AND CERTIFICATE OF OCCUPANCY, OR PROVIDE "AS-BUILT" CERTIFICATION THAT THE PROJECT CONSTRUCTION ADHERES TO THE PERMITTED PLANS AND SPECIFICATIONS. THE "AS-BUILT" CERTIFICATION OR THE "AS-BUILT" RECORD DRAWINGS MUST BE SIGNED, SEALED AND DATED BY A REGISTERED FLORIDA PROFESSIONAL ENGINEER.
- 3. ALL EXISTING WETLANDS/RIVERINES, AND THE REQUIRED BUFFER ZONES, MUST BE PROTECTED TO THE GREATEST EXTENT
- 4. THE CONTRACTOR IS RESPONSIBLE FOR SODDING ALL AREAS INDICATED ON THE PLANS AND ALL OTHER EXISTING SODDED AREAS WHICH ARE DISTURBED AS A RESULT OF CONSTRUCTION ACTIVITIES, WHETHER SUCH AREAS AND OR ACTIVITIES ARE INDICATED ON THE PLANS OR NOT.
- TREES NOT BEING REMOVED MUST BE PROTECTED PER DETAILS PRESENTED IN THE PLANS.
- ALL TREE PROTECTION BARRICADES MUST BE PLACED PRIOR TO COMMENCEMENT OF ANY SITE WORK, INCLUDING LAND CLEARING, AND MUST BE MAINTAINED FOR THE DURATION OF THE PROJECT
- ALL SITE DRAINAGE INCLUDING ROOF DRAINS, DOWN SPOUTS, OR GUTTERS MUST BE ROUTED TO CARRY ALL STORM WATER AWAY FROM BUILDINGS, WALKS AND PADS TO THE PROPOSED DRAINAGE SYSTEM.
- 8. LOCATIONS AND ELEVATIONS OF UTILITIES SHOWN ON PLANS ARE TO BE CONSIDERED APPROXIMATE ONLY. THE CONTRACTOR MUST EMPLOY THE USE OF GROUND PENETRATING RADAR (GPR) EQUIPMENT BY A QUALIFIED COMPANY AND PERSONNEL TO LOCATE, IDENTIFY AND PROTECT EXISTING UNDERGROUND UTILITIES IN THE AREA OF WORK. ANY UTILITIES SPOTTED MUST BE DRAWN ON THE SITE PLAN PROVIDED BY THE ARCHITECT/ENGINEER AND SUBMITTED AS PART OF THE AS-BUILT DRAWINGS. COST OF GPR LOCATES MUST BE INCLUDED IN THE CONTRACTOR'S BASE BID. NOTIFY UTILITY AND ARCHITECT/ENGINEER OF CONFLICTS BETWEEN EXISTING AND PROPOSED FACILITIES
- THE CONTRACTOR IS RESPONSIBLE FOR INSTALLATION PRIOR TO CONSTRUCTION AND MAINTENANCE/REPAIRS DURING CONSTRUCTION OF SEDIMENT CONTROL MEASURES AS REQUIRED TO RETAIN ALL SEDIMENTS AND EROSION ON THE SITE OF DEVELOPMENT. THE PROVISIONS AS SHOWN HEREON REPRESENT THE MINIMUM EROSION CONTROL MEASURES TO BE TAKEN. THE CONTRACTOR IS RESPONSIBLE FOR INCLUDING ANY ADDITIONAL REQUIRED MEASURES IN HIS BASE BID OR PROVIDING ADDITIONAL MEASURES AS NECESSARY AT NO ADDITIONAL COST TO THE OWNER DURING CONSTRUCTION. IMPROPER SEDIMENT CONTROL MEASURES MAY RESULT IN CODE ENFORCEMENT VIOLATION
- 10. ALL ASPECTS OF THE STORM DRAINAGE COMPONENTS AND/OR TRANSPORTATION COMPONENTS MUST BE COMPLETED PRIOR TO ISSUANCE OF A FINAL CERTIFICATE OF OCCUPANCY.
- 11. ANY DAMAGE TO EXISTING ROADS, CURBS, SIDEWALKS, PARKING LOTS OR OTHER IMPROVEMENTS DURING CONSTRUCTION MUST BE REPAIRED BY THE CONTRACTOR PRIOR TO FINAL "AS-BUILT" SIGN-OFF FROM THE COUNTY AT NO ADDITIONAL COST TO THE OWNER.
- 12. THE CONTRACTOR MUST ARRANGE/SCHEDULE WITH THE COUNTY A FINAL INSPECTION OF THE DEVELOPMENT UPON COMPLETION AND ANY INTERMEDIATE INSPECTIONS AT (850) 595-3472. AS-BUILT CERTIFICATION IS REQUIRED PRIOR TO REQUEST FOR FINAL APPROVAL
- 13. THE CONTRACTOR MUST COMPLY WITH ALL FEDERAL AND STATE REGULATIONS CONCERNING NOTIFICATION TO THE REGULATORY AUTHORITIES OF ANY AND ALL BUILDING RENOVATIONS AND/OR DEMOLITION.
- 14. IT IS THE CONTRACTOR'S RESPONSIBILITY TO PROTECT ALL BENCHMARKS DURING CONSTRUCTION, INCLUDING ALL PUBLIC AND PRIVATE LAND CORNER MONUMENTATION. IF A PUBLIC OR PRIVATE CORNER IS IN DANGER OF BEING DISTURBED AND HAS NOT BEEN PROPERLY REFERENCED, THE CONTRACTOR WILL NOTIFY THE ENGINEER OF RECORD IMMEDIATELY. IF ANY MONUMENT IS DISTURBED OR DESTROYED THE CONTRACTOR WILL BE RESPONSIBLE FOR REPLACEMENT OF THE MONUMENT AT A LOCATION DETERMINED BY A FLORIDA LICENSED PROFESSIONAL SURVEYOR AND MAPPER USING GUIDELINES AS ESTABLISHED BY NATIONAL GEODETIC SURVEY FOR BLUE BOOKING AND APPROVAL
- 15. NO DEVIATIONS OR REVISIONS FROM THESE PLANS BY THE CONTRACTOR WILL BE ALLOWED WITHOUT PRIOR APPROVAL FROM BOTH THE DESIGN ENGINEER AND THE ESCAMBIA COUNTY, ANY DEVIATIONS MAY RESULT IN DELAYS IN OBTAINING A CERTIFICATE OF OCCUPANCY.
- 16. CONTRACTOR MUST MAINTAIN RECORD DRAWINGS DURING CONSTRUCTION WHICH SHOW "AS-BUILT" CONDITIONS OF ALL WORK INCLUDING PIPING, DRAINAGE STRUCTURES, TOPO OF POND(S), OUTLET STRUCTURES, DIMENSIONS, ELEVATIONS, GRADING ETC. RECORD DRAWINGS MUST BE PROVIDED TO THE ENGINEER OF RECORD PRIOR TO REQUESTING FINAL INSPECTION.
- 17. CONTRACTOR IS RESPONSIBLE FOR INSTALLATION OF A NEW IRRIGATION SYSTEM SUCH THAT COVERAGE IS PROVIDED TO ALL SODDED AREAS. SEE LANDSCAPING PLANS FOR DETAILS.
- 18. NOTIFY SUNSHINE UTILITIES 48 HOURS IN ADVANCE PRIOR TO DIGGING WITHIN R/W; 1-800-432-4770.
- PREVENT THE EXCAVATED POND FROM BLINDING DUE TO SEDIMENTS.

20. HE CONTRACTOR SHALL NOTIFY FDOT 48 HOURS IN ADVANCE PRIOR TO INITIATING ANY WORK IN THE STATE RIGHTS-OF-WAY.

19. THE CONTRACTOR SHALL CONTROL STORM WATER DURING ALL PHASES OF CONSTRUCTION AND TAKE ADEQUATE MEASURES TO

UTILITY COMPANIES:

TELEPHONE: AT&T / DISTRIBUTION **CENTURYLINK** DINO FARRUGGIO TANYA MARTINEZ (561) 683-2729 (251) 281-7584

ELECTRIC: FIBER/COMM. FLORIDA POWER & LIGHT MCI / VERIZON **USIC DISPATCH** THOMAS BROYLES (800) 778-9140 (820) 475-7465

NATURAL GAS: PENSACOLA ENERGY **QUANTA TELECOM** DIANE MOORE RUSSELL RIBBLETT (850) 474-5319 (678) 836-5610

WATER/SEWER: **EMERALD COAST UTILITY AUTHORITY BRANDON KNIGHT** (850) 969-6650

UNITI FIBER LLC MICHAEL MCCARTY (251) 214-7793

SITE DATA SUMMARY

PROP. REF. NO. 1 02-1S-30-0601-000-017 STREET ADDRESS 9720 DAVIS HWY 32514 **CURRENT USE** WAREHOUSE, DISTRIBUTION PROPOSED USE STORAGE (PROPERTY OWNER ONLY) **ZONING / FLU** COM / MU-U (MIXED USE-URBAN) PARCEL AREA 1.8150 ACRE (±79,061 SF)

PROP. REF. NO. 2 02-1S-30-0601-000-016 STREET ADDRESS **CURRENT USE** VACANT COMMERCIAL PROPOSED USE VACANT COMMERCIAL COM / MU-U (MIXED USE-URBAN) **ZONING / FLU** PARCEL AREA 1.3861 ACRE (±60,379 SF)

SETBACKS AND BUFFERS BUILDING

> FRONT SIDE REAR

LANDSCAPE DISSIMILAR USE - 12' TYPE A BUFFER

(EX. FENCE AND VEGETATION SATISFY REQUIREMENTS) WETLANDS 25' INLAND

RIVERINE 30' INLAND

±5.256 SF (GARAGE/STORAGE) **BUILDING AREA** PARKING N/A - PRIVATE USE ONLY

STORMWATER CALCS. TOTAL PROJECT AREA

10,546 SF (100%) PRE-DEVELOPMENT PERVIOUS 7,167 SF (68%)

IMPERVIOUS 3,379 SF (32%)

POST-DEVELOPMENT

9,746 SF (92%) CONTRIBUTING 3,388 SF (32%) PERVIOUS **IMPERVIOUS** 6,358 SF (60%)

NON-CONTRIBUTING 800 SF (8%) **IMPERVIOUS** 800 SF (8%)

WETLANDS INFORMATION


TOTAL WETLANDS AREA $= 43,473 \text{ SF } (\pm 0.998 \text{ AC})$ IMPACTED WETLANDS = 0 SF (±0.009 AC) PRESERVED WETLANDS = $43,473 \text{ SF } (\pm 0.998 \text{ AC}) 100\%$ TOTAL BUFFER AREA $= 20,308 \text{ SF } (\pm 0.466 \text{ AC})$ IMPACTED 25' BUFFER = 1,226 SF ($\pm 0.028 \text{ AC}$) PRESERVED 25' BUFFER = $19,082 \text{ SF } (\pm 0.438 \text{ AC})$

MERS SETBACK (30')

TOTAL MERS AREA $= 17,410 \text{ SF } (\pm 0.400 \text{ AC})$ IMPACTED MERS AREA = 1.057 SF (±0.024 AC)

FLOOD ZONE

THE SUBJECT PROPERTY AS SHOWN HEREON IS LOCATED IN FLOOD ZONE X. (MINIMAL RISK AREAS OUTSIDE THE 1-PERCENT AND 0.2-PERCENT-ANNUAL-CHANCE FLOODPLAINS. NO BFEs OR BASE FLOOD DEPTHS ARE SHOWN WITHIN THESE ZONES), AS DETERMINED FROM THE FEDERAL EMERGENCY MANAGEMENT AGENCY FLOOD INSURANCE MAP OF ESCAMBIA COUNTY, FLORIDA, COMMUNITY 120080, FIRM MAP PANEL NUMBERS 12033C0315G, MAP REVISION DATED SEPTEMBER 29, 2006.

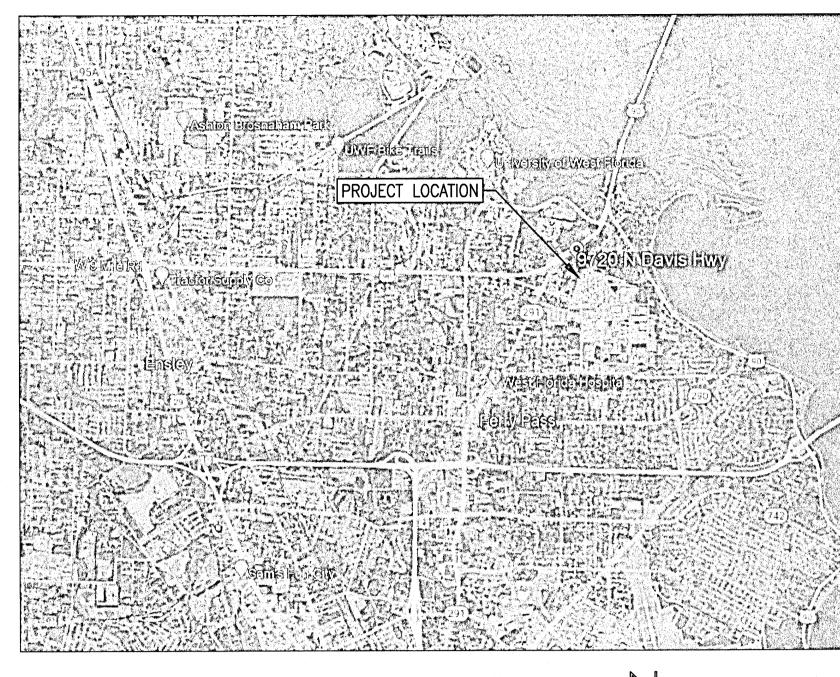



VICINITY MAP SECTION 02, TOWNSHIP 1S, RANGE 30W PROPERTY OWNER/DEVELOPER RON BROWN 4125 MONTEIGNE DR

PENSACOLA, FL 32504

SHEET LIST TABLE		
SHEET LIST TABLE		
SHEET TITLE		
NOTES & INFORMATION		
EXISTING CONDITIONS PLAN		
PROTECTED TREE & WETLANDS MAP		
DEMOLITION PLAN		
IMPROVEMENTS PLAN		
GRADING PLAN		
LANDSCAPING PLAN		
EROSION CONTROL DETAILS		
SITE DETAILS		

Approved
ESCAMBIA COUNTY DRC PLAN REVIEW This document has been reviewed in accordance with the requirements of applicable Escambia County Regulations and Ordinances, and does not in any way relieve the submitting Architect, Engineer, Surveyor or other signatory from responsibility of details as drawn. A Development Order (DO) must be obtained through the Development Review Process prior to the commencement of construction. This DO approval does not constitute approval by any other agency. All additional state/federal permits shall be provided to the county prior to approval of a final plat or the issuance of state/federal permits shall be provided to the county prior to approval of a final plat or the issuance of a building permit.

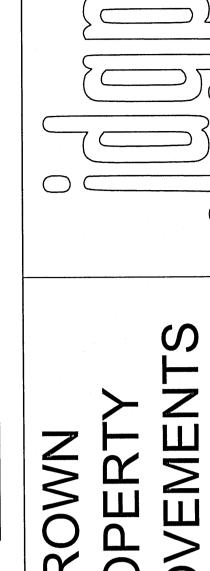

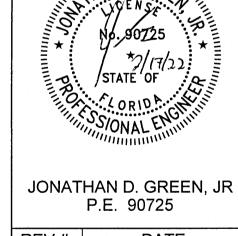



REV #: DATE: **DESIGNED BY: JDG** JOB NO.: 22008 DATE: 2022-02-16 SCALE: AS SHOWN


PERMIT SET


STATUS:

SHEET NO .:

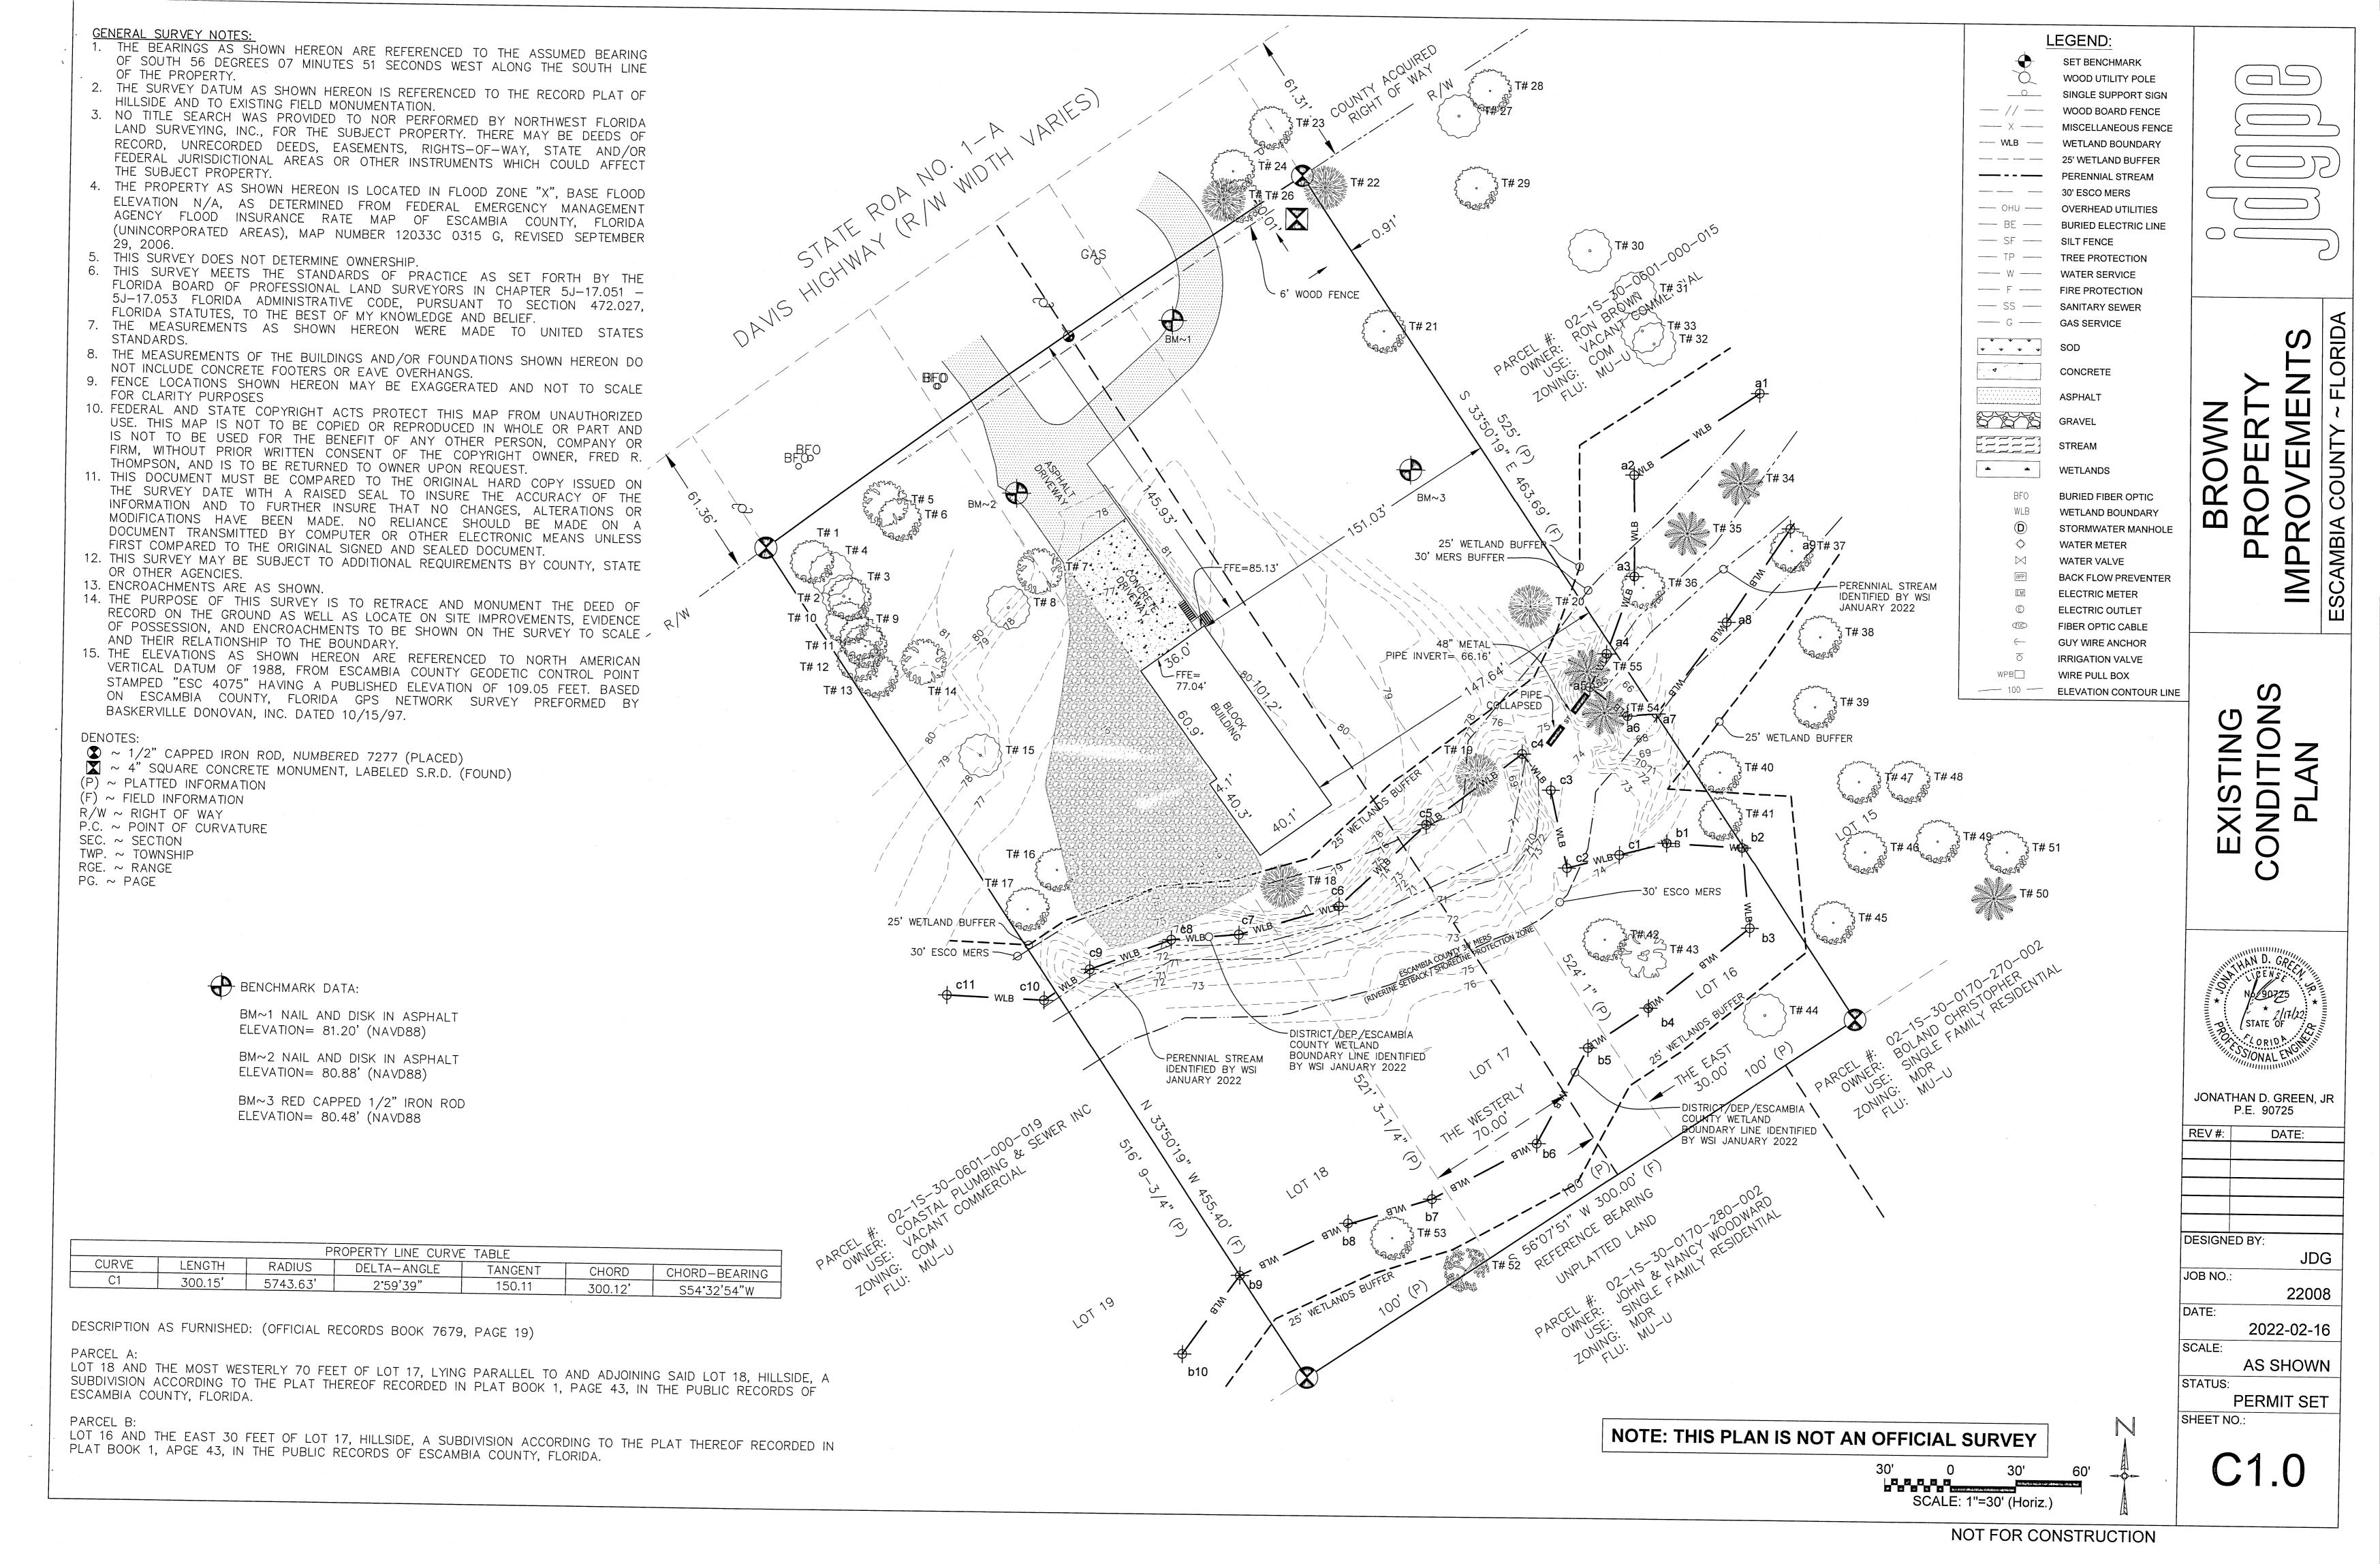


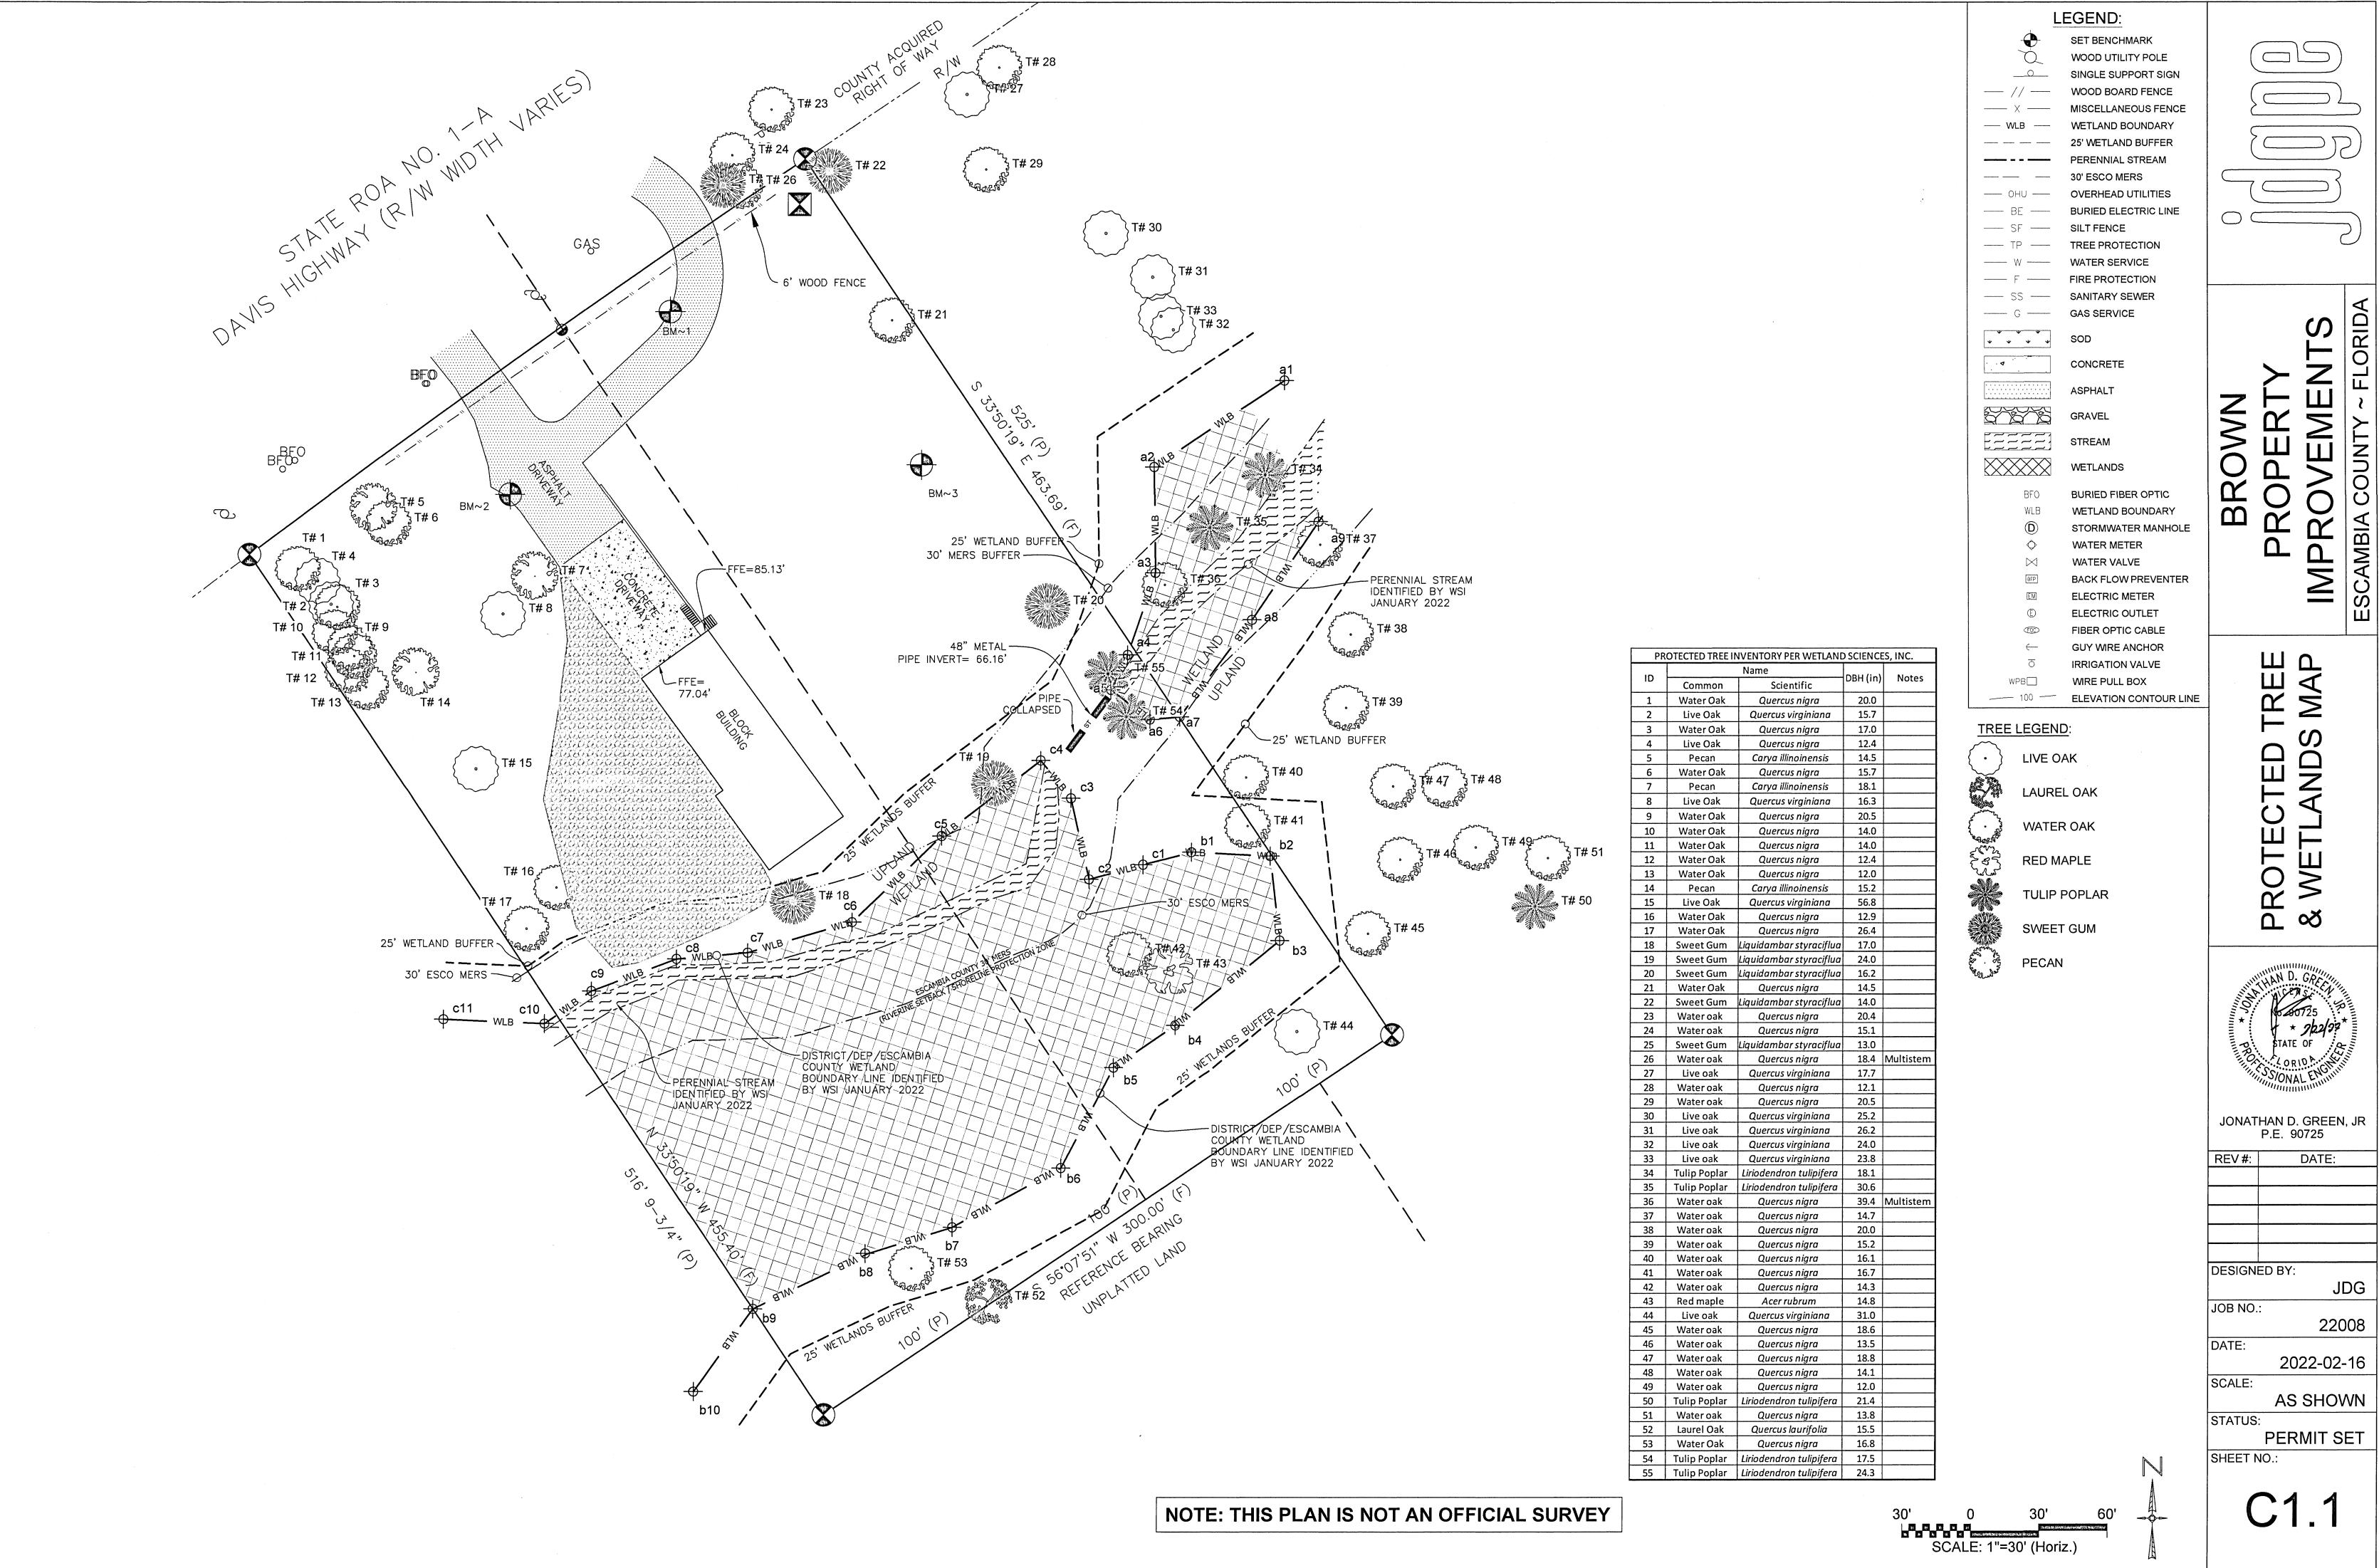


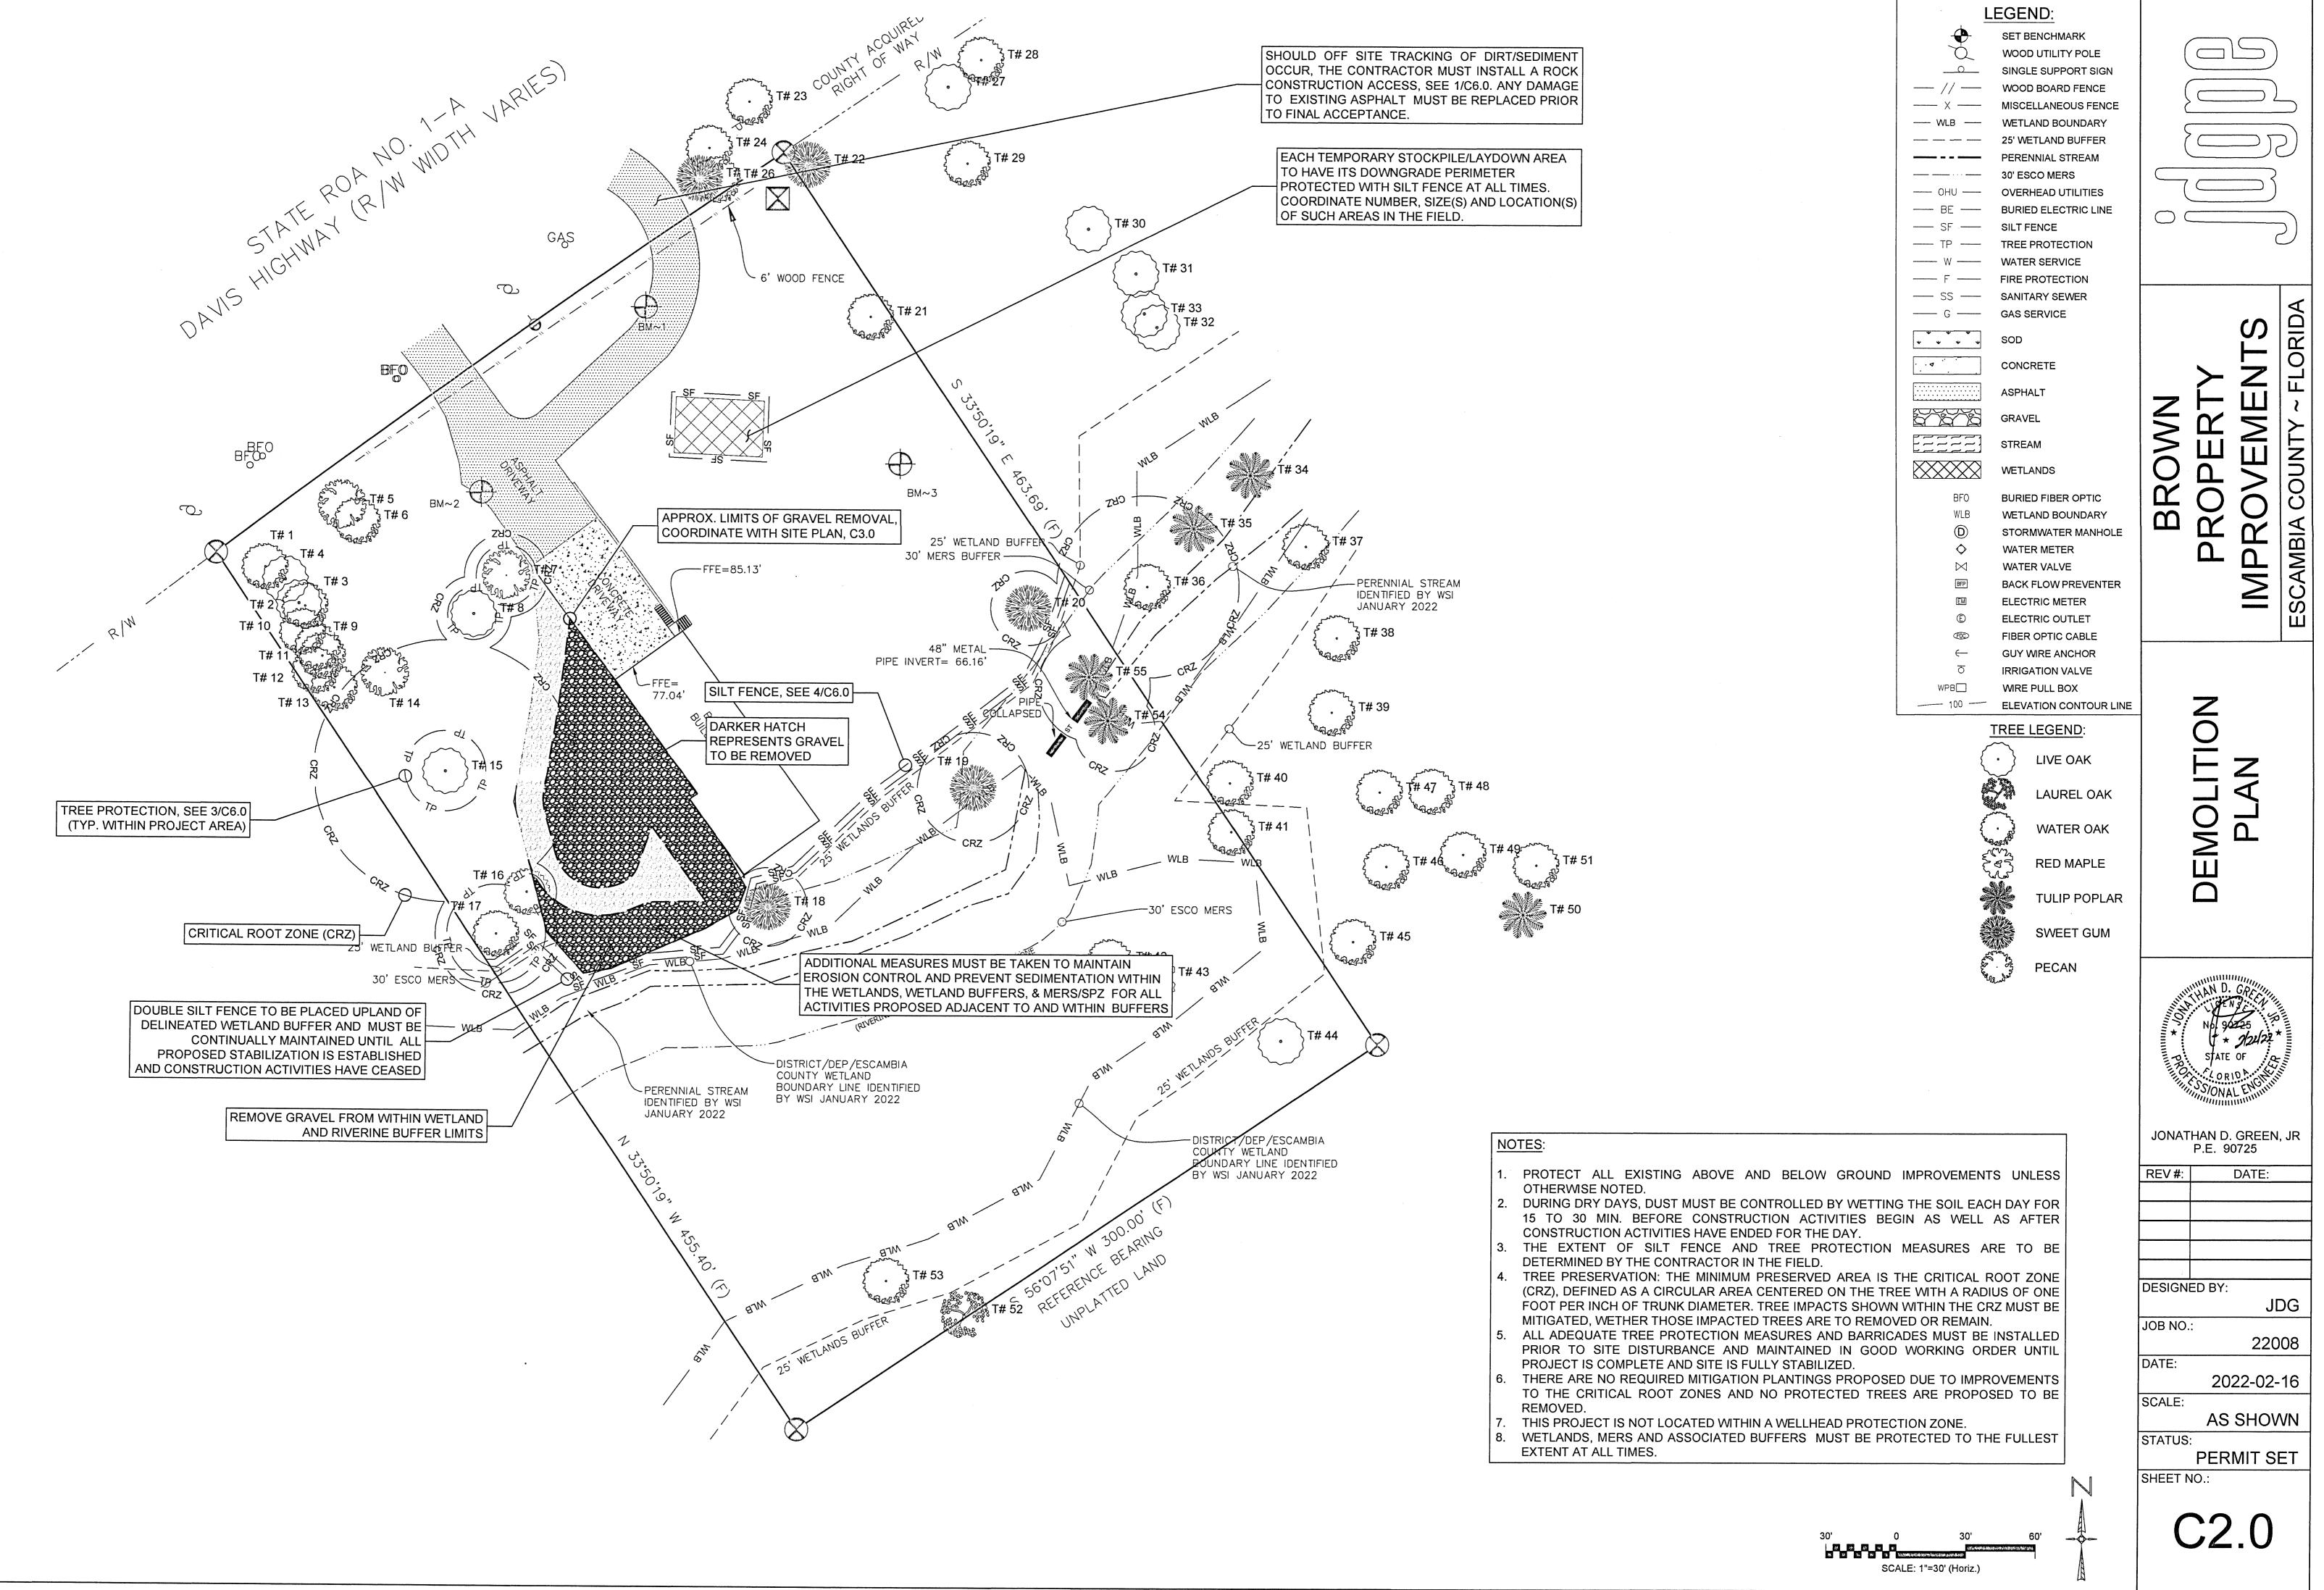

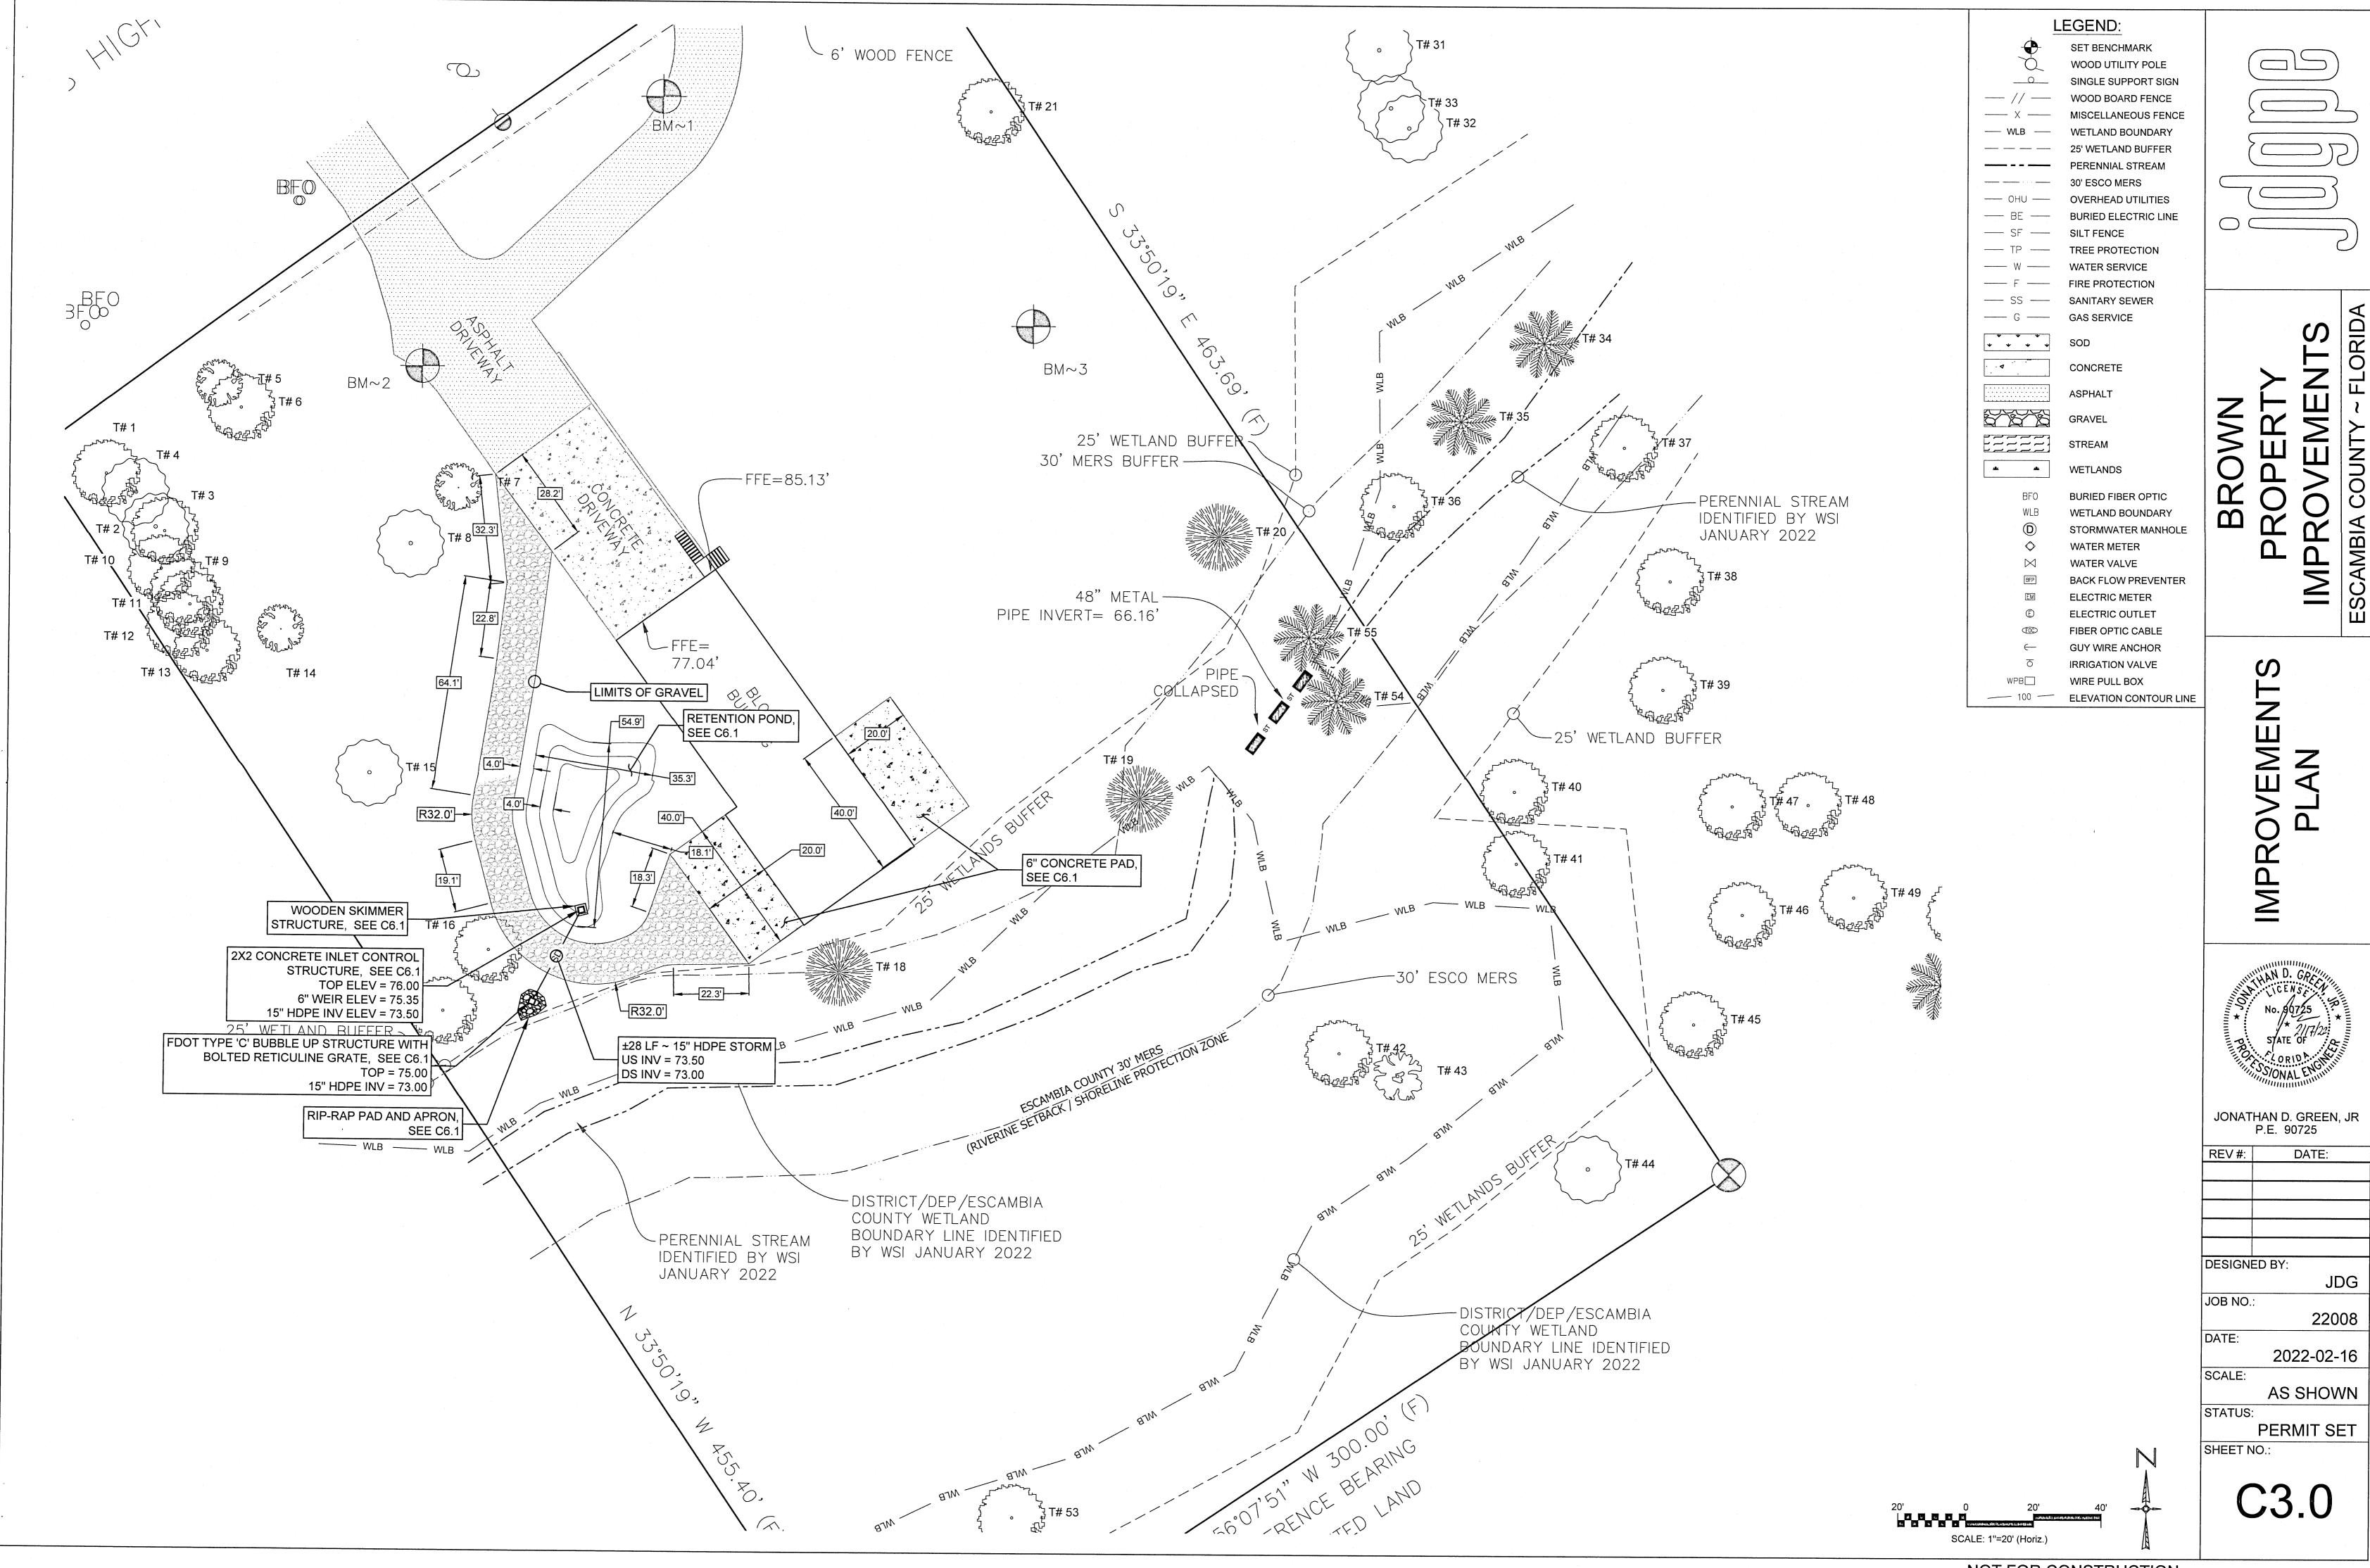

NOT FOR CONSTRUCTION

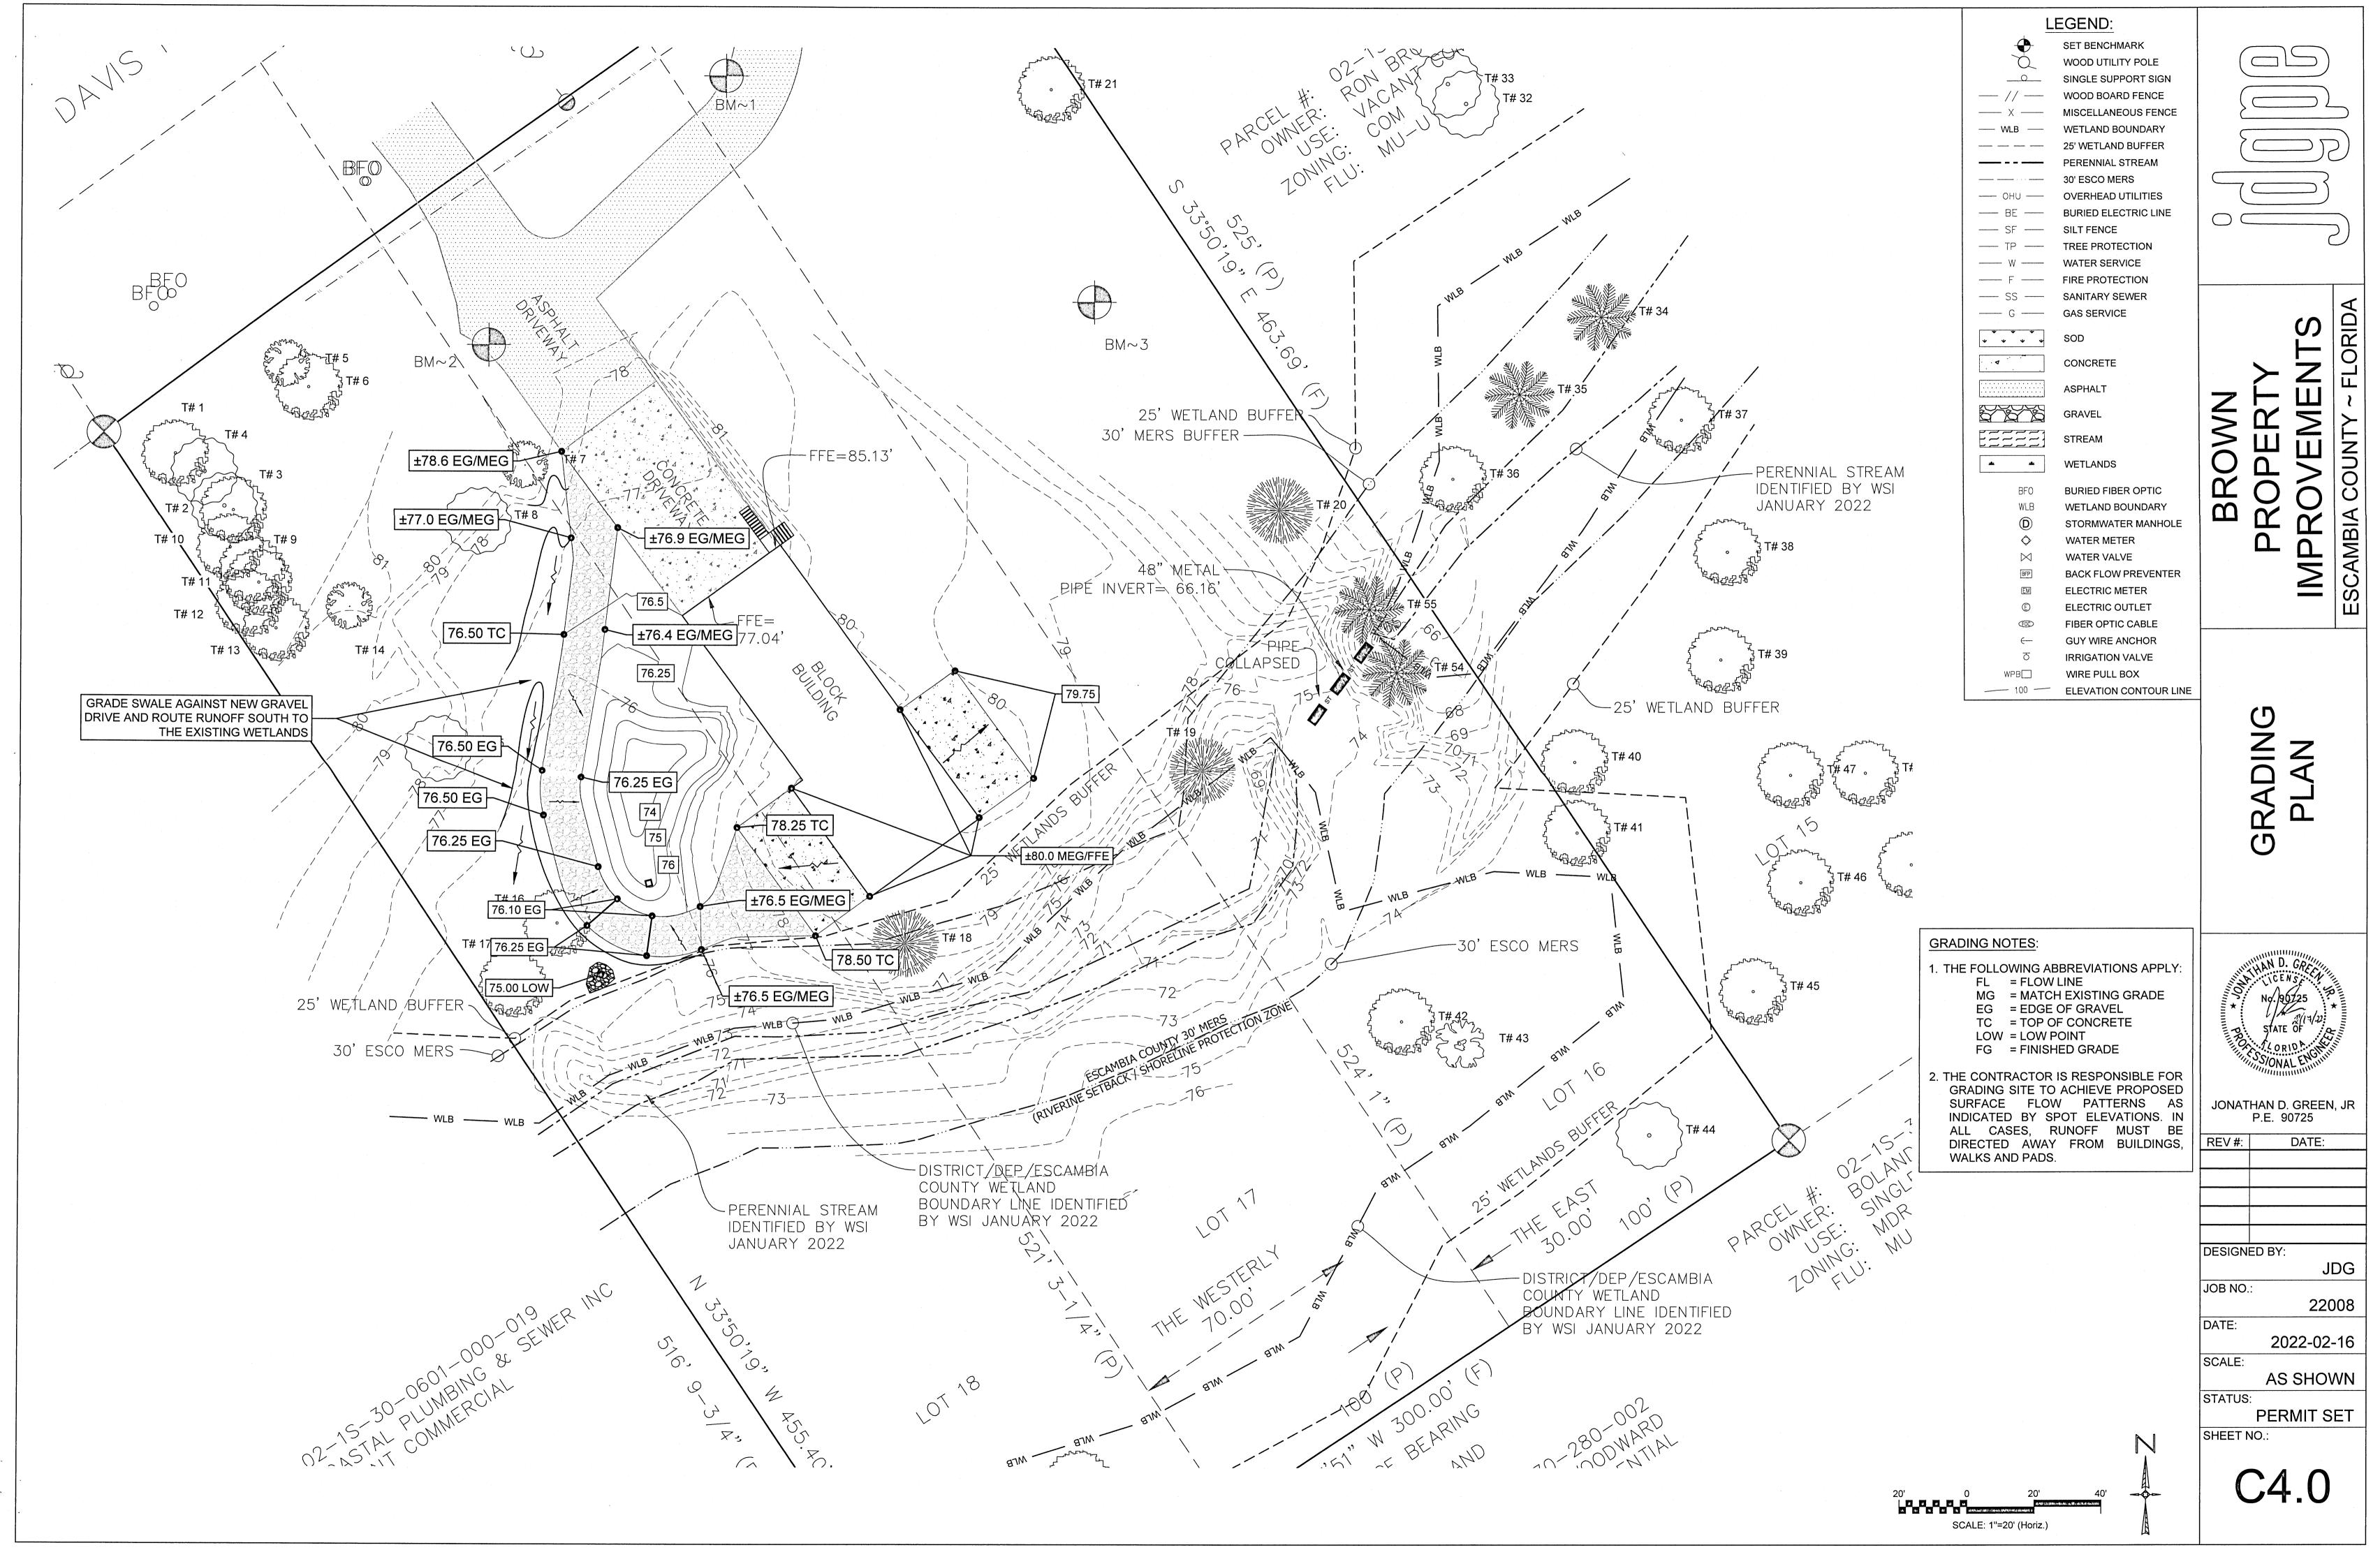

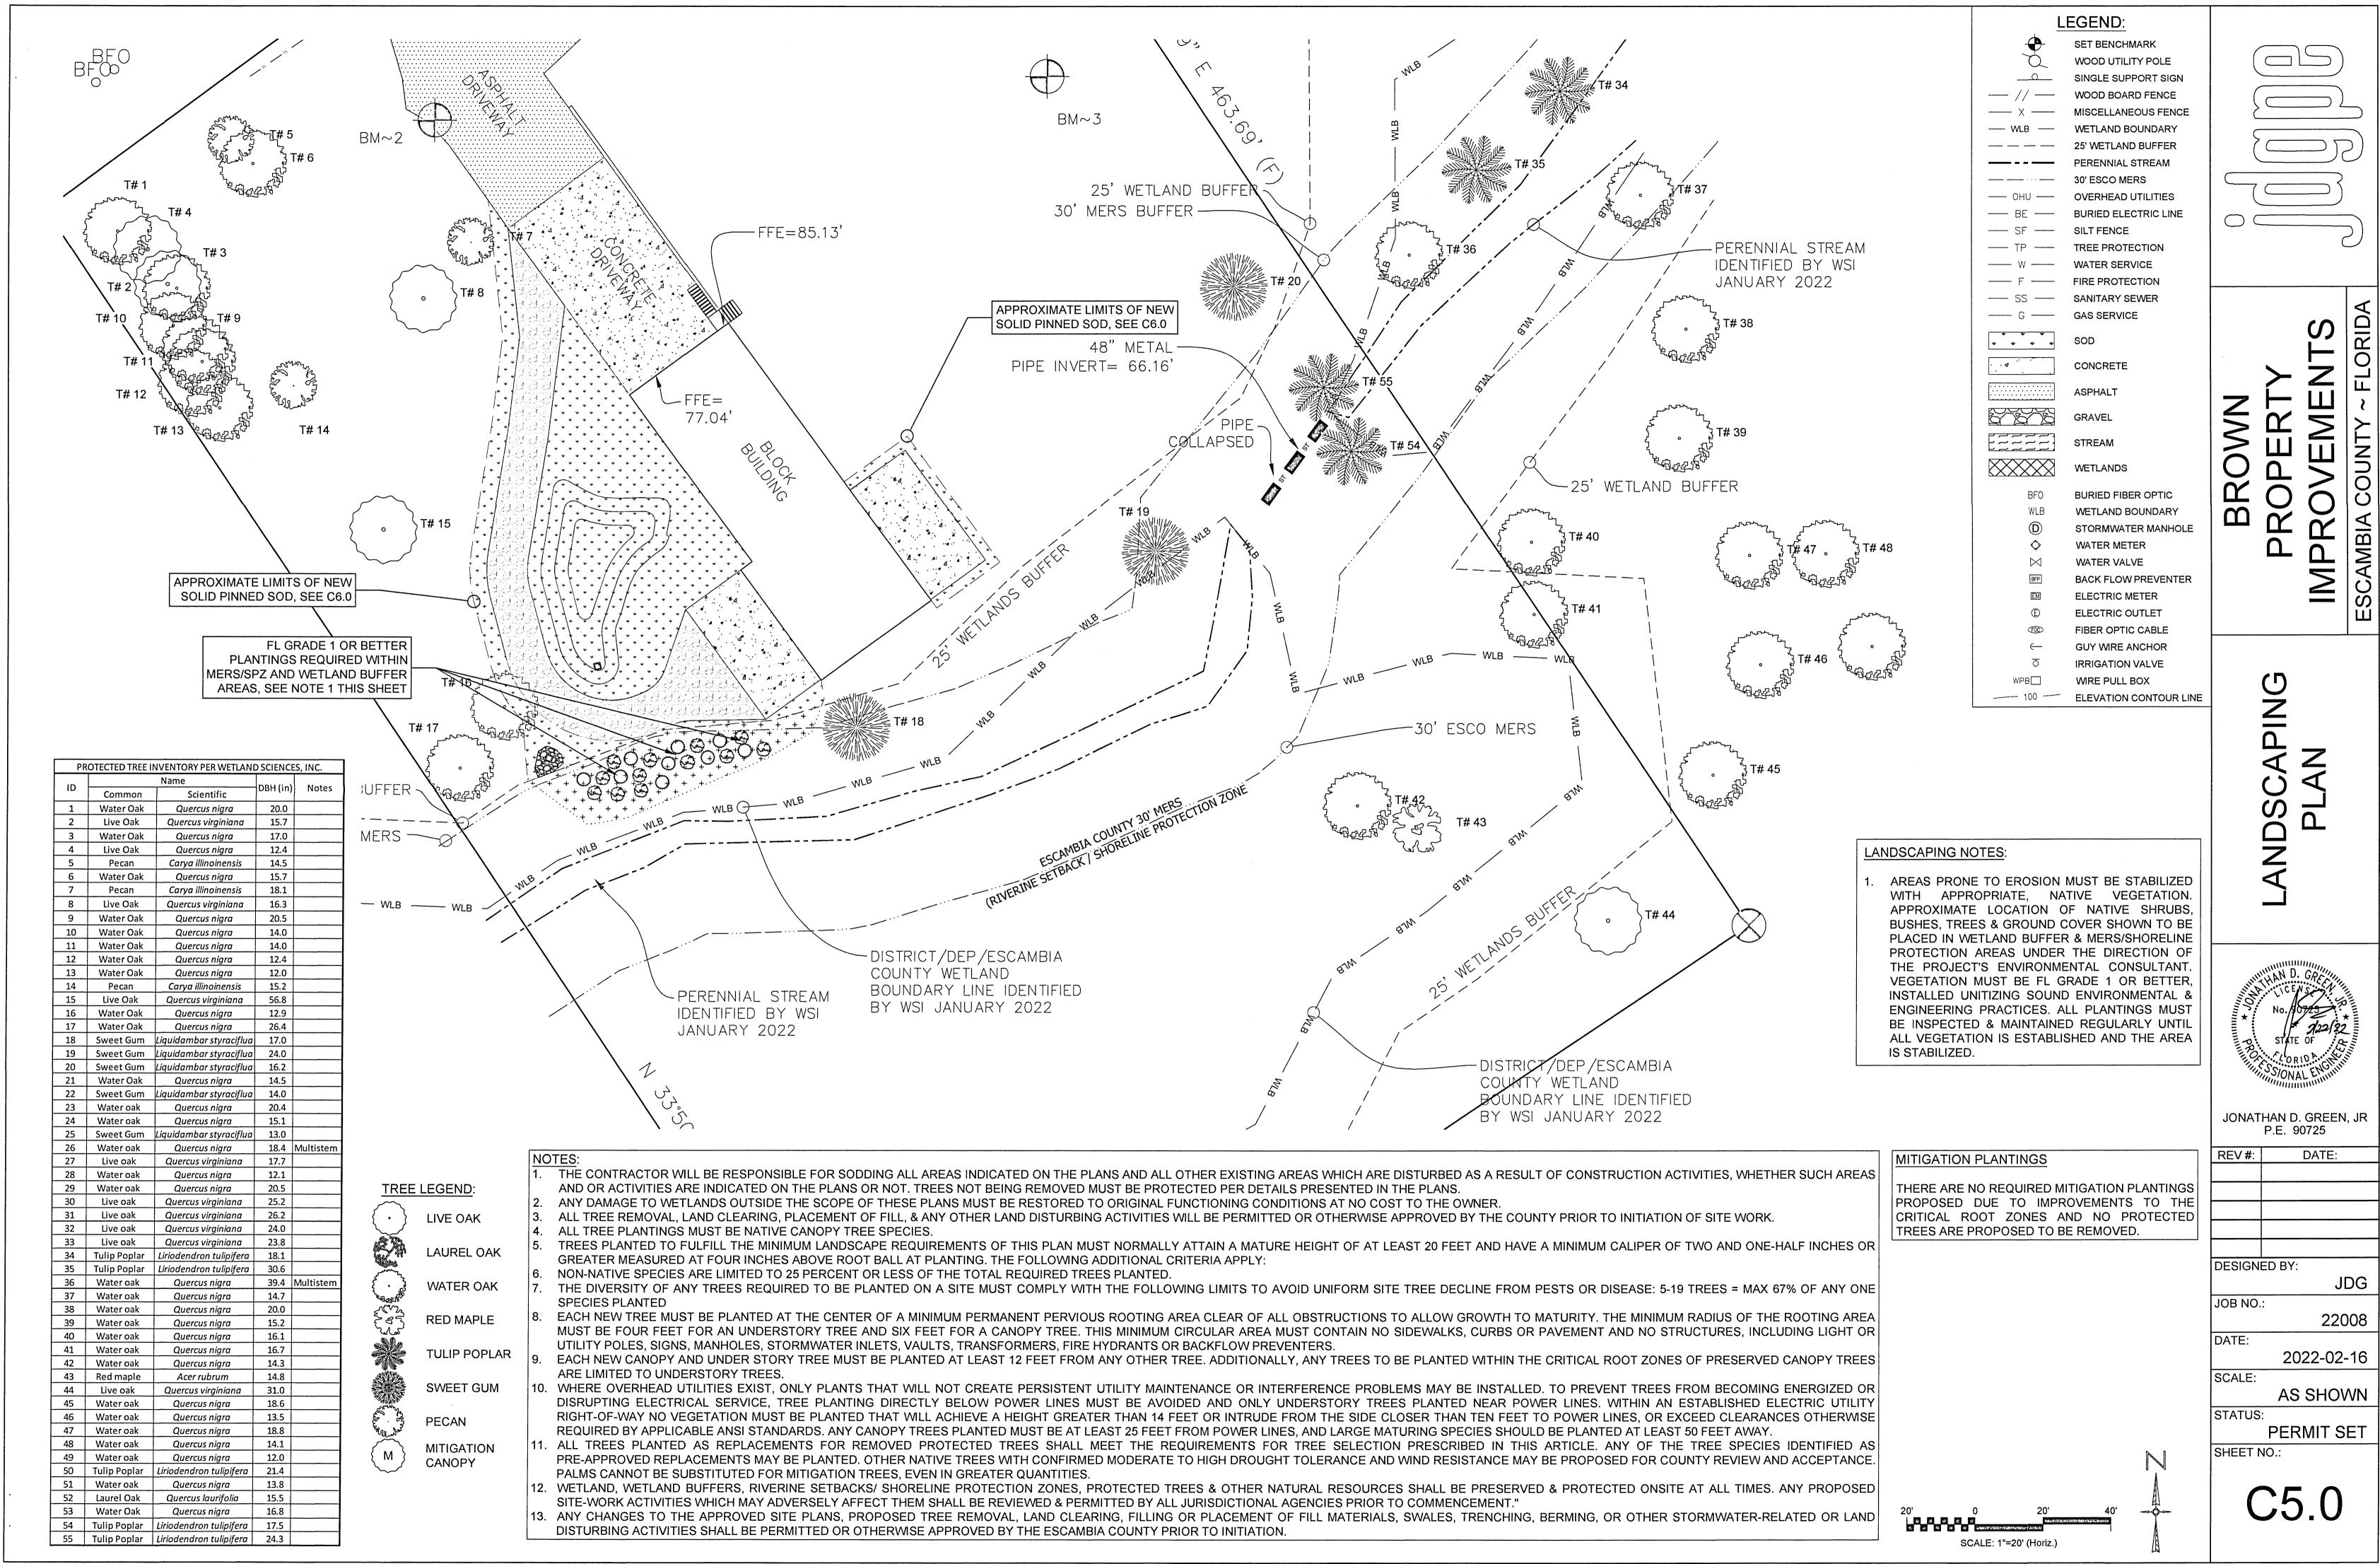


NOTES

- CONSTRUCTION ENTRANCES PROVIDE AN AREA WHERE MUD CAN BE REMOVED FROM VEHICLE TIRES BEFORE THEY LEAVE THE CONSTRUCTION SITE. THE MOTION OF THE VEHICLE AS IT MOVES OVER THE GRAVEL CONSTRUCTION MATERIAL DISLODGES CAKED MUD.
- 2. IF THE ACTION OF THE VEHICLE ON THE GRAVEL PAD IS NOT SUFFICIENT TO DISLODGE MUD, THEN THE TIRES MUST BE WASHED BEFORE THE VEHICLE LEAVES THE SITE.
- 3. UTILIZE GRAVEL, 2"-3" (MIN.) IN DIAMETER. GRAVEL LAYER SHOULD BE AT LEAST 6" THICK. THE PAD SHOULD BE AT LEAST 50' LONG. WIDTH SHOULD BE APPROPRIATE TO VEHICLE SIZE.

ROCK CONSTRUCTION ACCESS

NOT TO SCALE

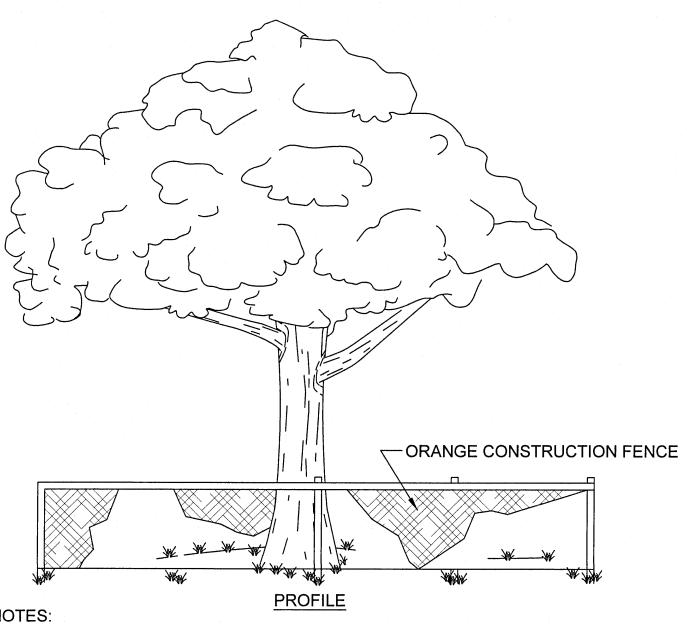

1. FOR TEMPORARY USE DURING CONSTRUCTION. BARRICADE SHALL BE PLACED PRIOR TO ANY LAND DISTURBANCE.

2. NONE OF THE FOLLOWING ACTIVITIES SHALL OCCUR WITHIN THE TREE PROTECTION BARRICADE: DRIVING, PARKING, STORING MATERIALS, DUMPING WASTE, CONCRETE WASHOUT, ADDING FILL SOIL, TRENCHING, REMOVING SOIL OR GRUBBING OR ANY OTHER LAND DISTURBANCE ACTIVITIES AS DEFINED IN THE LDC.

TREE PROTECTION
NOT TO SCALE


TURN DOWN EDGE OF SOD AT THE TOP OF SLOPES AND PLACE LAYER OF COMPACTED (DIRECTION(EARTH TO CONDUCT WATER OVER AND ON TOP OF OF THE SOD **FLOW** CONCRETE OR _ TOP OF SOD SHALL BE OTHER HARD INSTALLED FLUSH WITH -SURFACE ADJACENT SURFACES manner TOP SOIL AND ROOT MASS **STAGGERED** COMPACTED LANDSCAPING PIN **VERTICAL JOINTS** SUBGRADE -WITH NO GAPS <u>SECTION</u> **BETWEEN PIECES**

1. SEE WRITTEN SPECIFICATIONS FOR FULL DETAILS.

- PLACE SOD BEGINNING AT THE TOE OF THE SLOPE AND LONG EDGE PERPENDICULAR TO DIRECTION OF FLOW.
 SOD SHALL BE PINNED ON ALL SLOPES 4:1 OR STEEPER, IN AREAS OF CONCENTRATED DRAINAGE FLOWS, AND ANYWHERE THAT THERE IS DANGER OF SOD SLIPPING.
- 4. INSTALL SOD EDGES FLUSH WITH FINISHED GRADE OR ADJOINING SOD

SODDING DETAIL

NOT TO SCALE

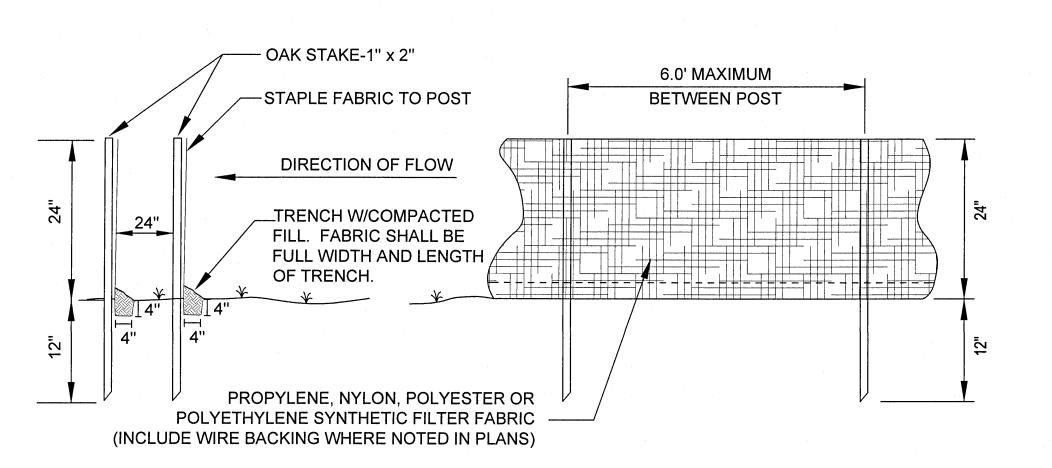

FENCE SECTION

FENCE ELEVATION

SILTATION FENCE
NOT TO SCALE

GENERAL NOTES FOR EROSION AND SEDIMENT CONTROL

- 1. CONTRACTOR WILL BE RESPONSIBLE FOR THE INSTALLATION (PRIOR TO CONSTRUCTION) AND MAINTENANCE/REPAIRS OF (DURING CONSTRUCTION) EROSION AND SEDIMENT CONTROL MEASURES AS REQUIRED TO RETAIN ALL SEDIMENT AND EROSION ON THE SITE OF DEVELOPMENT. THE PROVISIONS SHOWN HEREIN REPRESENT THE MINIMUM EROSION CONTROL MEASURES TO BE TAKEN.
- 2. ALL SOIL WASHED, DROPPED, SPILLED, OR TRACKED OUTSIDE THE SITE OR ONTO PUBLIC RIGHTS-OF-WAY WILL BE REMOVED IMMEDIATELY.
- 3. ALL AREAS OF DISTURBANCE MUST BE TREATED AS APPROPRIATE TO PREVENT THE GENERATION OF DUST.
- 4. AT THE TIME OF SITE PREPARATION FOR PERMANENT VEGETATIVE STABILIZATION, ANY SOIL THAT WILL NOT PROVIDE A SUITABLE ENVIRONMENT TO SUPPORT PERMANENT COVER MUST BE REMOVED OR TREATED IN SUCH A WAY THAT WILL PERMANENTLY ADJUST THE SOIL CONDITIONS AND RENDER IT SUITABLE FOR PERMANENT COVER. IF THE REMOVAL OR TREATMENT OF THE SOIL WILL NOT PROVIDE SUITABLE CONDITIONS, NON-VEGETATIVE MEANS OF PERMANENT GROUND STABILIZATION MUST BE EMPLOYED (I.E. EROSION CONTROL FABRIC, RIP-RAP, ETC.).
- THE CONTRACTOR MUST MAKE REGULAR INSPECTIONS OF ALL CONTROL MEASURES THROUGHOUT THE CONSTRUCTION PROCESS TO ENSURE THE OVERALL EFFECTIVENESS OF THE EROSION AND SEDIMENT CONTROL PLAN. AT A MINIMUM, INSPECTIONS MUST OCCUR AT LEAST ONCE A WEEK AND WITHIN TWENTY-FOUR (24) HOURS OF THE END OF A STORM EVENT THAT IS ONE-HALF (0.50) INCH OR GREATER.

IN THE EVENT THAT AN ON-SITE INSPECTION BY ANY PARTY REVEALS A DEFICIENCY IN THE INSTALLATION AND/OR MAINTENANCE OF EROSION AND SEDIMENT CONTROL MEASURES, THE CONTRACTOR MUST BE RESPONSIBLE FOR THE IMMEDIATE REMEDIATION OF THE PROBLEM.

7. FAILURE TO COMPLY WITH THE REQUIRED EROSION AND SEDIMENT CONTROL GUIDELINES MAY RESULT IN FINES LEVIED BY GOVERNMENTAL AGENCIES. ANY FINES SUFFERED DUE TO NON-COMPLIANCE WILL BECOME THE RESPONSIBILITY OF THE CONTRACTOR.

SEQUENCE OF EROSION AND SEDIMENT CONTROL MEASURES IMPLEMENTATION SITE PREPARATION

- 1. PRIOR TO ANY SOIL DISTURBANCE, SILT FENCE MUST BE INSTALLED ALONG ENTIRE DOWN-GRADE PERIMETER OF PROJECT AREA, AS SHOWN IN PLANS AND DETAILS, OR BY EQUIVALENT MEASURES. SILT FENCE MUST REMAIN IN PLACE UNTIL ALL UP-GRADE AREAS OF DISTURBANCE HAVE BEEN PERMANENTLY STABILIZED.
- 2. A PROPER CONSTRUCTION ENTRANCE MUST BE ESTABLISHED AT ALL POINTS OF INGRESS/EGRESS FROM CONSTRUCTION SITE, PER DETAIL PROVIDED IN THE PLANS, OR BY EQUIVALENT MEASURES. ALL CONSTRUCTION ENTRANCES MUST REMAIN IN PLACE UNTIL INGRESS/EGRESS FROM THE SITE AT THAT POINT HAS STOPPED.

CLEARING AND GRUBBING

- 1. ALL DISTURBED AREAS THAT WILL BE LEFT EXPOSED FOR MORE THAN FOURTEEN (14) DAYS, AND ARE NOT SUBJECT TO CONSTRUCTION TRAFFIC, MUST RECEIVE A TEMPORARY SEEDING IMMEDIATELY UPON DISTURBANCE. IF THE SEASON PREVENTS ESTABLISHMENT OF A TEMPORARY COVER, THE DISTURBED AREA MUST BE MULCHED WITH STRAW, OR EQUIVALENT MATERIAL, AT A RATE OF TWO (2) TONS PER ACRE.
- 2. ALL DISTURBED AREAS THAT ARE SUBJECT TO HIGH AMOUNTS OF EROSION (I.E. STEEP SLOPES, EMBANKMENTS GREATER THAN 3:1, OR OTHER AS DICTATED BY SITE CONDITIONS) MUST IMMEDIATELY RECEIVE A TEMPORARY SEEDING IN COMBINATION WITH MULCHING WITH STRAW, OR EQUIVALENT MATERIAL, AT A THICKNESS OF TWO (2) TO FOUR (4) INCHES MIXED WITH THE TOP TWO (2) INCHES OF SOIL.
- 3. ALL DISTURBED AREAS MUST, AS A MINIMUM, BE MAINTAINED BY WATER TO MINIMIZE THE GENERATION OF DUST.

SITE GRADING


- 1. THE SITE MUST, AT ALL TIMES, BE GRADED AND MAINTAINED SUCH THAT ALL STORM WATER RUNOFF IS CONTROLLED BY EROSION AND SEDIMENT CONTROL MEASURES.
- 2. ALL AREAS USED FOR MATERIAL STOCKPILE, BE IT FILL/EXCAVATED MATERIALS, STONE, OR OTHERWISE, ARE TO BE STABILIZED, AND MUST HAVE SILT FENCE INSTALLED PER THE DETAILS PROVIDED IN THE PLANS, OR BY EQUIVALENT MEASURES, AROUND THEIR ENTIRE DOWNGRADE PERIMETER.

INSTALLATION OF STORM SEWER AND UTILITIES

- 1. TEMPORARY OUTLET PROTECTION MUST BE INSTALLED AT ALL STORM WATER OUTFALLS PRIOR TO THE INSTALLATION OF THE DRAINAGE SYSTEM.
- 2. ALL SITE DRAINAGE, INCLUDING ROOF DRAINS, DOWN SPOUTS, GUTTERS, OR OTHERWISE MUST BE ROUTED TO CARRY ALL STORM WATER TO THE PROPOSED STORM WATER MANAGEMENT INFRASTRUCTURE.
- 3. ANY SLOPES GREATER THAN 3:1 (H:V) RECEIVING PIPELINE OR UTILITY INSTALLATION MUST BE BACKFILLED AND STABILIZED DAILY AS THE INSTALLATION PROCEEDS.


FINAL SITEWORK

- PERMANENT VEGETATION (I.E. SEED AND MULCH, SOD, ETC) MUST BE INSTALLED ON ALL EXPOSED AREAS WITHIN TEN (10) DAYS AFTER FINAL GRADING.
- UPON COMPLETION OF CONSTRUCTION, BUT PRIOR TO FINAL ACCEPTANCE, ALL CONSTRUCTION WASTE AND DEBRIS MUST BE REMOVED FROM THE SITE AND ALL PAVED ROADWAYS AND/OR PARKING AREAS MUST BE SWEPT CLEAN OF ALL SEDIMENT.
- TEMPORARY EROSION AND SEDIMENT CONTROL MEASURES MUST REMAIN IN PLACE AND BE MAINTAINED UNTIL SUCH TIME WHEN ALL UP-GRADE AREAS HAVE BEEN PERMANENTLY STABILIZED.

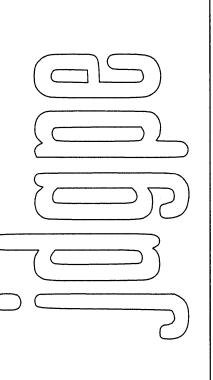

BROWN
PROPERTY
PROVEMENTS

EROSION CONTROL DETAILS

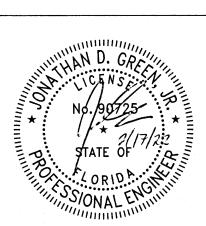

JONATHAN D. GREEN, JR

1 .2. 33723	
REV#:	DATE:

DESIGNED BY:

JDG

JOB NO.:

22008


DATE:

2022-02-16

SCALE:

AS SHOWN
STATUS:
PERMIT SET

SHEET NO .:

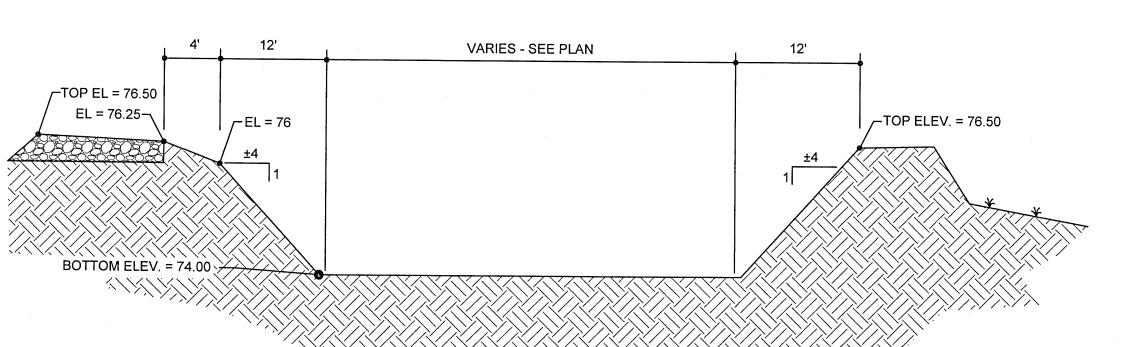


ALL PHASES OF CONSTRUCTION AND TAKE ADEQUATE MEASURES TO PREVENT THE EXCAVATED POND FROM BLINDING DUE TO SEDIMENTS ACCUMULATION

SIDES AND BOTTOM OF STORM WATER POND MUST BE IMMEDIATELY STABILIZED WITH SOD UPON CONSTRUCTION. UPON FINAL COMPLETION OF CONSTRUCTION AND STABILIZATION OF ALL UPSTREAM AREAS, POND MUST BE

RE-SHAPED AS NECESSARY TO REMOVE ACCUMULATED SEDIMENT AND TO MATCH THE PROPOSED GRADING ON THE PLANS. ALL DISTURBED AREAS MUST BE RE-STABILIZED WITH SOD

RETENTION POND

NOT TO SCALE

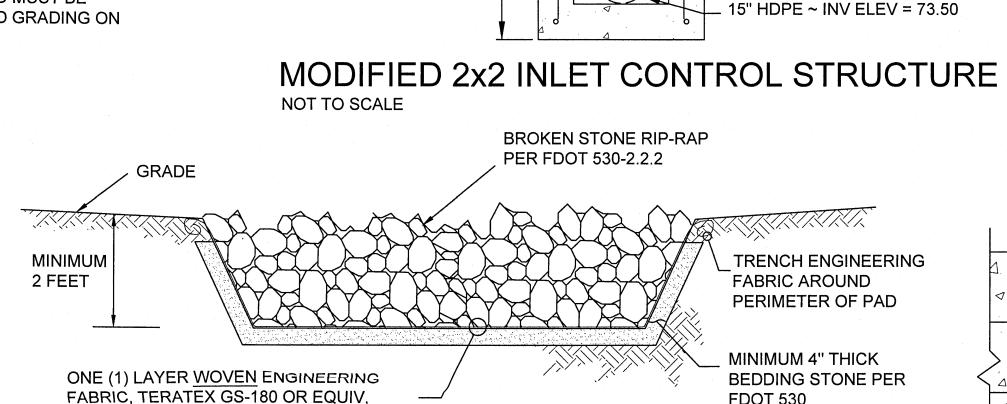

1/2" X 1/2" (TYP)

OPEN TOP ELEV = 76.00

HEAVY-DUTY CAST IRON INLET

GATE, U.S. FOUNDARY #6196

#4 @ 12" O.C. EACH WAY

4" WEIR ~ INV ELEV = 75.35

RAMNECK SEALANT

FDOT 530

3'-0"


RIP-RAP TO EXTEND UP POND EMBANKMENT TO FORM APRON AROUND CONCRETE **END SECTIONS AT PIPE INPUT LOCATIONS**

2. RIP-RAP PAD SHALL NOT BE BROKEN CONCRETE, BROKEN STONE SHALL BE ROUGHLY ANGULAR AND FREE FROM THIN OR ELONGATED PIECES


3. TOP OF RIP-RAP SHALL BE FLUSH WITH FINISHED GRADES.

FULL LENGTH AND WIDTH


RIP-RAP PAD

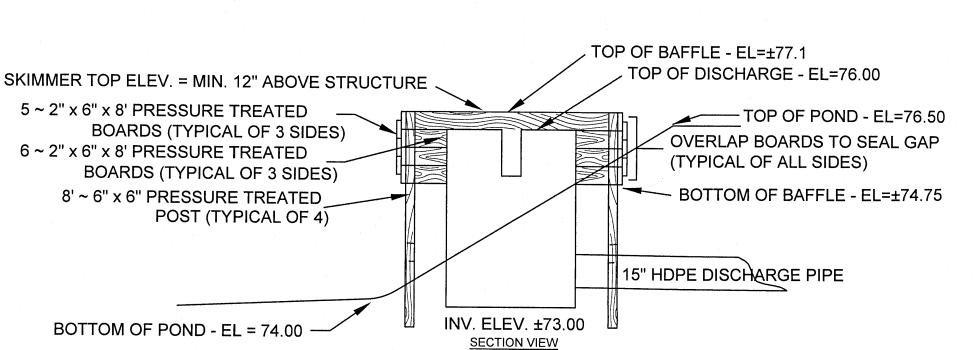


SKIMMER STRUCTURE DETAIL

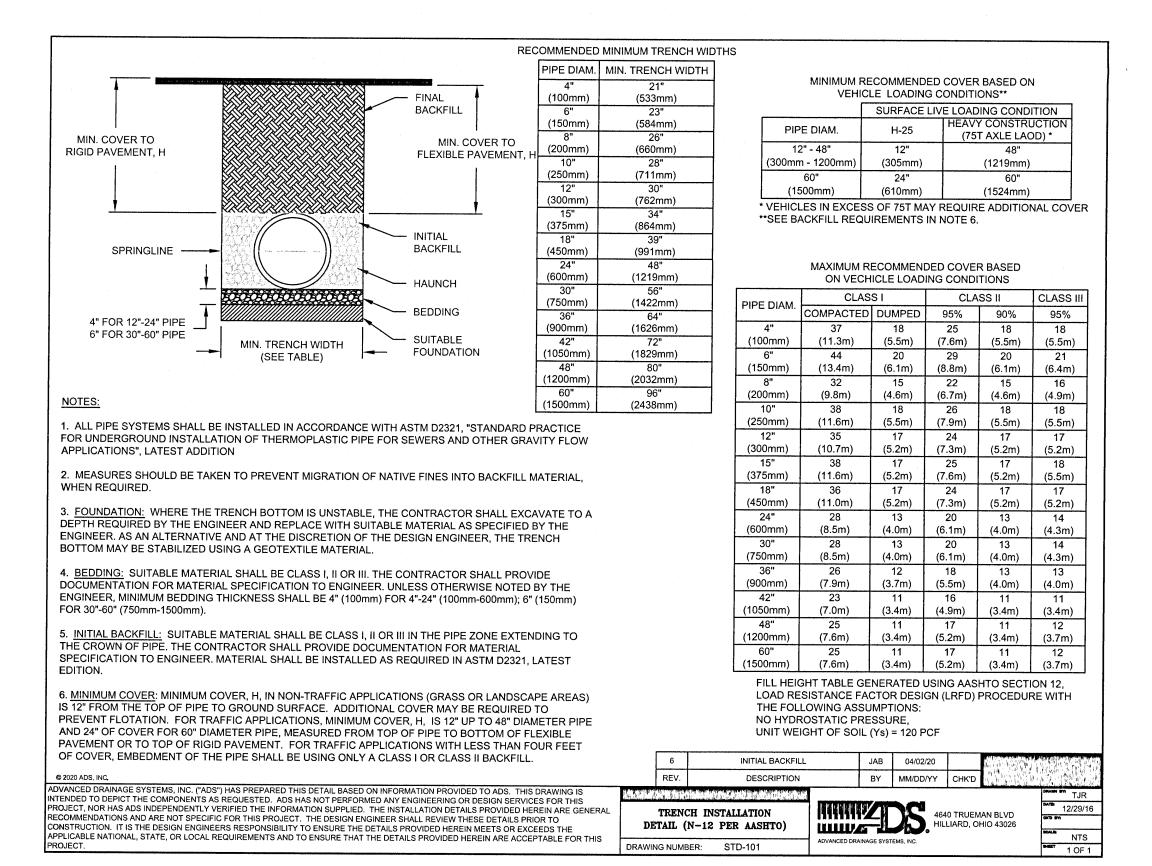

HDPE TRENCH INSTALLATION DETAIL NOT TO SCALE

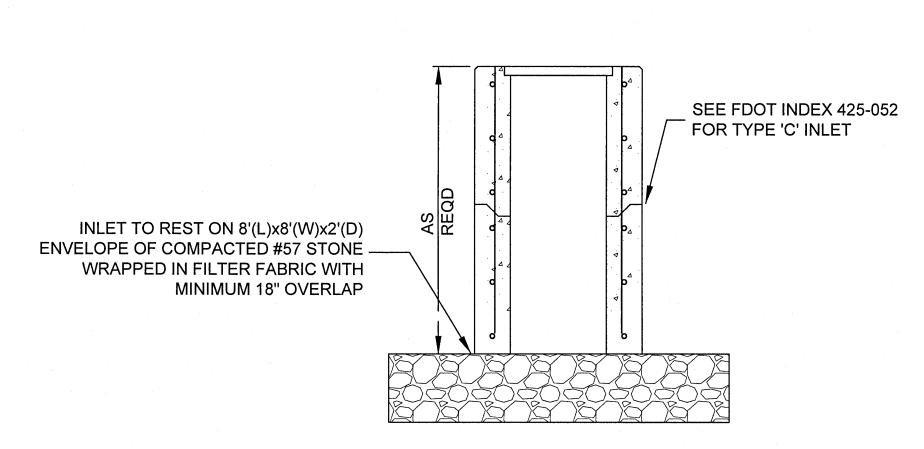

BOTTOMLESS CONCRETE INLET NOT TO SCALE

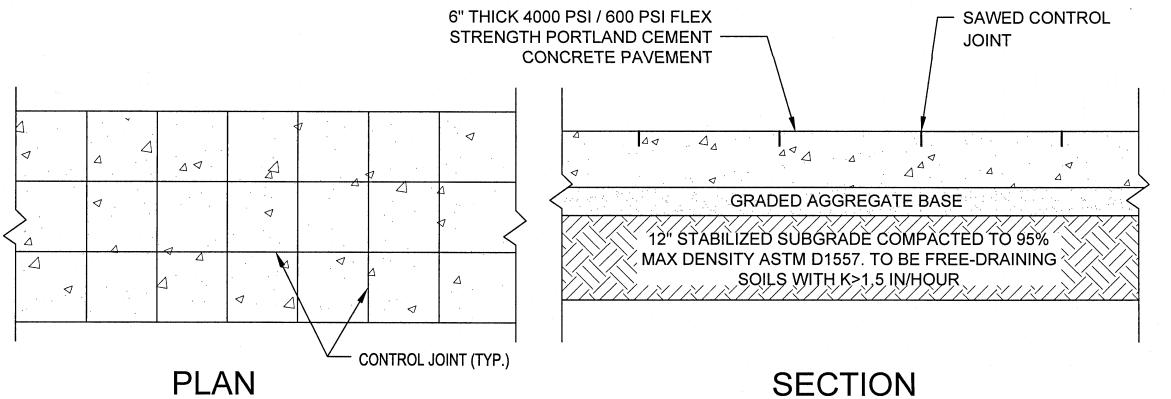


PAVING SECTION SUMMARY 6.0"

CONCRETE CONTROL JOINT SPACING 12'x12' CONTROL JOINT DEPTH 2.0" GRADED AGGREGATE BASE 4.0" STABILIZED SUBGRADE 12.0"


- LONGITUDINAL AND TRANSVERSE JOINTS SHALL BE SAWED AS INDICATED. 2. THE JOINT SEAL MANUFACTURER'S SPECIFICATIONS SHALL BE COMPATIBLE WITH THE JOINT CONFIGURATION. PROVIDE TYPICAL DETAILS FOR CONSTRUCTION & EXP. JTS.
- FOR ALL JOINTS THE BACKER ROD MATERIAL SHALL BE COMPATIBLE WITH THE COLD POURED SEALANT AND SLIGHTLY OVERSIZED TO PREVENT MOVEMENT DURING THE JOINT SEALANT OPERATION.
- 4. THE WIDTH OF ALL JOINTS SHALL BE CORRECTED FOR 68 DEGREE F.
- EXPANSION JOINTS SHALL BE USED AT ALL LOCATIONS WHERE PAVEMENT ABUTS A PERMANENT STRUCTURE.

CONCRETE PAVEMENT SECTION NOT TO SCALE

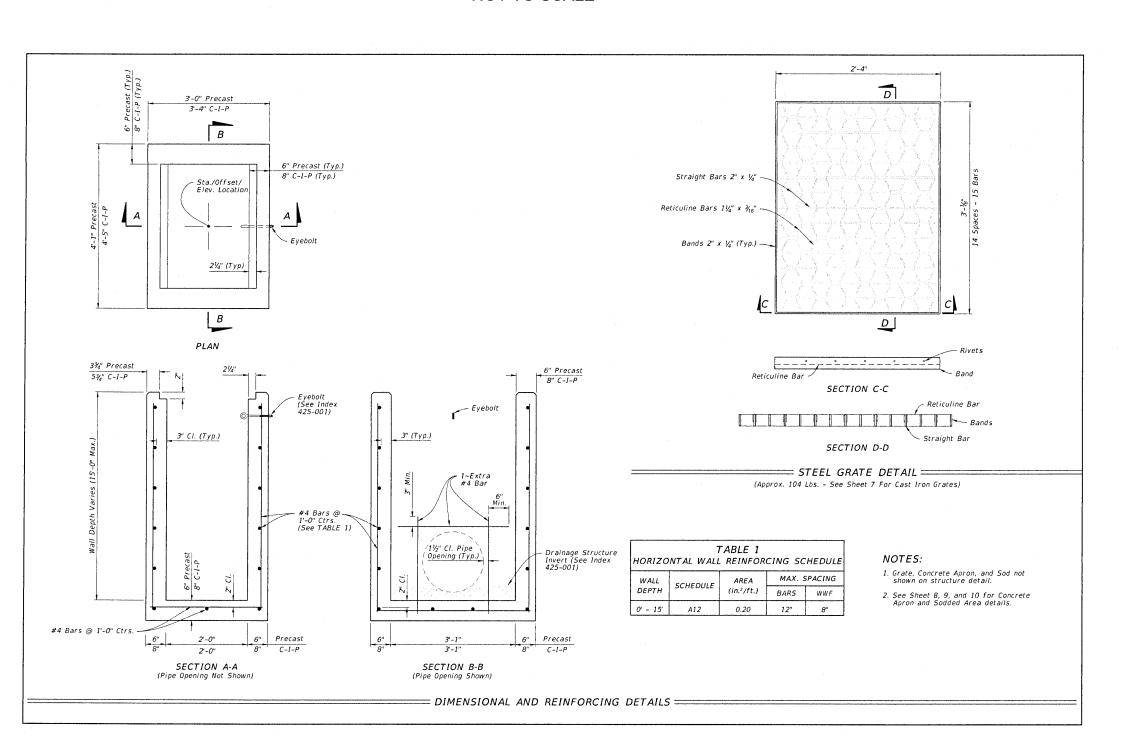

FDOT INDEX 425-052 TYPE 'C' INLET NOT TO SCALE

 \Box

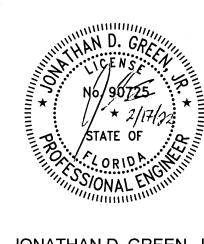

JONATHAN D. GREEN, JR P.E. 90725

DATE: REV#:

DESIGNED BY:

JOB NO.: 22008

DATE: 2022-02-16

SCALE: AS SHOWN

STATUS: PERMIT SET

SHEET NO .: